
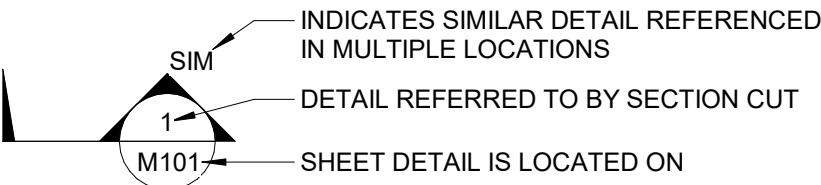


1 EXISTING AHU DETAIL

NO SCALE

VIEW KEY

- NAME → LEVEL NAME
10'-0" → HEIGHT ABOVE PROJECT 0'-0"
- 1 → KEYNOTE: INDICATES NOTE USED TO DESCRIBE ADDITIONAL INFORMATION ABOUT WORK REQUIRED, SPECIFIC TO THE SHEET AND/OR DETAIL

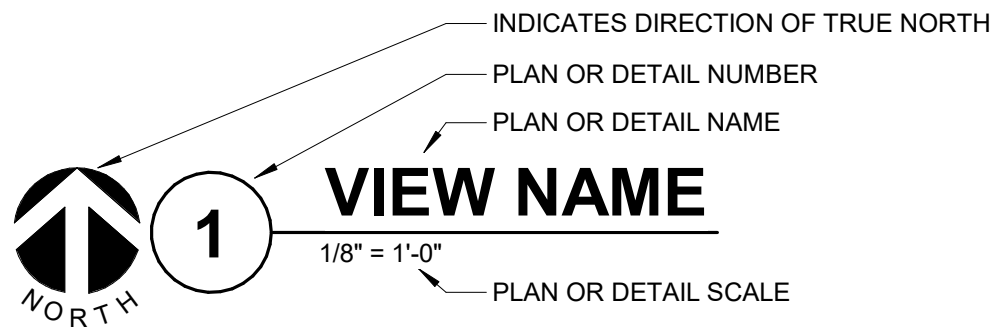

- LINE TYPE AND TAG KEY:
- NEW WORK BY THIS CONTRACTOR (WIDE LINE)
NEW
----- EXISTING TO BE REMOVED (SHORT DASHED PATTERN)
- EXISTING TO REMAIN OR WORK BY OTHERS (NARROW LINE)
----- EXISTING
----- EXISTING TO BE REMOVED BY OTHERS (SHORT DASHED PATTERN)
- HALFTONING DOES NOT MODIFY SCOPE.
- TAG-E TAGS WITH DASH 'E' INDICATES THE REFERENCED OBJECT IS EXISTING
- TAG-1 UNDERLINED TAG INDICATES OBJECT IS IN-SCOPE. IF NEW, ADDITIONAL INFORMATION IS AVAILABLE IN A SCHEDULE, MATERIAL LIST, OR SYMBOL LIST
- INDICATES AN EXISTING SYSTEM'S POINT OF CONNECTION/REMOVAL

APPLICABLE CODES

CONTRACTOR SHALL COMPLY WITH APPLICABLE CODES AND LOCAL AMENDMENTS INCLUDING, BUT NOT LIMITED TO, THE FOLLOWING:	
FIRE CODE:	NFPA: 13 2022 EDITION
PLUMBING CODE:	IPC 2023
MECHANICAL CODE:	IMC 2023
ELECTRICAL CODE:	NFPA 70 (NEC) 2023 EDITION
LOCAL BUILDING CODE:	CURRENT EDITION

CONTRACTOR ABBREVIATION KEY

ABBR:	DESCRIPTION:
E.C.	ELECTRICAL CONTRACTOR
F.P.C.	FIRE PROTECTION CONTRACTOR
M.C.	MECHANICAL CONTRACTOR
P.C.	PLUMBING CONTRACTOR

MECHANICAL SYMBOL LIST

SYMBOL:	DESCRIPTION:
CW	COLD WATER
G	NATURAL GAS
DUCT DOWN	DUCT DOWN
DUCT UP	DUCT UP
SUPPLY/OUTSIDE AIR DUCT SECTION	SUPPLY/OUTSIDE AIR DUCT SECTION

MECHANICAL RENOVATION NOTES:

THESE NOTES APPLY TO ALL MECHANICAL SHEETS AND TRADES, INCLUDING BUT NOT LIMITED TO VENTILATION, PIPING.

- EXISTING CONDITIONS ARE SHOWN BASED ON INFORMATION OBTAINED FROM FIELD SURVEYS, EXISTING BUILDING DOCUMENTS, AND STAFF. VERIFY EXISTING CONDITIONS AND REPORT ANY CONFLICTS BEFORE PROCEEDING.
- NOT ALL EXISTING DUCTWORK AND PIPING IS SHOWN. VERIFY EXISTING CONDITIONS BEFORE STARTING WORK. NOTIFY ENGINEER OF ANY CONFLICTS WITH NEW WORK.
- FIELD VERIFY THE AVAILABLE CLEARANCES FOR DUCTWORK AND PIPING BEFORE FABRICATION. RISES AND DROPS MAY BE NECESSARY BECAUSE OF EXISTING FIELD CONDITIONS.
- EACH CONTRACTOR SHALL FIELD VERIFY ACCESSIBILITY TO THE AREA OF THEIR WORK AND SHALL NOTIFY THE GENERAL CONTRACTOR PRIOR TO BIDDING IF OTHER UTILITIES ARE REQUIRED TO BE REMOVED OR RELOCATED TO ALLOW ACCESS TO THEIR AREA OF WORK.
- WHERE EXISTING MECHANICAL SYSTEMS ARE LOCATED IN AREAS THAT CONFLICT WITH NEW EQUIPMENT, PIPING, OR DUCTWORK TO BE INSTALLED, EACH CONTRACTOR SHALL EITHER ARRANGE NEW EQUIPMENT, PIPING, OR DUCTWORK IN SUCH A FASHION THAT IT DOES NOT CONFLICT WITH EXISTING SYSTEMS, OR REWORK EXISTING MECHANICAL SYSTEMS TO ALLOW FOR INSTALLATION OF NEW EQUIPMENT, PIPING, OR DUCTWORK.
- PROVIDE TEMPORARY CONNECTIONS TO MAINTAIN EXISTING SYSTEMS IN SERVICE DURING CONSTRUCTION. MAINTAIN ACCESS TO EXISTING MECHANICAL INSTALLATIONS THAT REMAIN ACTIVE.
- OBTAIN PERMISSION FROM OWNER BEFORE SHUTTING DOWN ANY SYSTEM FOR ANY REASON. MAINTAIN SERVICE TO ALL COMPONENTS THAT ARE TO REMAIN UNTIL NEW SYSTEMS ARE INSTALLED.
- MAINTAIN EXISTING SYSTEM IN SERVICE UNTIL NEW SYSTEM IS COMPLETE AND READY FOR TIE IN AND SWITCHOVER. DRAIN SYSTEM ONLY TO MAKE SWITCHOVERS AND CONNECTIONS. OBTAIN PERMISSION FROM OWNER BEFORE PARTIALLY OR COMPLETELY DRAINING SYSTEM. MAKE CHANGEOVER TO NEW SYSTEMS WITH MINIMUM OUTAGE.
- DISCONNECT AND REMOVE MECHANICAL DEVICES AND EQUIPMENT SERVING EQUIPMENT THAT HAS BEEN REMOVED.

MECHANICAL GENERAL NOTES:

THESE NOTES APPLY TO ALL MECHANICAL SHEETS AND TRADES, INCLUDING BUT NOT LIMITED TO VENTILATION, PIPING.

- DRAWINGS SHOWING LOCATIONS OF EQUIPMENT, DUCTWORK, PIPING, ETC. ARE DIAGRAMMATIC AND MAY NOT ALWAYS REFLECT EXACT INSTALLATION CONDITIONS. DRAWINGS SHOW THE GENERAL ARRANGEMENT OF DUCTWORK, PIPING, EQUIPMENT, ETC., AND MAY NOT INCLUDE ALL OFFSETS AND FITTINGS REQUIRED FOR COMPLETE INSTALLATION. THE DRAWINGS SHALL BE FOLLOWED AS CLOSELY AS ACTUAL BUILDING CONSTRUCTION AND THE WORK OF OTHERS WILL PERMIT.
- DETERMINATION OF QUANTITIES OF MATERIAL AND EQUIPMENT REQUIRED SHALL BE MADE BY THE CONTRACTOR FROM THE DOCUMENTS, WHERE MATERIAL AND/OR QUANTITY DISCREPANCIES ARISE BETWEEN DRAWINGS, SCHEDULES AND/OR SPECIFICATIONS, THE HIGHER QUALITY/GREATER NUMBER SHALL GOVERN.
- DO NOT SCALE DRAWINGS. VERIFY ALL DIMENSIONS AND CLEARANCES FROM ARCHITECTURAL, STRUCTURAL, SUBMITTALS, AND OTHER APPROPRIATE DRAWINGS OR PHYSICALLY AT SITE. REVIEW ALL DRAWINGS, INCLUDING THOSE OF OTHER TRADES.
- COORDINATE ALL WORK WITH ALL OTHER TRADES PRIOR TO INSTALLATION TO PROVIDE CLEARANCES REQUIRED FOR OPERATION, MAINTENANCE, CODE COMPLIANCE, AND TO VERIFY NON-INTERFERENCE WITH OTHER WORK. DO NOT FABRICATE PRIOR TO VERIFICATION OF NECESSARY CLEARANCES FOR ALL TRADES. BRING ANY INTERFERENCES OR CONFLICTS TO THE ATTENTION OF THE ARCHITECT/ENGINEER BEFORE PROCEEDING WITH FABRICATION OR EQUIPMENT ORDERS.
- REVIEW SPACE REQUIREMENTS OF EQUIPMENT SPECIFIED OR SUBSTITUTED AND MAKE REASONABLE ACCOMMODATIONS IN LAYOUT AND POSITIONING TO PROVIDE PROPER ACCESS.
- ANY CHANGES REQUIRED TO ELIMINATE CONFLICTS OR THAT RESULT FROM A FAILURE TO COORDINATE SHALL BE MADE BY THE CONTRACTOR WITHOUT ADDITIONAL COST OR EXPENSE TO OTHERS.
- EACH CONTRACTOR IS RESPONSIBLE FOR ALL COSTS ASSOCIATED WITH ELECTRICAL CHANGES REQUIRED FOR EQUIPMENT PROPOSED THAT DIFFERS FROM THE BASIS OF DESIGN.
- EACH CONTRACTOR IS RESPONSIBLE FOR DAMAGE CAUSED BY THEIR ACTIONS TO WALLS, FLOORS, CEILINGS, AND ROOFS. THE CONTRACTOR WHOSE WORK CAUSES DAMAGE IS RESPONSIBLE FOR PATCHING TO MATCH ORIGINAL CONSTRUCTION, FIRE RATING, AND FINISH.
- EQUIPMENT SIZES AND SERVICE CLEARANCE REQUIREMENTS VARY AMONG DIFFERENT MANUFACTURERS. CONSULT APPROVED SHOP DRAWINGS FOR EQUIPMENT SIZES AND REQUIRED SERVICE CLEARANCES. COORDINATE WITH LAYOUT OF EQUIPMENT PADS, PIPING, DUCTWORK, ETC.
- DO NOT BLOCK TUBE PULL OR EQUIPMENT SERVICE CLEARANCES.
- MAINTAIN A MINIMUM WORKING CLEARANCE OF 3'-6" IN FRONT OF ALL ELECTRICAL EQUIPMENT REQUIRING MAINTENANCE, INSPECTION, AND TESTING INCLUDING BUT NOT LIMITED TO PANELS, DISTRIBUTION PANELS, SWITCHBOARDS, MOTOR CONTROL CENTERS, TRANSFORMERS, EQUIPMENT DISCONNECTS AND STARTERS.
- MAINTAIN THE DEDICATED ELECTRICAL EQUIPMENT SPACE DEFINED BY THE WIDTH/ DEPTH OF ELECTRICAL EQUIPMENT MEASURED FROM THE FLOOR TO A HEIGHT 6'-0" ABOVE THE EQUIPMENT OR THE STRUCTURAL CEILING, WHICHEVER IS LOWER. SYSTEMS FOREIGN TO THE ELECTRICAL DISTRIBUTION SYSTEM ARE NOT ALLOWED IN THE DEDICATED ELECTRICAL SPACE INCLUDING: DUCTWORK, PIPING, ETC.
- DO NOT EXCEED 25 LBS PER HANGER AND A MINIMUM SPACING OF 2'-0" ON CENTER WHEN ATTACHING TO METAL ROOF DECKING (LIMITATION NOT REQUIRED WITH CONCRETE ON METAL DECK). THIS 25 LBS. LOAD AND 2'-0" SPACING INCLUDE ADJACENT ELECTRICAL AND ARCHITECTURAL ITEMS HANGING FROM DECK. IF THE HANGER RESTRICTIONS CANNOT BE ACHIEVED, SUPPLEMENTAL FRAMING OFF STEEL FRAMING SHALL BE ADDED. ANCHORS EMBEDDED IN CONCRETE SHALL BE CRACKED CONCRETE APPROVED IN ACCORDANCE WITH SPECIFICATIONS.

MECHANICAL SHEET INDEX

M.1-000	MECHANICAL COVERSHEET
MD.1-100	PENTHOUSE - MECHAICAL - DEMO
M.1-100	PENTHOUSE - VENTILATION
GRAND TOTAL: 3	

HEAT RECOVERY WHEEL SCHEDULE

NOTES:
1 THE WHEEL SHALL HAVE A 3 ANGSTORM DESICCANT COATING.

TAG NAME	AREA SERVED	OA CFM	EA CFM	SUMMER CONDITIONS								WINTER CONDITIONS								MAXIMUM VELOCITY (FPM)	MAXIMUM AIR PRESSURE DROP (IN W.C.)	WHEEL WIDTHxHEIGHT	ELECTRICAL			STARTER TYPE (NOTE 1)	MANUFACTURER	NOTES		
				OA TEMP		RA TEMP		TEMPERED AIR TEMP				OA TEMP		RA TEMP		TEMPERED AIR TEMP							HEAT RECOVERED MBH	TOTAL EFFECTIVENESS	MOTOR (HP)				VOLTAGE	PHASES
				°F DB	°F WB	°F DB	°F WB	°F DB	°F WB	°F DB	°F WB	°F DB	°F WB	°F DB	°F WB	°F DB	°F WB	°F DB	°F WB											
HRW-1	AHU-1	30240	33550	95.0	78.0	75.0	63.0	80.3	67.3	1414	-10.0	-9.0	70.0	45.0	53.0	36.0	1988	77.8/78.4	661/733	0.71/0.81	142"x142"	750	120	1	T.C.C.	SEMCO	NOTE 1			
HRW-2	AHU-1	30240	33550	95.0	78.0	75.0	63.0	80.3	67.3	1414	-10.0	-9.0	70.0	45.0	53.0	36.0	1988	77.8/78.4	661/733	0.71/0.81	142"x142"	750	120	1	T.C.C.	SEMCO	NOTE 1			

FIRE SPRINKLER USAGE SCHEDULE


- NOTES:
- SEE FLOOR PLANS FOR ZONING REQUIREMENTS.
 - SPRINKLER SHALL HAVE COLOR CODED BULB THERMAL ELEMENT.
 - ALL SPRINKLERS SHALL BE UL LISTED.
 - CONTRACTOR TO VERIFY SPRINKLER REQUIREMENTS BASED ON ACTUAL INSTALLATION, USAGE, ARCHITECTURAL CEILING PLAN AND NFPA 13 REQUIREMENTS.
 - TAG NAME IS PRIMARILY FOR IDENTIFYING SPRINKLERS IN SUBMITTALS. IT MAY OR MAY NOT BE FOUND ELSEWHERE ON THE DRAWINGS. CONTRACTOR TO SUBMIT ALL SPRINKLER TYPES TO BE USED.
 - AREAS ARE GENERAL IN NATURE. CONTRACTOR TO MATCH UNSCHEDULED AREAS TO SIMILAR SPACES.
 - SPRINKLERS SHALL HAVE A 3mm QUICK RESPONSE BULB.
 - SPRINKLERS SPECIFIED WITHIN FIRE SPRINKLER USAGE SCHEDULE ARE STANDARD COVERAGE TYPE. EXTENDED COVERAGE SPRINKLERS ARE PERMITTED PROVIDED SPRINKLERS MEET THE REQUIREMENTS OF UL.

AREA TYPE (NOTE 1 & 9)	AREA HAZARD	TAG NAME (NOTE 4 & 9)	SPRINKLER		FINISH	TEMPERATURE RATING	MANUFACTURER & MODEL	NOTES
			SPRINKLER TYPE	RESPONSE CATEGORY				
MECHANICAL PENTHOUSE	SEE PLANS	SPR-1	UPRIGHT	QUICK	ROUGH BRASS	(155), (175), (200), (286), (PER NFPA)	VIKING VK, RELIABLE F1FR, TYCO TY-FRB, VICTAULIC V2704	NOTE 2, 3, 7 & 8

ERW Replacement

1215 Houbolt Road
Joliet, IL 60431

Joliet Junior College

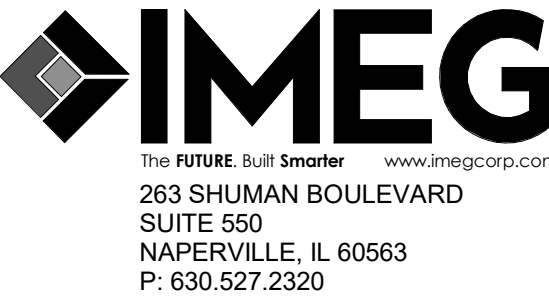

PROFESSIONAL SEAL


KEY PLAN

AGENCY APPROVAL

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REVISIONS

No. Date Revision / Issue

SHEET INFORMATION

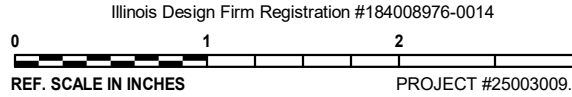Issue: **BID SET**
Date: **08/01/2025**
Project #: **25003009.00**
Drawn: **DVE**
Checked: **BLH**
Approved: **BLH**

SHEET TITLE

MECHANICAL COVERSHEET


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SHEET NUMBER


M.1-000

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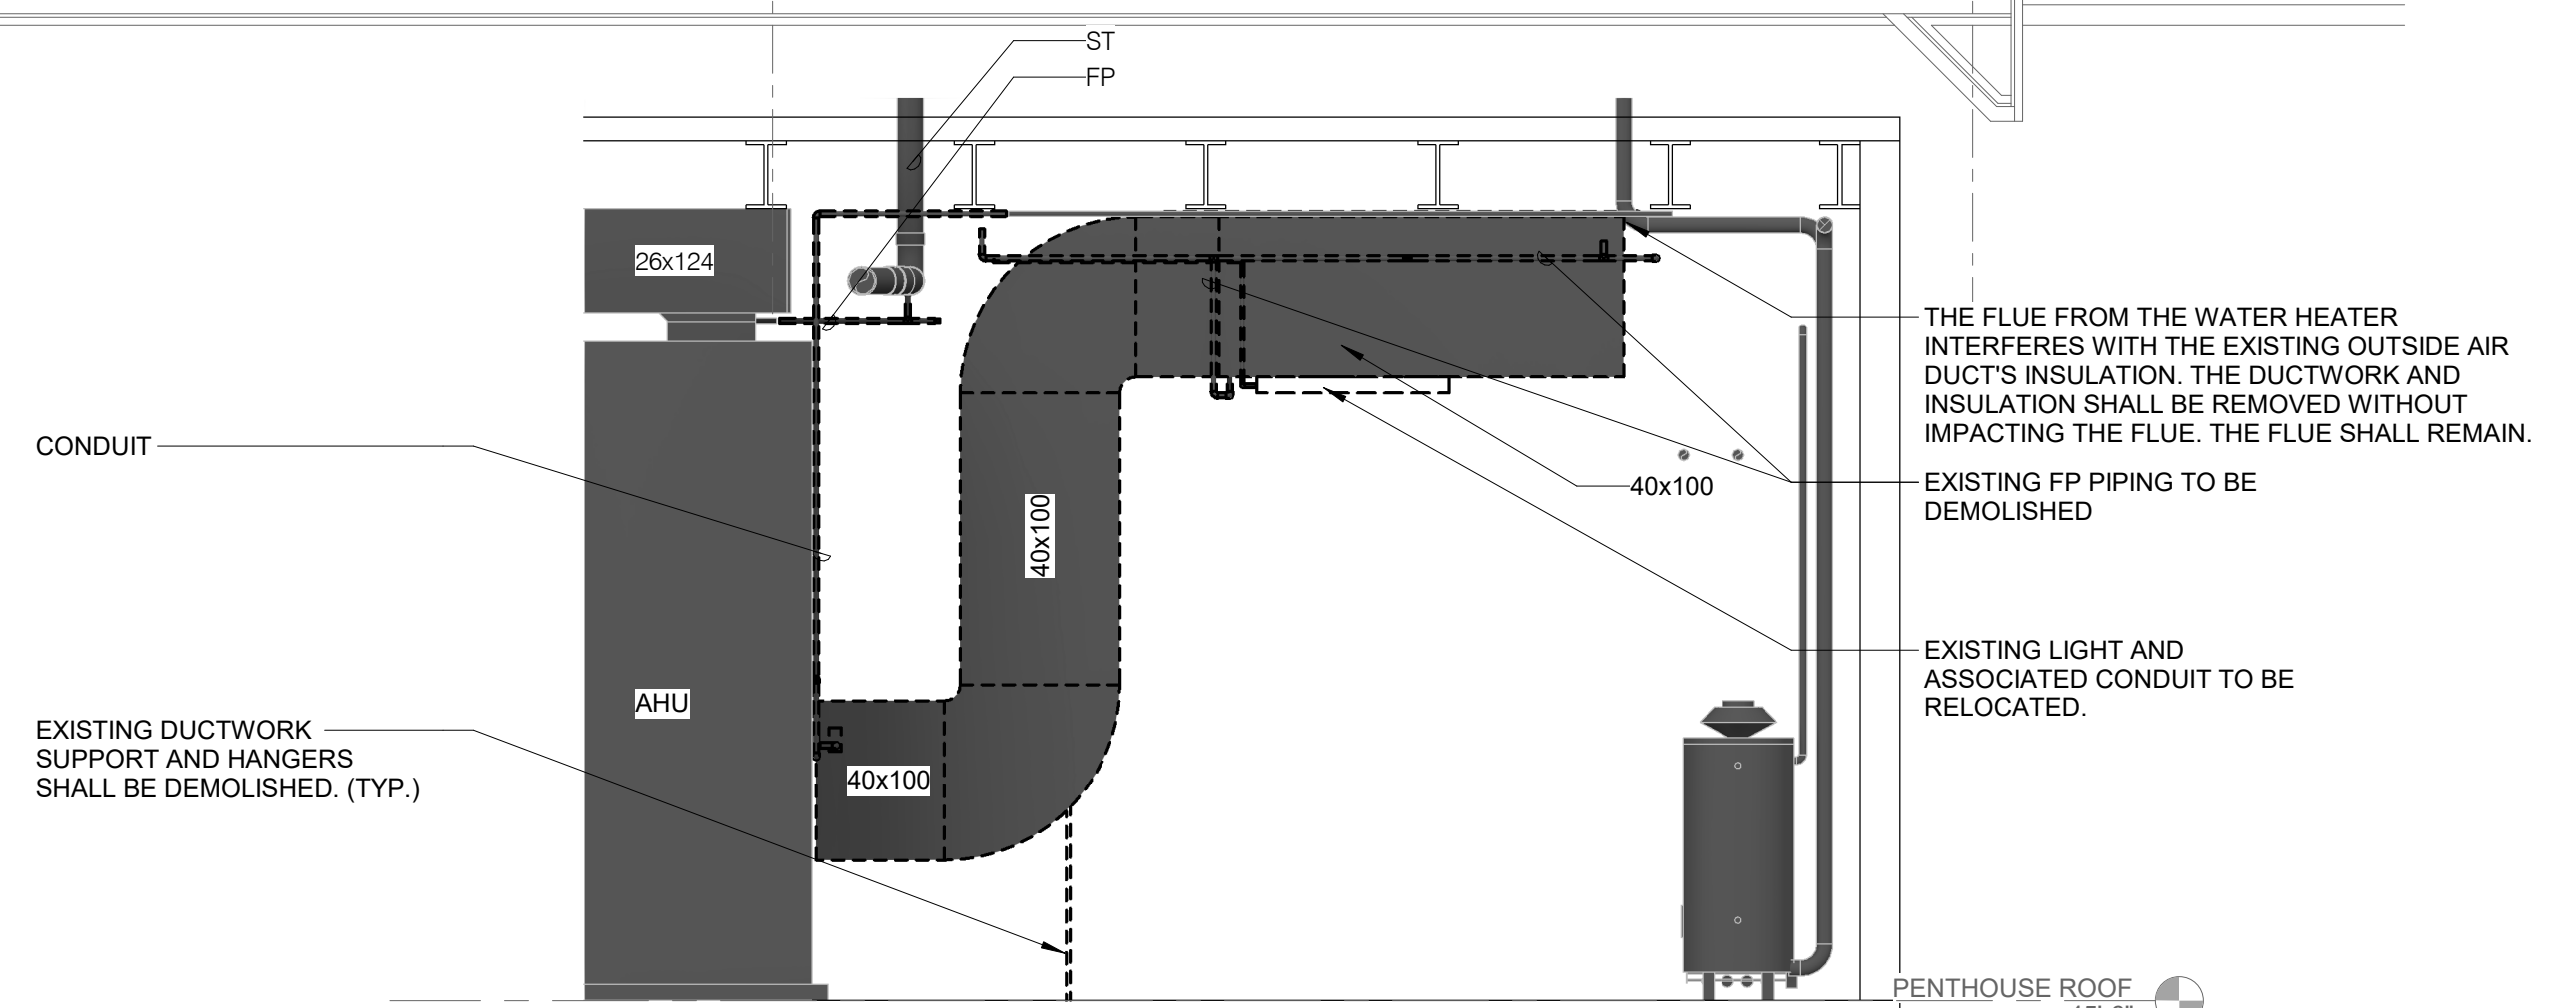


SHEET NOTES:
1. ALL CONDUIT AND PIPING NOT SHOWN TO BE DEMOLISHED SHALL REMAIN. CONTACT ENGINEER IF CONFLICT ARISES.

4 NORTH DUCTWORK SECTION - DEMO
NO SCALE

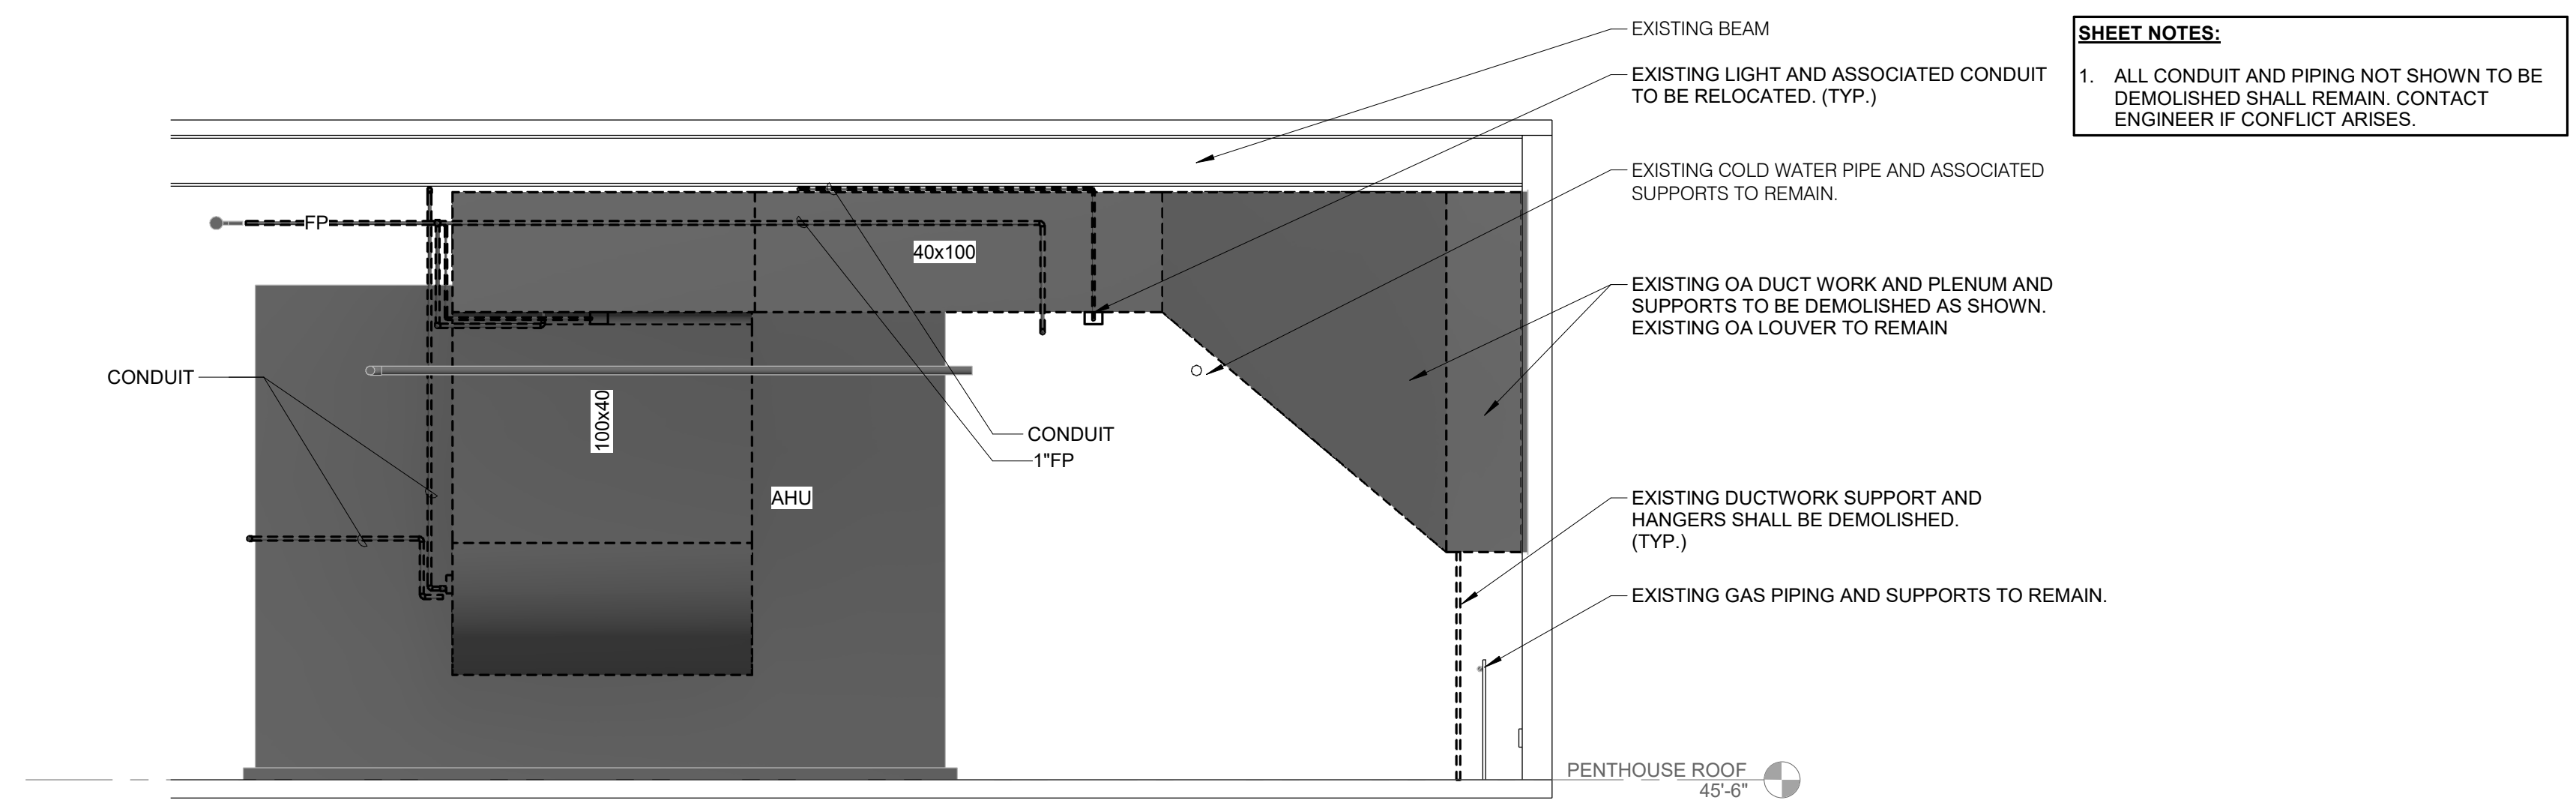

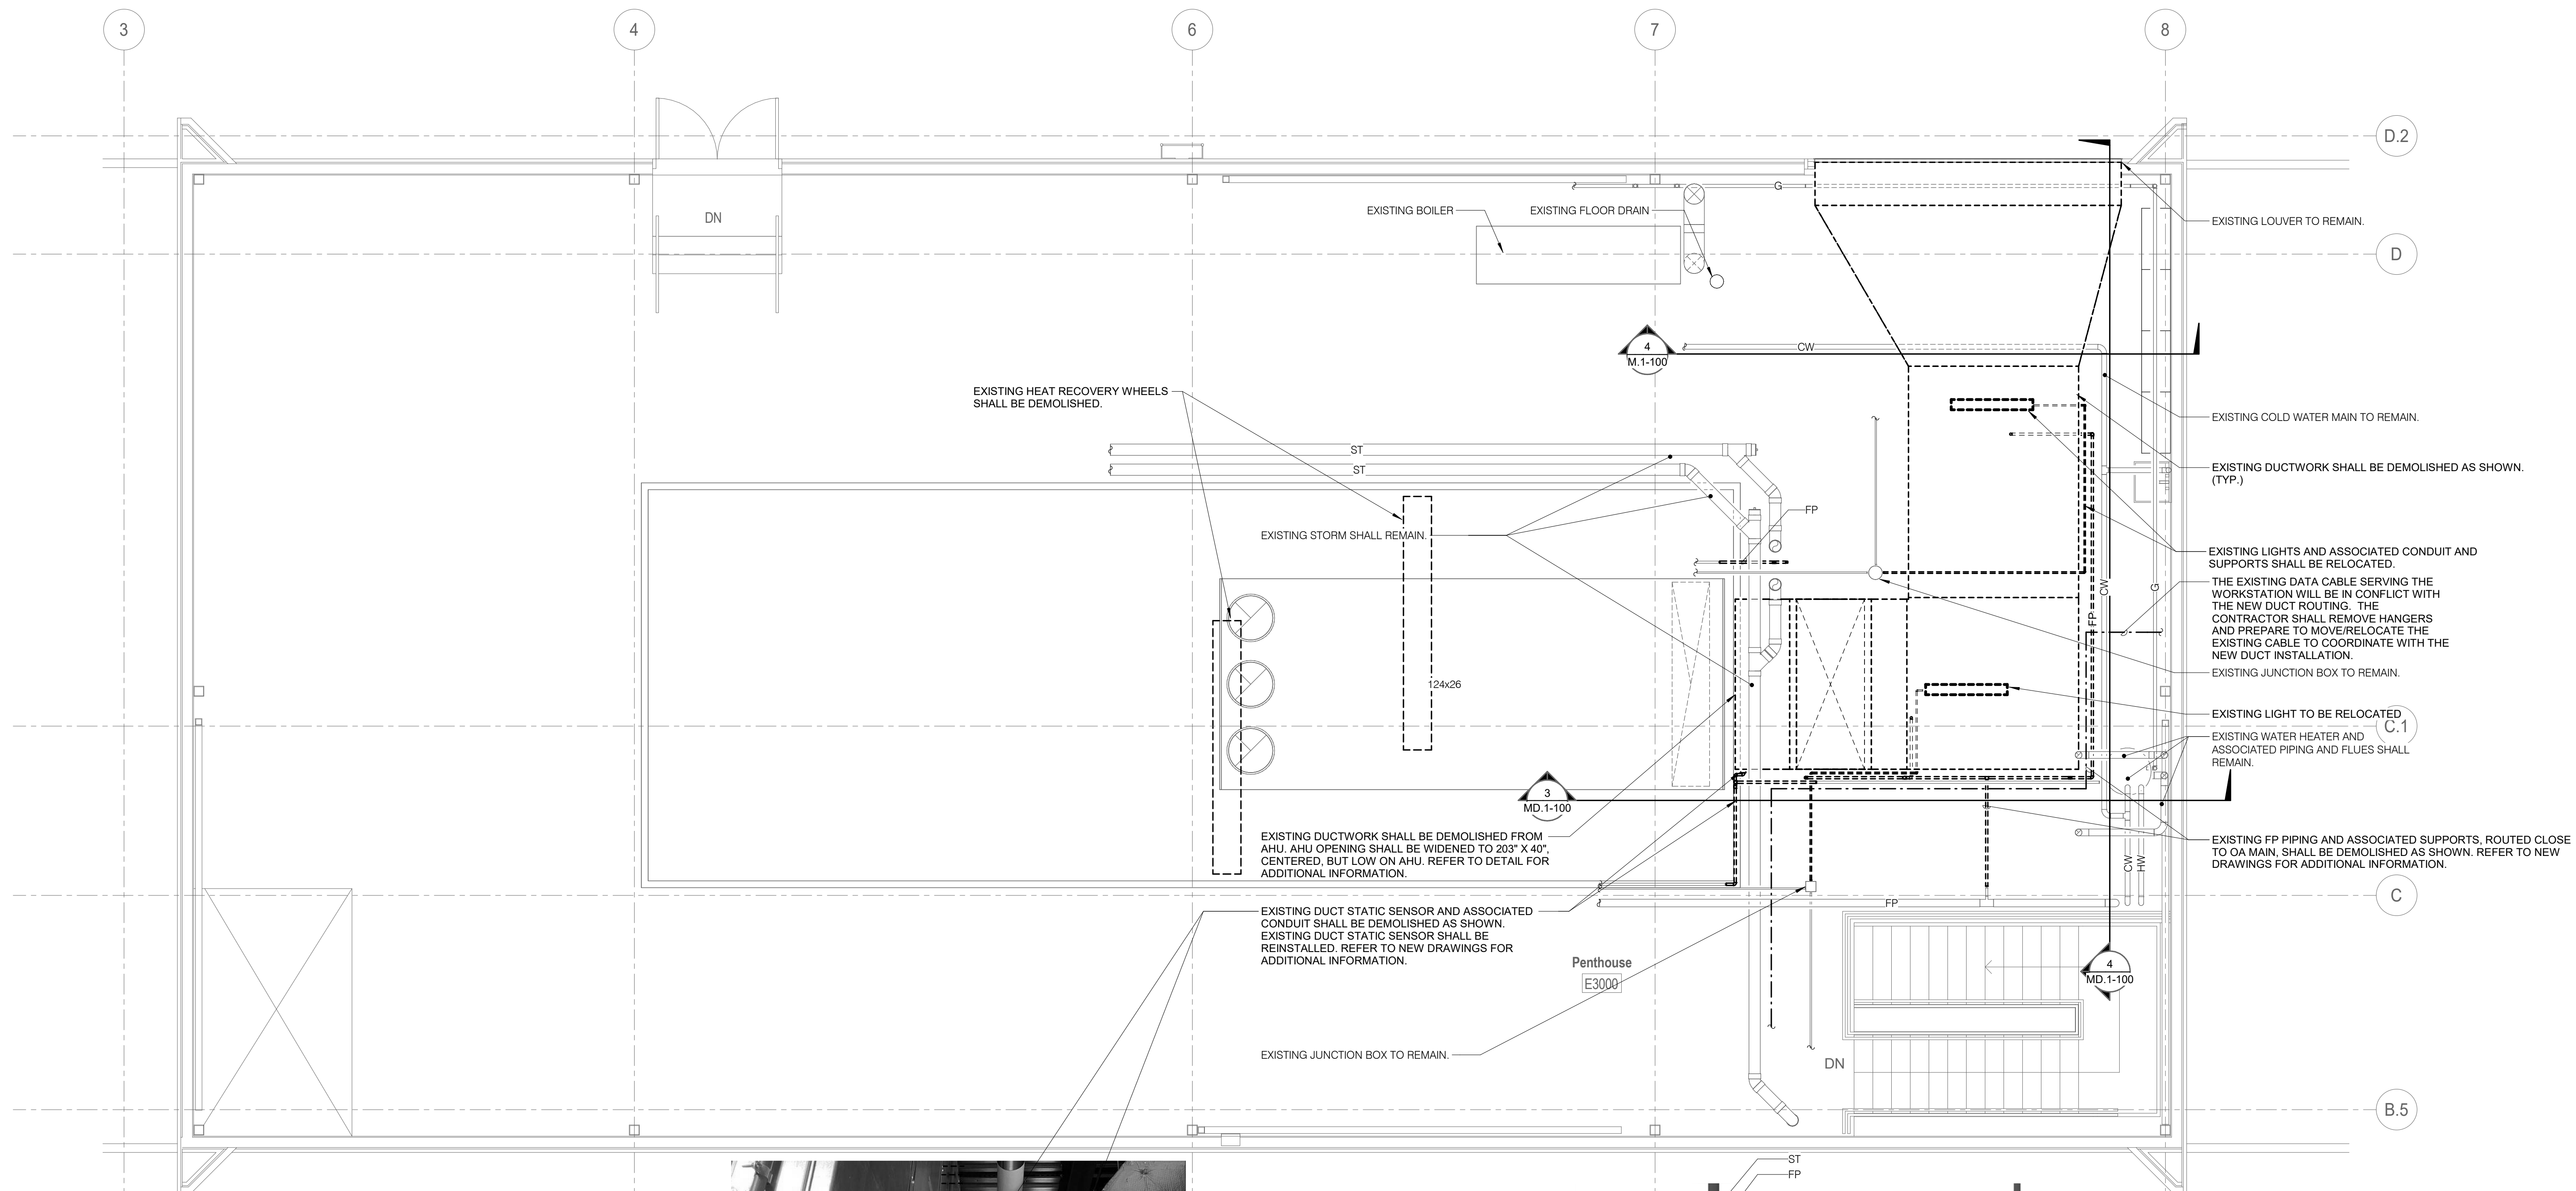1 PENTHOUSE - VENTILATION - DEMO
1/4" = 1'-0"



3 EAST DUTWORK SECTION - DEMO
NO SCALE

ERW Replacement

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REF. SCALE IN INCHES PROJECT #25003009.00

REVISIONS

No. Date Revision / Issue

SHEET INFORMATION

Issue **BID SET**
Date **08/01/2025**
Project # **25003009.00**
Drawn **DVE**
Checked **BLH**
Approved **BLH**

SHEET TITLE

PENTHOUSE - MECHAICAL - DEMO


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Scale: **1/4" = 1'-0"**

SHEET NUMBER

MD.1-100


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SHEET INFORMATION

Issue **BID SET**

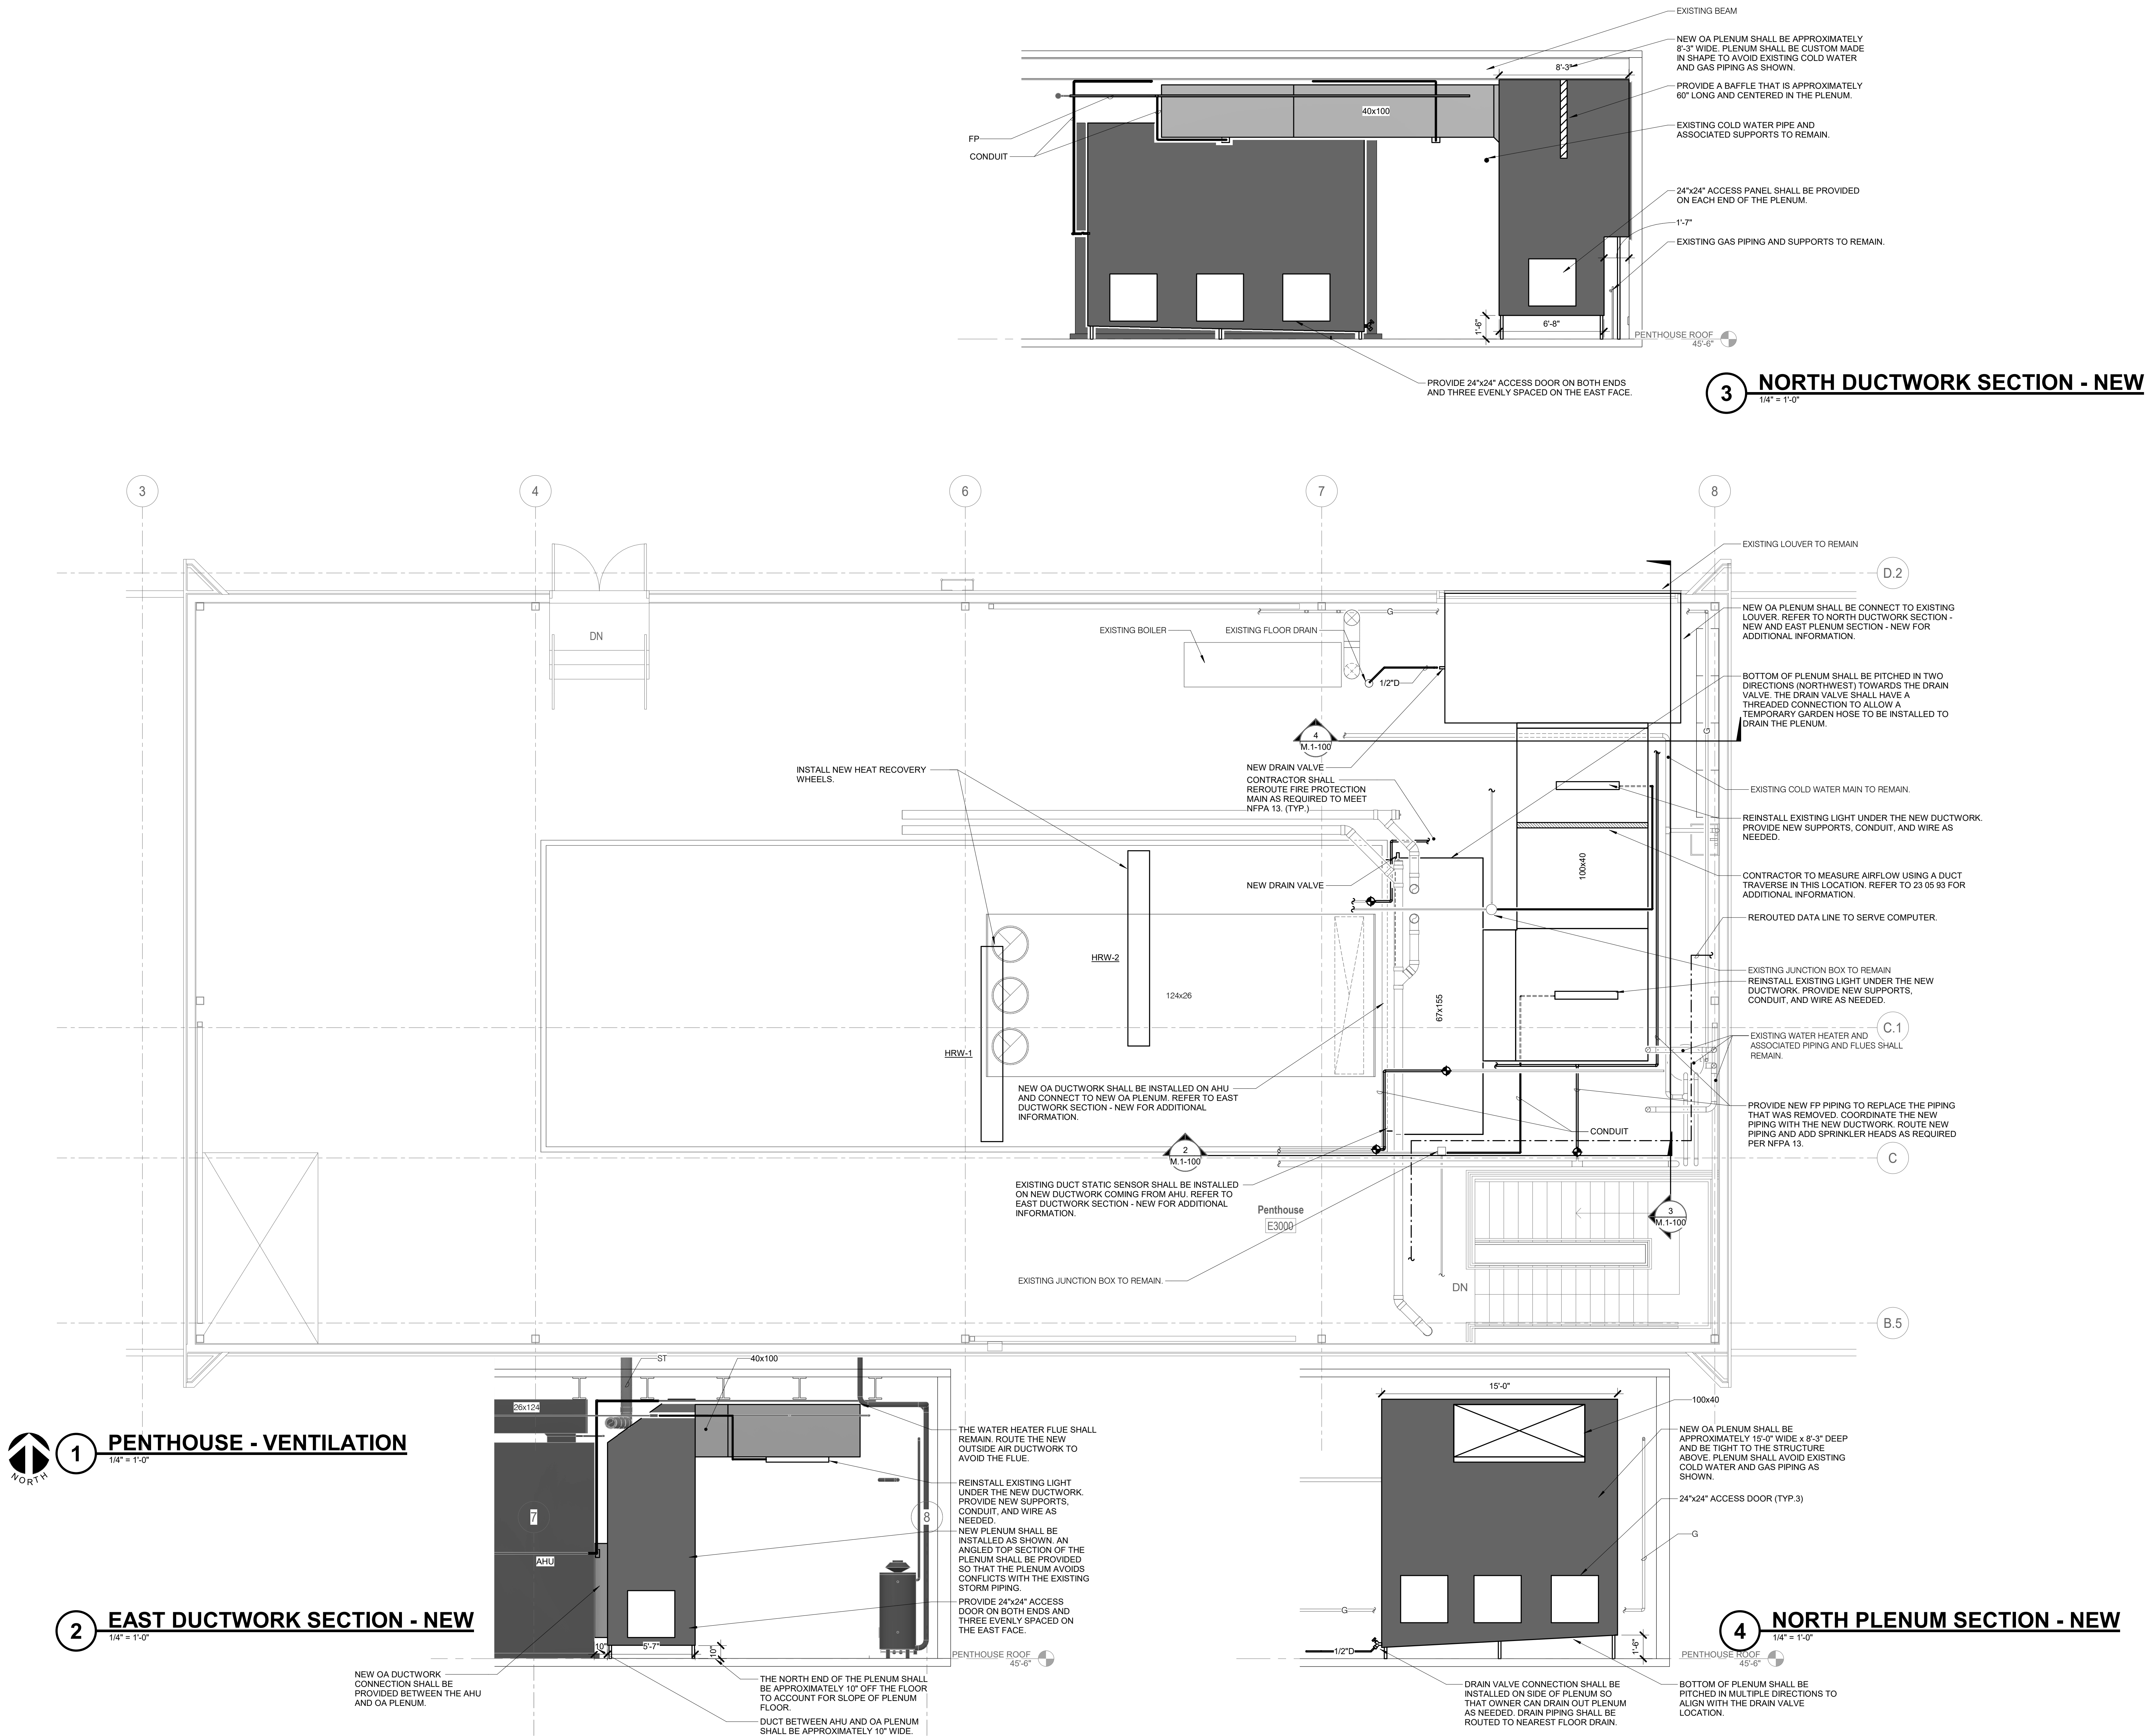Date **08/01/2025**

Project # **25003009.00**

Drawn **DVE**

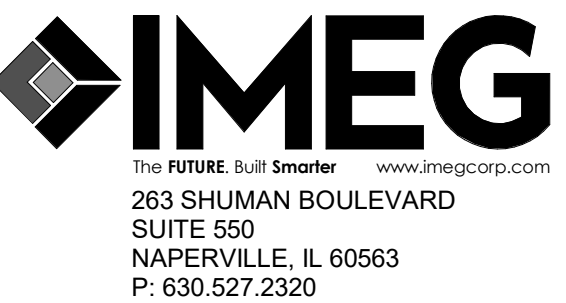Checked **BLH**

Approved **BLH**

SHEET TITLE

PENTHOUSE - VENTILATION

SCALE

Scale: **1/4" = 1'-0"**

SHEET NUMBER

M.1-100