



Respiratory Therapy

Joliet Junior College

Issued For: BID Issued Date: 11-30-2020 ESA Project #: **19130**Client Project #:

MEP/AV Affiliated Engineers, Inc. (AEI)

312-977-2800

Structural

Chicago, IL 312-859-5246

93




1215 Houbolt Rd, Joliet, IL 60431

10 S. LaSalle Street, Suite 2700, Chicago, IL 60603

FIRE STO	PING			A	BREVIATIONS			SYMBOL	LEGEND	
	ED ARE FOR SHOV	VN FOR DESIGN BAS	BIS AND	AC AC/FL	AIR CONDITIONING ACCESS FLOOR	MB MO	METAL BASE MASONRY OPENING	DESCRIPTION	<u>GRAPHIC</u>	
		R MUST SUBMIT AND YSTEM BASED ON A		ACT AD	ACOUSTICAL CEILING TILE AREA DRAIN	MACH MAX	MACHINE MAXIMUM	DRAWING TITLE	00 View Name	
CONDITIONS. 3. REFER TO PROJEC	CT MANUAL SECTIO	ON 07 8400 AND MEP		ADJ AFF ALUN	ADJUSTABLE ABOVE FINISHED FLOOR 1 ALUMINUM	MDF MECH MED	MEDIUM DENSITY FIBERBOARD MECHANICAL MEDIUM			- DEPARTMENT
	1AY BE USED IN 1 H	HOUR RATED WALL - N FOR ADDITIONAL L			ALTERNATE ANODIZED	MEZZ MFR	MEZZANINE MANUFACTURER	ROOM NAME AND NUMBER	ROOM NAME	
					ANTENNA APPROVED ARCHITECT	MIN MISC MTD	MINIMUM MISCELLANEOUS MOUNTED		101	 ROOM NUMBER ROOM SF
BASIS OF				BG	BUMPER GUARD	MTG MTL	MOUNTING METAL		/	- FIRE RATING
					BENCH MARK V BETWEEN BITUMINOUS	MULL MWK			P45 Min	 KEYED HARDWARE DOOR NUMBER
FOR THRO	JUGHP	'ENETR/	AHONS	BIT BLDG BLK	BITUMINOUS BUILDING BLOCK	NF NIC	NO FINISH NOT IN CONTRACT	DOOR TAG	00-000 000000 0.0 EU	 HARDWARE SET EXIT UNITS
DESCRIPTION	CONC FLOOR BLOCK WALL	GYP BD WALL	GYP BD SHAFT WALL	BLKG BM	BLOCKING BEAM	NO NOM	NUMBER NOMINAL			— DOOR STYLE
BLANK OPENING	CAJ-0090 (2hr)	WL-0012 (2hr)		BT BRG BRK	BOTTOM BEARING BRICK	NRC NTS	NOISE REDUCTION COEFFICIENT NOT TO SCALE		45 Min	 FIRE RATING WINDOW NUMBER
	FA-0014 (3hr)	WL-0040 (2hr)		BSMT	BASEMENT	OC OA	ON CENTER OVERALL	WINDOW TAG		— GLAZING TYPE
1ETAL PIPE	CAJ-1226 (3hr) FA-1016 (2hr)	WL-1054 (2hr) WL-1297 (2hr)	WL-1205 (2hr) WL-1380 (2hr)	CA CB CC	CABINET CARPET BASE CUBICLE CURTAIN	OH OFF	OVERHEAD OFFICE OPENING	CURTAIN WALL	000	— WINDOW STYLE
PLASTIC PIPE	CAJ-2109 (3hr) FA-2054 (2hr)	WL-2078 (2hr) WL-2128 (2hr)		CF CG	CONCRETE FLOOR CORNER GUARD	OPG OPP ORN	OPENING OPPOSITE ORNAMENTAL	PANEL TAG		
SULATED PLASTIC PIPE		WL-2128 (2111) WL-5225 (2hr)		CL CR	CENTER LINE CHAIR RAIL	PC	PRECAST CONCRETE	WALL TAG	<u>00</u>	
	· · · · ·			CFB CLG CLO	CONCRETE FLOOR BASE CEILING CLOSET	PL PERF PH	PLASTIC LAMINATE PERFORATED PHASE	CEILING ELEVATION	(00'-00")	
ABLE BUNDLE	CAJ-3095 (3hr) FA-3281 (2hr)	WL-3065 (2hr) WL-3334 (4hr)	WL-3161 (2hr)	CLR CMU	CLEAR CONCRETE MASONRY UNIT	PLAS PLMG	PLASTIC PLUMBING	SHEET NOTE	0	
	FA-3007 (3hr)	WL-3384 (2hr)			COLUMN C CONCRETE	PNL	D PLYWOOD PANEL	EQUIPMENT TAG	(000000)	
ABLE TRAYS	CAJ-4071 (2hr) CAJ-4083 (2hr)	WL-4011 (2hr)		CONS	N CONNECTION ST CONSTRUCTION F CONTINUOUS	PKG PR PROT	PARKING PAIR PROTECTION	PARKING TAG	00	
IETAL PIPE WITH GLASS FIBER	FA-5032 (2hr)	WL-5029 (2&3hr)	WL-5244 (2hr)		CORRIDOR CARPET	PST PT	PLASTER PAINT		1 Ref	
NSULATION	CAJ-5091 (2hr) FA-5017 (2hr)	WL-5257 (2hr)		DBL DET	DOUBLE DETAIL	PVMT	PAVEMENT QUANTITY	ELEVATION TAG	Ref	
/IETAL PIPE WITH AB/PVC NSULATION	CAJ-5090 (3hr) FA-5032 (2hr)	WL-5028 (2hr)	WL-5143 (2hr)	DIA DIM	DIAMETER DIMENSION	QTY QZ	QUARTZ	ELEVATION TAG		
	FA-5015 (2hr)			DN DR	DOWN DOOR	RAD RB	RADIUS RESILIENT BASE		Ref 1	
ISCELLANEOUS LECTRICAL (BUSWAY)	CAJ-6017 (2hr) CAJ-6042 (2hr)	WL-6019 (2hr)		DS DWG DWG	DOWNSPOUT DRAWING S DRAWINGS	RO RT RD	ROUGH OPENING RESILIENT TILE ROOF DRAIN	BUILDING SECTION	1 SIM	1 SIM
HEET METAL DUCT	CAJ-7051 (3hr)	WL-7040 (2hr)		EA	EACH	REF REINF	REFERENCE REINFORCED	BUILDING SECTION	A101	A101
RECTANGULAR)		WL-7155 (2hr) WL-7059 (1&2hr)		ELEC ELEV	ELEVATOR	REQ'E) REMOVED) REQUIRED		SIM	
HEET METAL DUCT	CAJ-7084 (2hr)	WL-7042 (1&2hr)	WL-7068 (2hr)		R EMERGENCY ENCLOSED ENGINEER	RES REV RF	RESILIENT REVISION OR REVISED ROOF	WALL SECTION	A101	
		WL-7153 (1&2hr)		EQ EQM1	EQUAL F EQUIPMENT	RFG RH	ROOFING RIGHT HAND		SIM	_
ULTIPLE PENETRATIONS	FA-8012 (2hr)	WL-8065 (2hr) WL-8079 (2hr)	WL-8098 (2hr)	ESC ETR EWC	ESCALATOR EXISTING TO REMAIN ELECTRIC WATER COOLER	RM RP RS	ROOM RESIN PANEL RESILIENT SHEET FLOOR	DETAIL SECTION	1 00.00	
OTES:	FA-8016 (2hr)	WL-8071 (2hr)		EXIST EXH	T EXISTING EXHAUST	RT	RESILIENT TILE FLOOR			
				EXP EXT	EXPOSED EXTERIOR	S&BR SCWE SS	SEALANT & BACKER ROD SOLID CORE WOOD SOLID SURFACE	ENLARGED PLAN		
				FD FDVC	FLOOR DRAIN FIRE DEPARTMENT VALVE CABINET	STS	STAINLESS STEEL CT STRUCTURAL	OR DETAIL	A101	/
				FE FEC	FIRE EXTINGUISHER FIRE EXTINGUISHER CABINET FIRE EXTINGUISHER & VALVE	SHT SIM	SHEET SIMILAR STANDARD	ELEVATION MARK		Name
BASIS OF	DESIG	N SYSTE	EMS	FHC	CABINET FIRE HOSE CABINET	STD STL STO	STANDARD STEEL STORAGE	-	Ele	vation 🖓
FOR CON	STRUC ⁻	TION JO	INTS	FIN FLG	FINISH(ED) FLASHING	SUSP SV	SHEET VINYL	SPOT ELEVATION	0'-0	" ••
ESCRIPTION: GYP BD W		1		FLR FP FRT	FLOOR FABRIC PANEL FIRE RETARDANT TREATED	ST T/	STONE TOP OF			
				FUT FVC	FUTURE FIRE VALVE CABINET	T&B T&G	TOP AND BOTTOM TONGUE AND GROOVE	NORTH ARROW	$\left(+ \right)$	
ALLS ERPENDICULAR TO	HWD-0042 (2hr) HWD-1066 (2hr)			GA GALV	GAUGE GALVANIZED	TB TEL TEMP	TILE BASE TELEPHONE TEMPORARY		→ ^	
ETAL DECK	HWD-0045 (2hr)	-		GB GF	GRAB BAR GLASS FILM	THK TK	THICK TACKABLE SURFACE	EXISTING COLUMN LINE		
ALLS PARALLEL TO ETAL DECK	HWD-0049 (2hr) HWD-1067 (2hr)				C GLASS FIBER REINFORCED CONC GLASS FIBER REINFORCED PLASTER	TL TP TS	TILE TOILET PARTITION TRANSITION STRIP	LINE	\searrow	
	HWD-0184 (2hr) HWD-0539 (2hr)				PLASTER GL GLASS, GLAZING BD GYPSUM WALL BOARD	TS TYP TZ	TYPICAL TERRAZZO	NEW COLUMN	$\overline{(0)}$	
ALLS TO FLAT	HWD-1068 (2hr)	1		HC	HOLLOW CORE	UL	UNDERWRITERS LABORATORY	LINE		DETAIL NUMBER
CONCRETE	HWD-0209 (2hr) HWD-3024 (2hr)	-		HM HP HD	HOLLOW METAL HIGH POINT HEAD	UNO UPH	UNLESS NOTED OTHERWISE UPHOLSTERY	MATON	1 / A101	/ SHEET NUMBER
				HDW HORI	E HARDWARE Z HORIZONTAL	VAPB VERT	VERTICAL	MATCH LINE	\frown	
HAFT WALL PERPENDICULAR TO	HWD-5069 (2hr)			HT HVAC	HEIGHT HEATING, VENTILATION, AND AIR CONDITIONING	VEST VIF	VESTIBULE VERIFY IN FIELD	REVISION	$\mathbb{A}(\mathcal{T})$	$\overline{)}$
IETAL DECK				INCL	INCLUDE (ED) (ING)	W/ W/O	WITH WITHOUT	-	-~~	مہ
HAFT WALL PARALLEL O METAL DECK	HWD-5070 (2hr)			INFO INSUI	INFORMATION INSULATION	WB WC	WOOD BASE WALL COVERING		DEPT -	- DEPARTMENT
HAFT WALL TO FLAT	HWD-0342 (2hr)	-		INT	INTERIOR	WD WF	WOOD WOOD FLOOR	AREA TAG	AREA NAME 000 SF 🔫	- ROOM SF
ONCRETE	HWD-0572 (2hr)	-		JC JB JT	JANITOR'S CLOSET JAMB JOINT	WP WT WDC	WATERPROOFING WINDOW TREATMENT WOOD CEILING			
		-		LP	LOW POINT	WG WOM	WALL PROTECTION/GUARD WALK-OFF MAT	FINISH TAG	WG-3	
ESCRIPTION: CONCRETE				LAM LAV	LAMINATE LAVATORY	WV	WOOD VENEER	FINISH TAG	WG-3	- WALL
ERPENDICULAR TO ETAL DECK	HWD-1037 (2hr) HWD-0081 (2hr)			LH LT LVR	LEFT HAND LIGHT LOUVER			TYP. GROUP	WG-3 WG-3	— BASE — FLOOR
ARALLEL TO METAL	HWD-0081 (2111) HWD-0181 (2hr)	-								
DECK	HWD-0081 (2hr)							GRAIN DIRECTION	—	

DESCRIPTION: GYP BD WALLS		
WALLS PERPENDICULAR TO METAL DECK	HWD-0042 (2hr) HWD-1066 (2hr) HWD-0045 (2hr)	
WALLS PARALLEL TO METAL DECK	HWD-0049 (2hr) HWD-1067 (2hr) HWD-0184 (2hr) HWD-0539 (2hr)	
WALLS TO FLAT CONCRETE	HWD-1068 (2hr) HWD-0209 (2hr)	
CUT TO PROFILE	HWD-3024 (2hr)	
SHAFT WALL PERPENDICULAR TO METAL DECK	HWD-5069 (2hr)	
SHAFT WALL PARALLEL TO METAL DECK	HWD-5070 (2hr)	
SHAFT WALL TO FLAT CONCRETE	HWD-0342 (2hr) HWD-0572 (2hr)	
DESCRIPTION: CONCRET BLOCK WALLS	EOR	
PERPENDICULAR TO METAL DECK	HWD-1037 (2hr) HWD-0081 (2hr)	
PARALLEL TO METAL DECK	HWD-0181 (2hr) HWD-0081 (2hr)	
FLAT CONCRETE	HWD-1058 (2hr) HWD-0268 (2hr)	
NOTES:		

LOCATION MAP

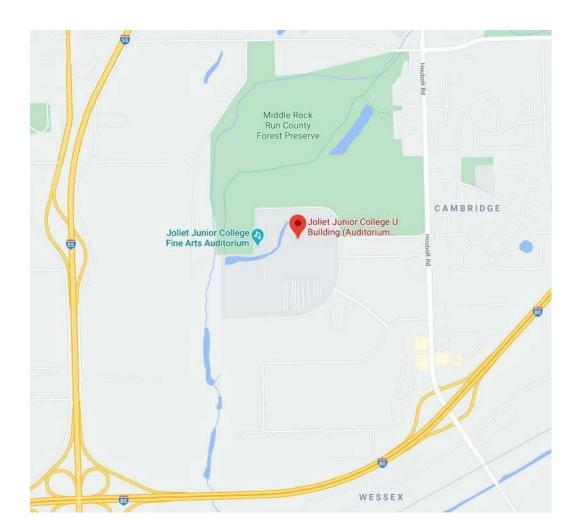

LINE STYLE LEGEND

GRAIN DIRECTION

DEMOLITION
EXISTING
NEW
EQUIPMENT
FURNITURE
PROPERTY LINE

BUILDING CODE

ILLINOIS COMMUNITY	Y COLLEGE BOARD			
BUILDING CODE:	INTERNATIONAL BUILDING CODE 2015			
MECHANICAL CODE:	INTERNATIONAL MECHANICAL CODE 2015			
ELECTRICAL CODE:	NATIONAL ELECTRICAL CODE, NFPA 70, 2014			
FIRE PROTECTION:	NATIONAL FIRE PROTECTION ASSOCIATION 101, LIFE SAFETY CODE, 2003			
PLUMBING CODE:	ILLINOIS PLUMBING CODE (77 ILL. ADM. CODE 890)			
ACCESSIBILITY CODE:	ILLINOIS ACCESSIBILITY CODE (71 ILL. ADM. CODE 400) OR THE 2010 AMERICANS WITH DISABILITIES STANDARDS FOR ACCESSIBLE DESIGN (28 CFR 35 AND 36), WHICHEVER IS MORE STRINGENT.			
FIRE PREVENTION:	FIRE PREVENTION AND SAFETY (41 ILL. ADM. CODE 100)			
ENERGY CODE:	ILLINOIS ENERGY CONSERVATION CODE (74 ILL. ADM. CODE 600)			
	ANY LOCAL BUILDING CODES THAT MAY BE MORE RESTRICTIVE			
CITY OF JOLIET				
BUILDING CODE:	INTERNATIONAL BUILDING CODE 2015 WITH AMENDMENTS OF THE CITY OF JOLIET, IL			
MECHANICAL CODE:	INTERNATIONAL MECHANICAL CODE 2015 WITH AMENDMENTS OF THE CITY OF JOLIET, IL			
ELECTRICAL CODE:	NATIONAL ELECTRICAL CODE 2014 WITH AMENDMENTS OF THE CITY OF JOLIET, IL			
PLUMBING CODE:	CURRENT ILLINOIS PLUMBING CODE WITH AMENDMENTS OF THE CITY OF JOLIET, IL			
ENERGY CODE:	INTERNATIONAL ENERGY CODE 2015			
FIRE PROTECTION:	INTERNATIONAL FIRE PREVENTION CODE 2015 WITH AMENDMENTS OF THE CITY OF JOLIET, IL			
ACCESSIBILITY CODE:	ILLINOIS ACCESSIBILITY CODE. ADA ACCESSIBILITY GUIDELINES (ADAAG)			

CODE DATA

OCCUPANCY TYPES:	B BUSINESS (W/ ACCESSORY A-3 ASSEMBLY)
CONSTRUCTION TYPES:	TYPE 2B
HEIGHT AND BUILDING AREAS ALLOWED:	: 4 STORIES, 55 FEET, 23,000 SF (PER FLOOR)
BUILDING AREAS:	
LEVEL 1: LEVEL 2: LEVEL 3: MECHANICAL PENTHOUSE:	54,040 GSF 32,477 GSF 23,316 GSF 5,862 GSF
TOTAL	124,964 GSF
ACCESSIBLE MEANS OF EGRESS:	124,964 GSF ALL EXITS ARE ACCESSIBLE
ACCESSIBLE MEANS	
ACCESSIBLE MEANS OF EGRESS:	ALL EXITS ARE ACCESSIBLE 300' FT (W/ AUTOMATIC SPRINKLER)
ACCESSIBLE MEANS OF EGRESS: MAX TRAVEL DISTANCE:	ALL EXITS ARE ACCESSIBLE 300' FT (W/ AUTOMATIC SPRINKLER) (200' THROUGH AN ATRIUM)

FIRE RESISTANCE

CONSTRUCTION TYPE: OCCUPANCY: FIRE PROTECTION:	TYPE 2B B BUSINESS (W/ ACCESSORY A-3 ASSEMBLY) FULLY SPRINKLED		
DESCRIPTION:	REQUIRE F	RATING:	
STRUCTURAL FRAME (INCL. COLUMNS,GIRDERS, ⁻	TRUSSES)	0 HR	
BEARING WALLS INTERIOR EXTERIOR		0 HR 0 HR	
INTERIOR NON-BEARING WAL PARTITIONS	LS AND	0 HR	
FLOOR CONSTRUCTION		0 HR	
ROOF CONSTRUCTION		0 HR	

GENERAL NOTES

1. ALL STAIR TREADS, RISERS, AND PLATFORMS SHALL BE SOLID. TREADS SHALL NOT BE LESS THAN 11" AND RISERS NOT GREATER THAN 7".

2. COMBUSTIBLE MATERIALS MAY NOT BE USED IN ANY ASSEMBLY WITH REQUIRED FIRE RESISTANCE OF 2 HOURS OR MORE. 3. ALL RATED DOORS SHALL BE SELF-CLOSING.

4. DOOR OPENING FORCE SHALL BE 8.5 lbs FOR EXTERIOR AND 5 lbs FOR INTERIOR.

5. ALL AUDIO/VISUAL ALARMS SHALL BE SYNCHRONIZED.

6. ALL INTERIOR STAIRS SHALL HAVE DETECTABLE WARNING STRIP SURFACES PER ADA STANDARDS.

7. ALL EXIT DOORS SHALL SWING IN THE DIRECTION OF TRAVEL.

8. ALL MECHANICAL, ELECTRICAL AND HAZARDOUS ROOM DOORS SHALL HAVE KNURLED HARDWARE.

9. GLAZING: SAFETY GLASS SHALL BE PROVIDED IN CONFORMANCE WITH ANSI Z97.1 SAFETY PERFORMANCE SPECIFICATIONS AND METHODS FOR SAFETY GLAZING USED FOR BUILDINGS AND CPSC 16 CFR 1201.

10. EXITING: THE CONTRACTOR SHALL MAINTAIN UNOBSTRUCTED AND CLEARLY MARKED EGRESS PATHS FROM OCCUPIED AREAS AT ALL TIMES.

PROJECT DESCRIPTION

A NEW RESPIRATORY THERAPY EDUCATION DEPARTMENT WITHIN THE EXISTING HEALTH PROFESSIONS "U" BUILDING AT JOLIET JUNIOR COLLEGE.

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GI.03	Life Safety Plan
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A2.0	Reflected Ceiling Plan
A4.0	Perimeter Sections and Concrete Details
A7.0	Interior Elevations
A7.1	Interior Elevations
A7.2	Interior Elevations
A8.0	Interior Details, Elevations, and Enlarged Plan - Reception
A8.1	Interior Details, Elevations, and Enlarged Plan - Reception
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P1.00	Plumbing Underground Demolition Floor Plan
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P2.00	Plumbing Underground Plan
P2.01	Plumbing Level 01 Floor Plan
P8.01	Plumbing Details
P9.01	Plumbing Schedules
05 FIRE PR	OTECTION
FP0.00	Fire Protection Symbols and Abbreviations
FP1.01	Fire Protection Level 01 Demolition Floor Plan
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E1.01	Electrical Demolition Level 01 Floor Plan
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E4.01	Electrical Systems Level 01 Floor Plan
E8.01	Electrical Panel Schedules
07 COMMU	NICATION
T0.00	Technology Symbols and Abbreviationss
T3.01	Technology Level 01 Floor Plan
TA3.01	Audio Visual Level 01 Floor Plan & Ceiling Plan
TA6.01	Clinical Assessment Lab Video and Network System Diagram
TA6.02	Clinical Assessment Lab Audio and Control Network System Diagram
	M2.01 M3.01 M3.01 M8.02 M9.01 04 PLUMBIN P0.00 P1.00 P1.01 P2.00 P2.01 P8.01 P9.01 05 FIRE PR FP0.00 FP1.01 FP2.01 06 ELECTR E0.00 E1.01 E2.01 E3.01 E4.01 E8.01 07 COMMU T0.00 T3.01 TA3.01 TA3.01 TA6.01

Pro	ject	No.
19	91	30

GI.01

Sheet Title Drawing Index, General Notes, Abbreviations, Symbols

1215 Houbolt Rd, Joliet, IL 60431

Respiratory Therapy


Joliet Junior College

1 09-18-2020 Schematic Design / Design Development No. Date Issue Description ECKENHOFF SAUNDERS One Prudential Plaza 130 East Randolph Suite 1850 Chicago IL 60601 312.786.1204p esadesign.com


3 11-30-2020 Issued for Bid 2 11-19-2020 Issued for JJC Review


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Key Plan

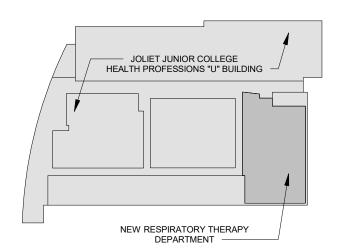

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1 1/2"

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Pr	oje	ect	Ν	lo
1	9	1	3	С

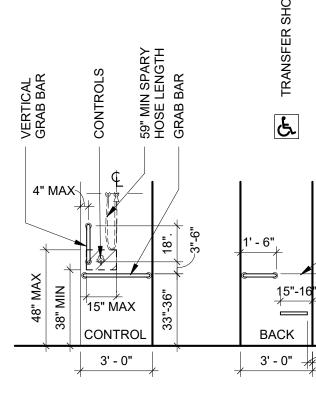GI.02

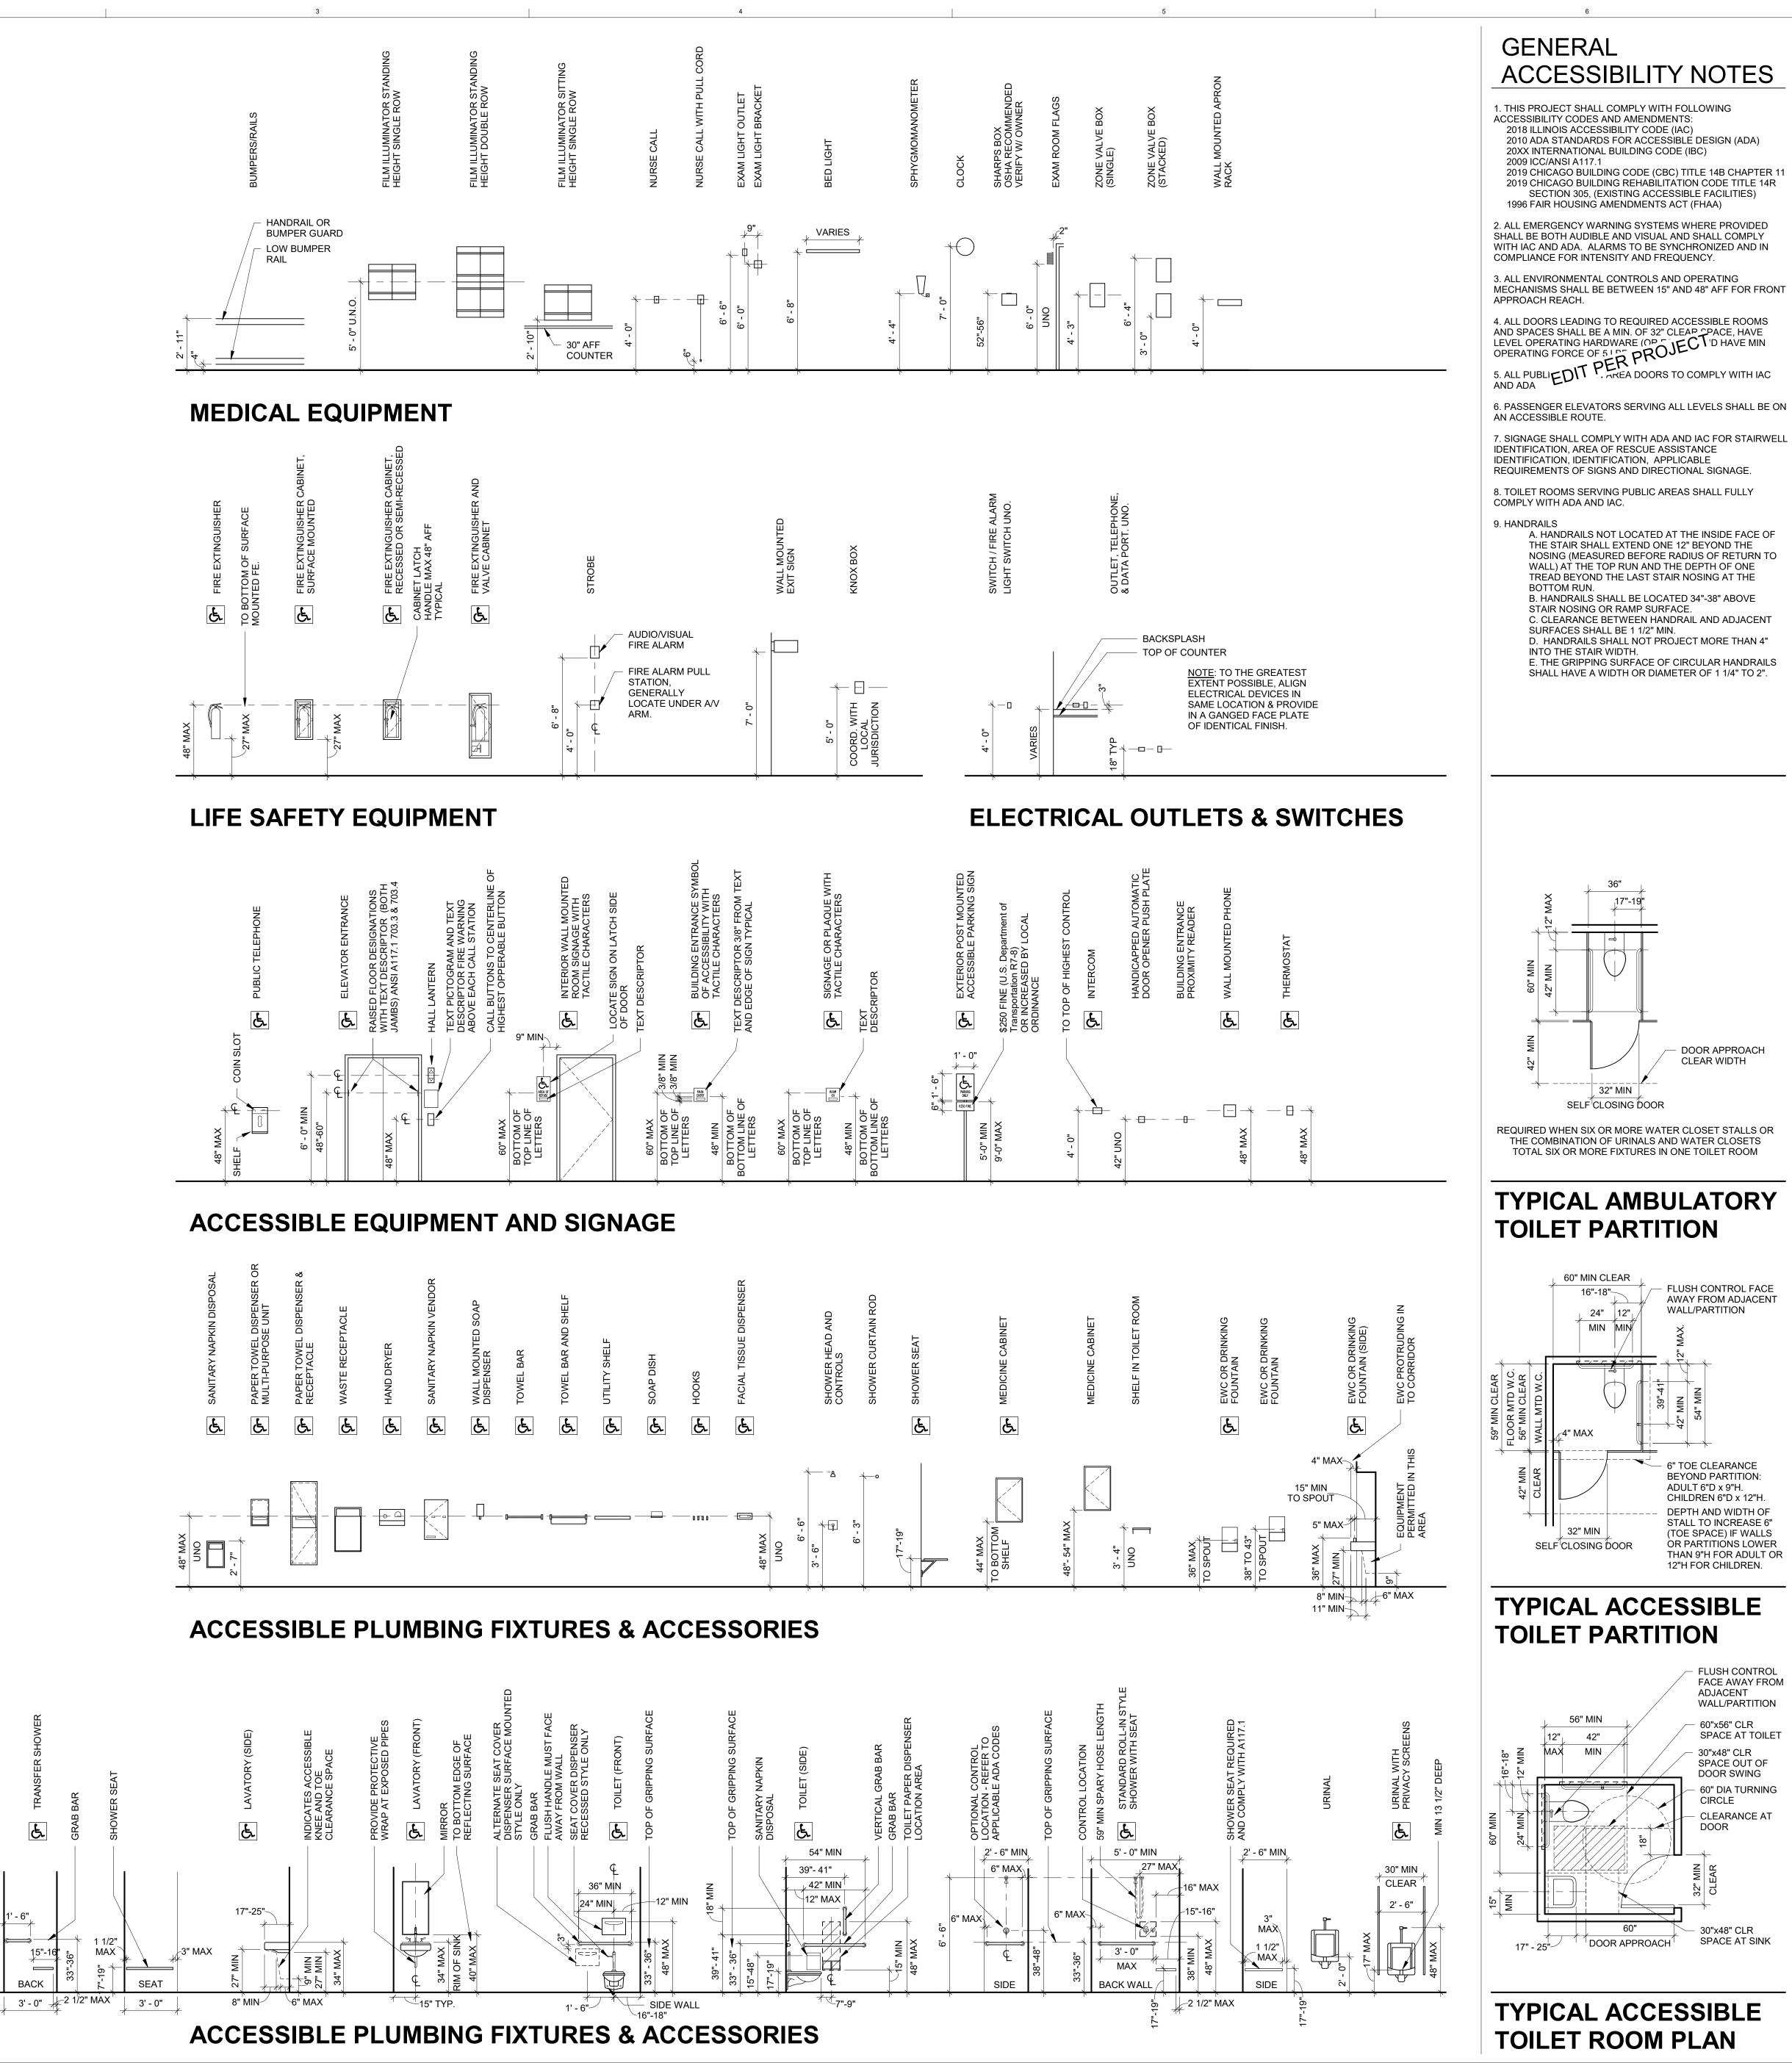
Sheet Title Standard Mounting Heights and Accessibility

1215 Houbolt Rd, Joliet, IL 60431

Respiratory Therapy

Glient / Project Name Joliet Junior College

One Prudential Plaza 130 East Randolph Suite 1850 Chicago IL 60601 312.786.1204p esadesign.com C 2019 Eckenhoff Saunders Architects, Inc

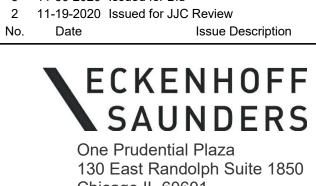

Key Plan


MEP/AV

Structural

Affiliated Engineers, Inc. (AEI)

Helen Torres & Associates, PLLC

3 11-30-2020 Issued for Bid

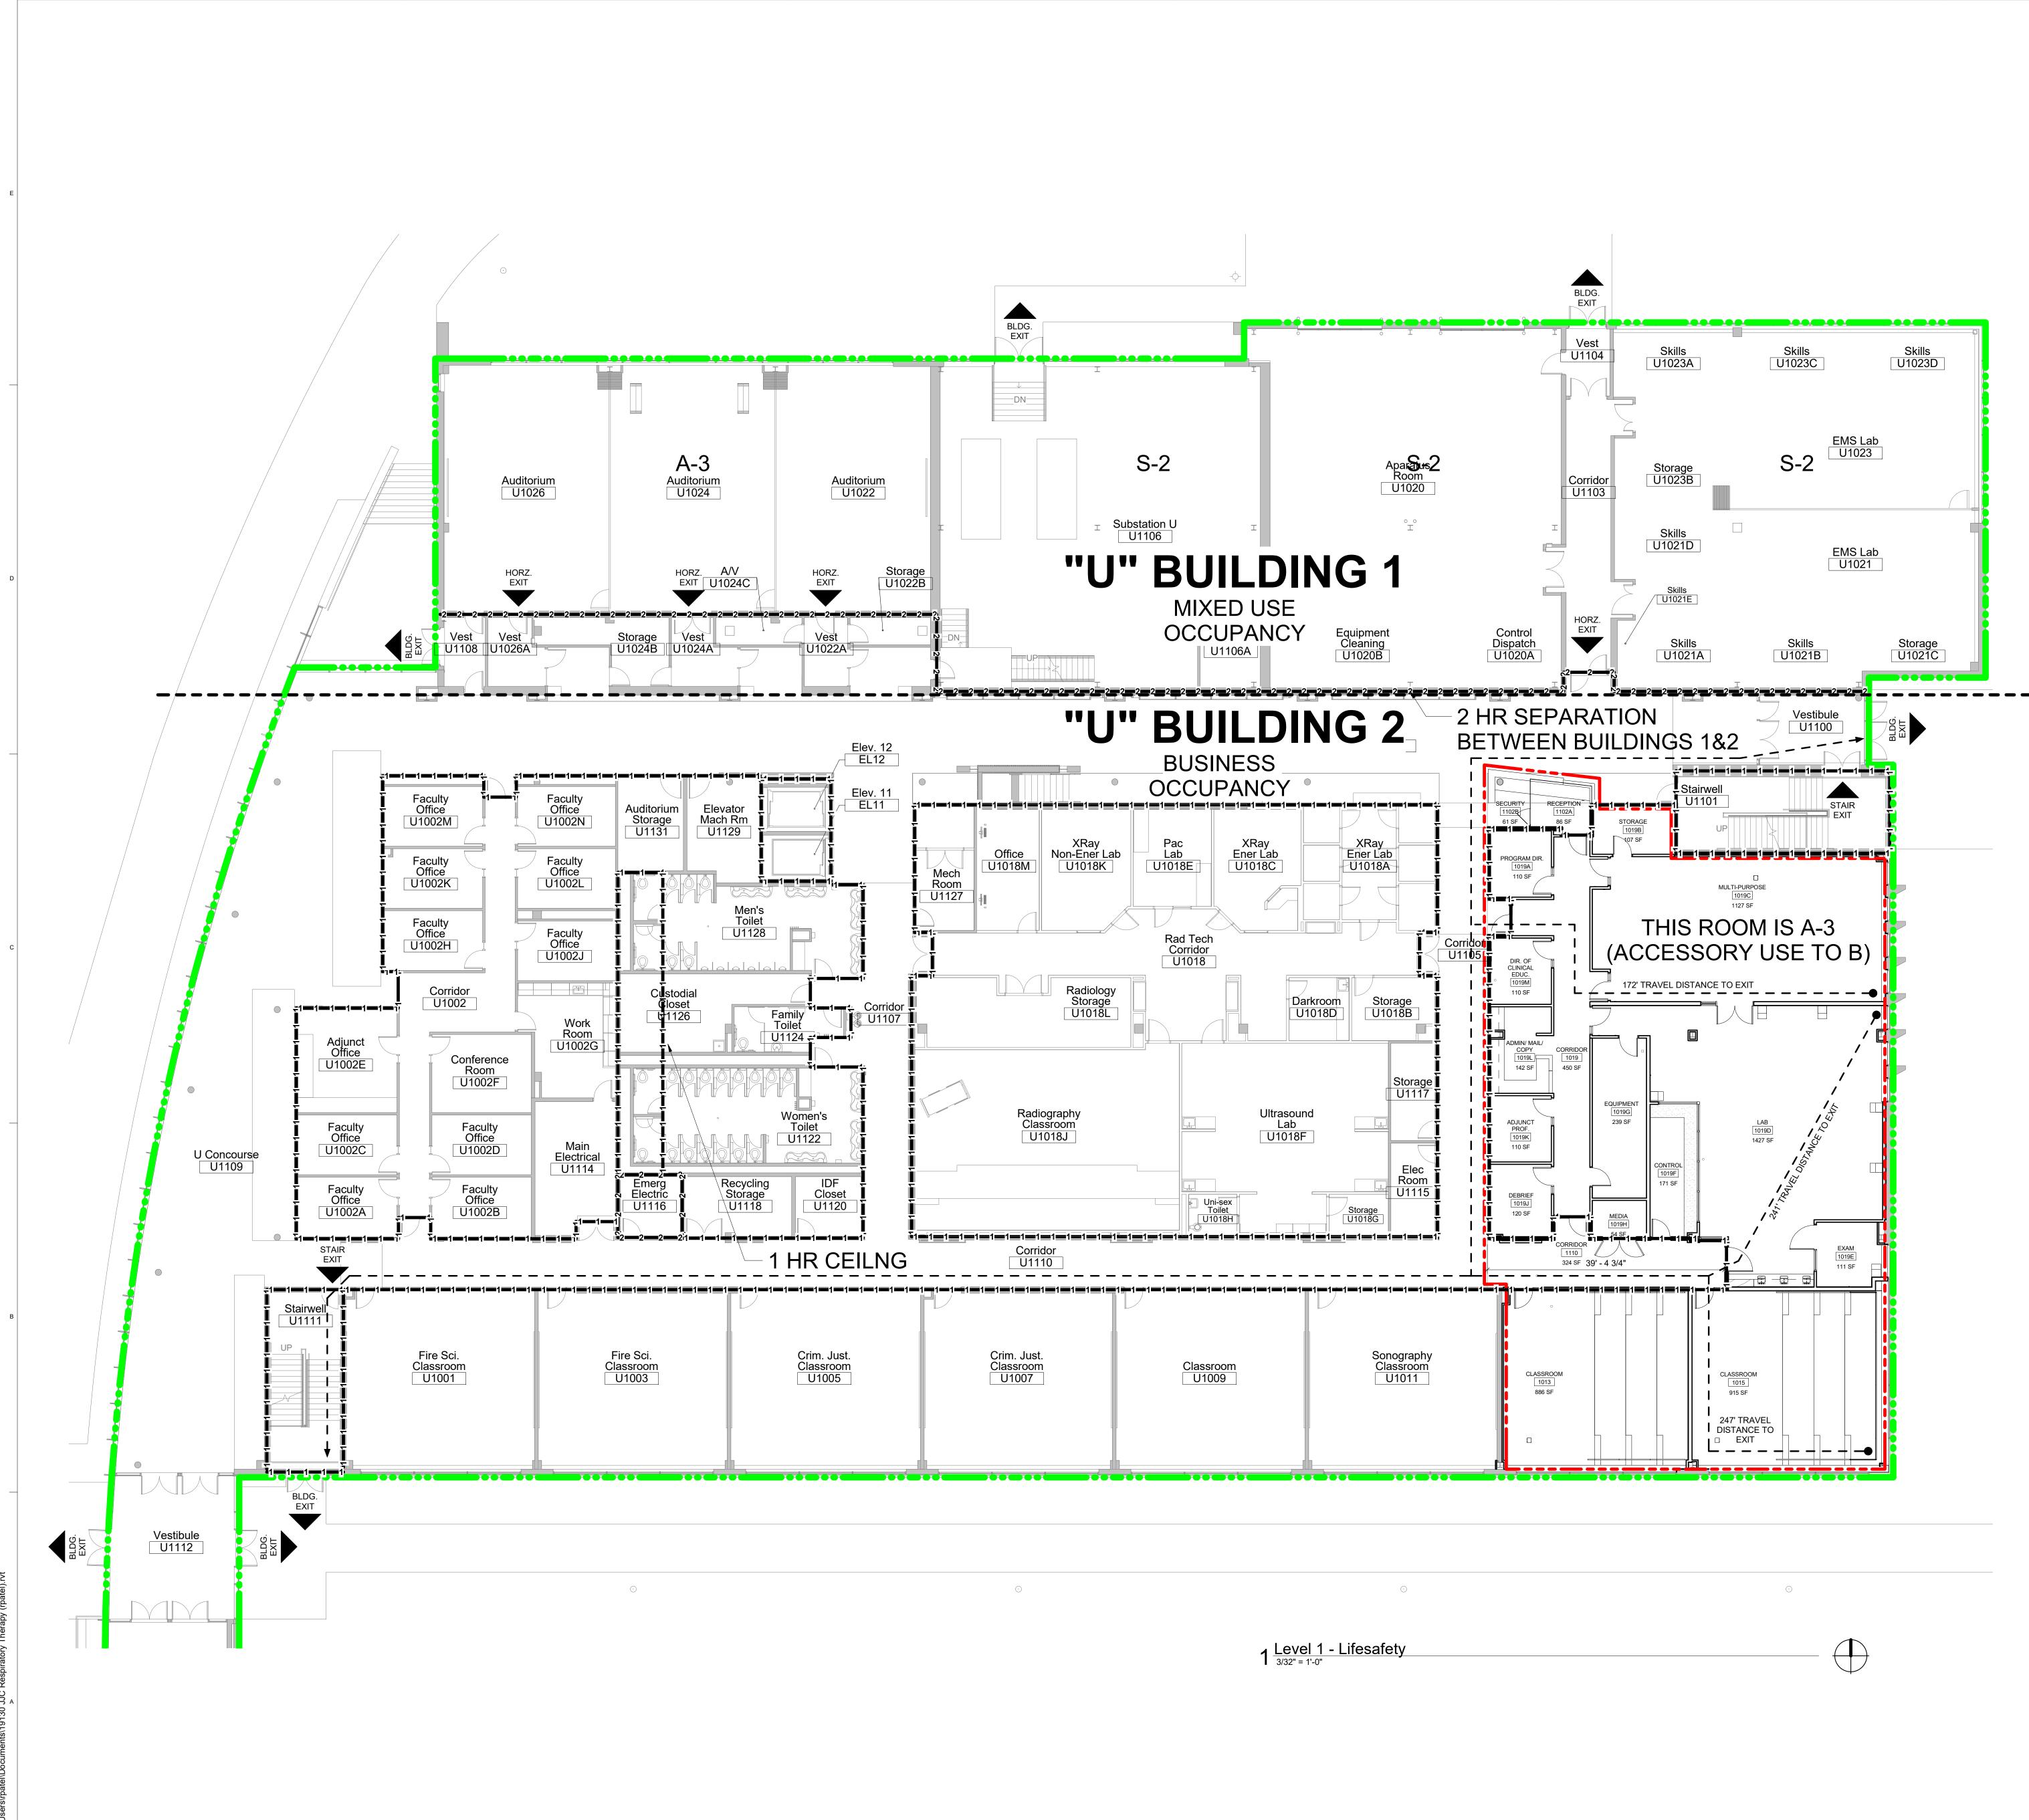

DATE: 11/3 FILE: C:VU

6	
_IFE SAFE1	Y LEGEND
− 4 −−−− 4 −−−− 4 − −	4 HOUR FIRE
−3−−−3 −−−3∍	3 HOUR FIRE
⊴2S 2S2S 2S 2S - -2S - 2S - -2S - 2S 	2 HOUR FIRE & SMOKE RATING
■1S====1S====1S ■	1 HOUR FIRE & SMOKE RATING
−2 −−−2	2 HOUR FIRE RATING
⊂11 1⊃	1 HOUR FIRE RATING
∝ S ····· S ···· S · ··S ·	SMOKE
•-~~~	TRAVEL DISTANCE TO EXIT
	EXIT ACCESS CORRIDORS
	AREA OF WORK OUTLINE
	BUILDING PERIMETER
(FE VC	FIRE EXTINGUISHER AND VALVE CONNECTION
BLDG. EXIT	BUILDING EXIT AT GRADE
STAIR EXIT	STAIR EXIT
HORZ. EXIT	HORIZONTAL EXIT
	SUITES
	SMOKE COMPARTMENTS

45 Min 0000 0.0 EU EXIT UNITS

LIFE SAFETY NOTES

1. ENTIRE BUILDING IS FULLY SPRINKLERED. 2. ALL NEW CONSTRUCTION IS TO COMPLY WITH CODES LISTED ON GI.01 SHEET

3. EXISTING FIRE SEPARATION AND RATINGS BASED ON DRAWINGS RECEIVED FROM THE OWNER. CONTRACTOR TO VERIFY SEPARATIONS AND RATINGS IN AREA OF CONSTRUCTION AND IN AREAS SEPARATING CONSTRUCTION FROM THE EXISTING.

Project No. 19130

GI.03

Sheet Title Life Safety Plan

1215 Houbolt Rd, Joliet, IL 60431

Respiratory Therapy

Joliet Junior College


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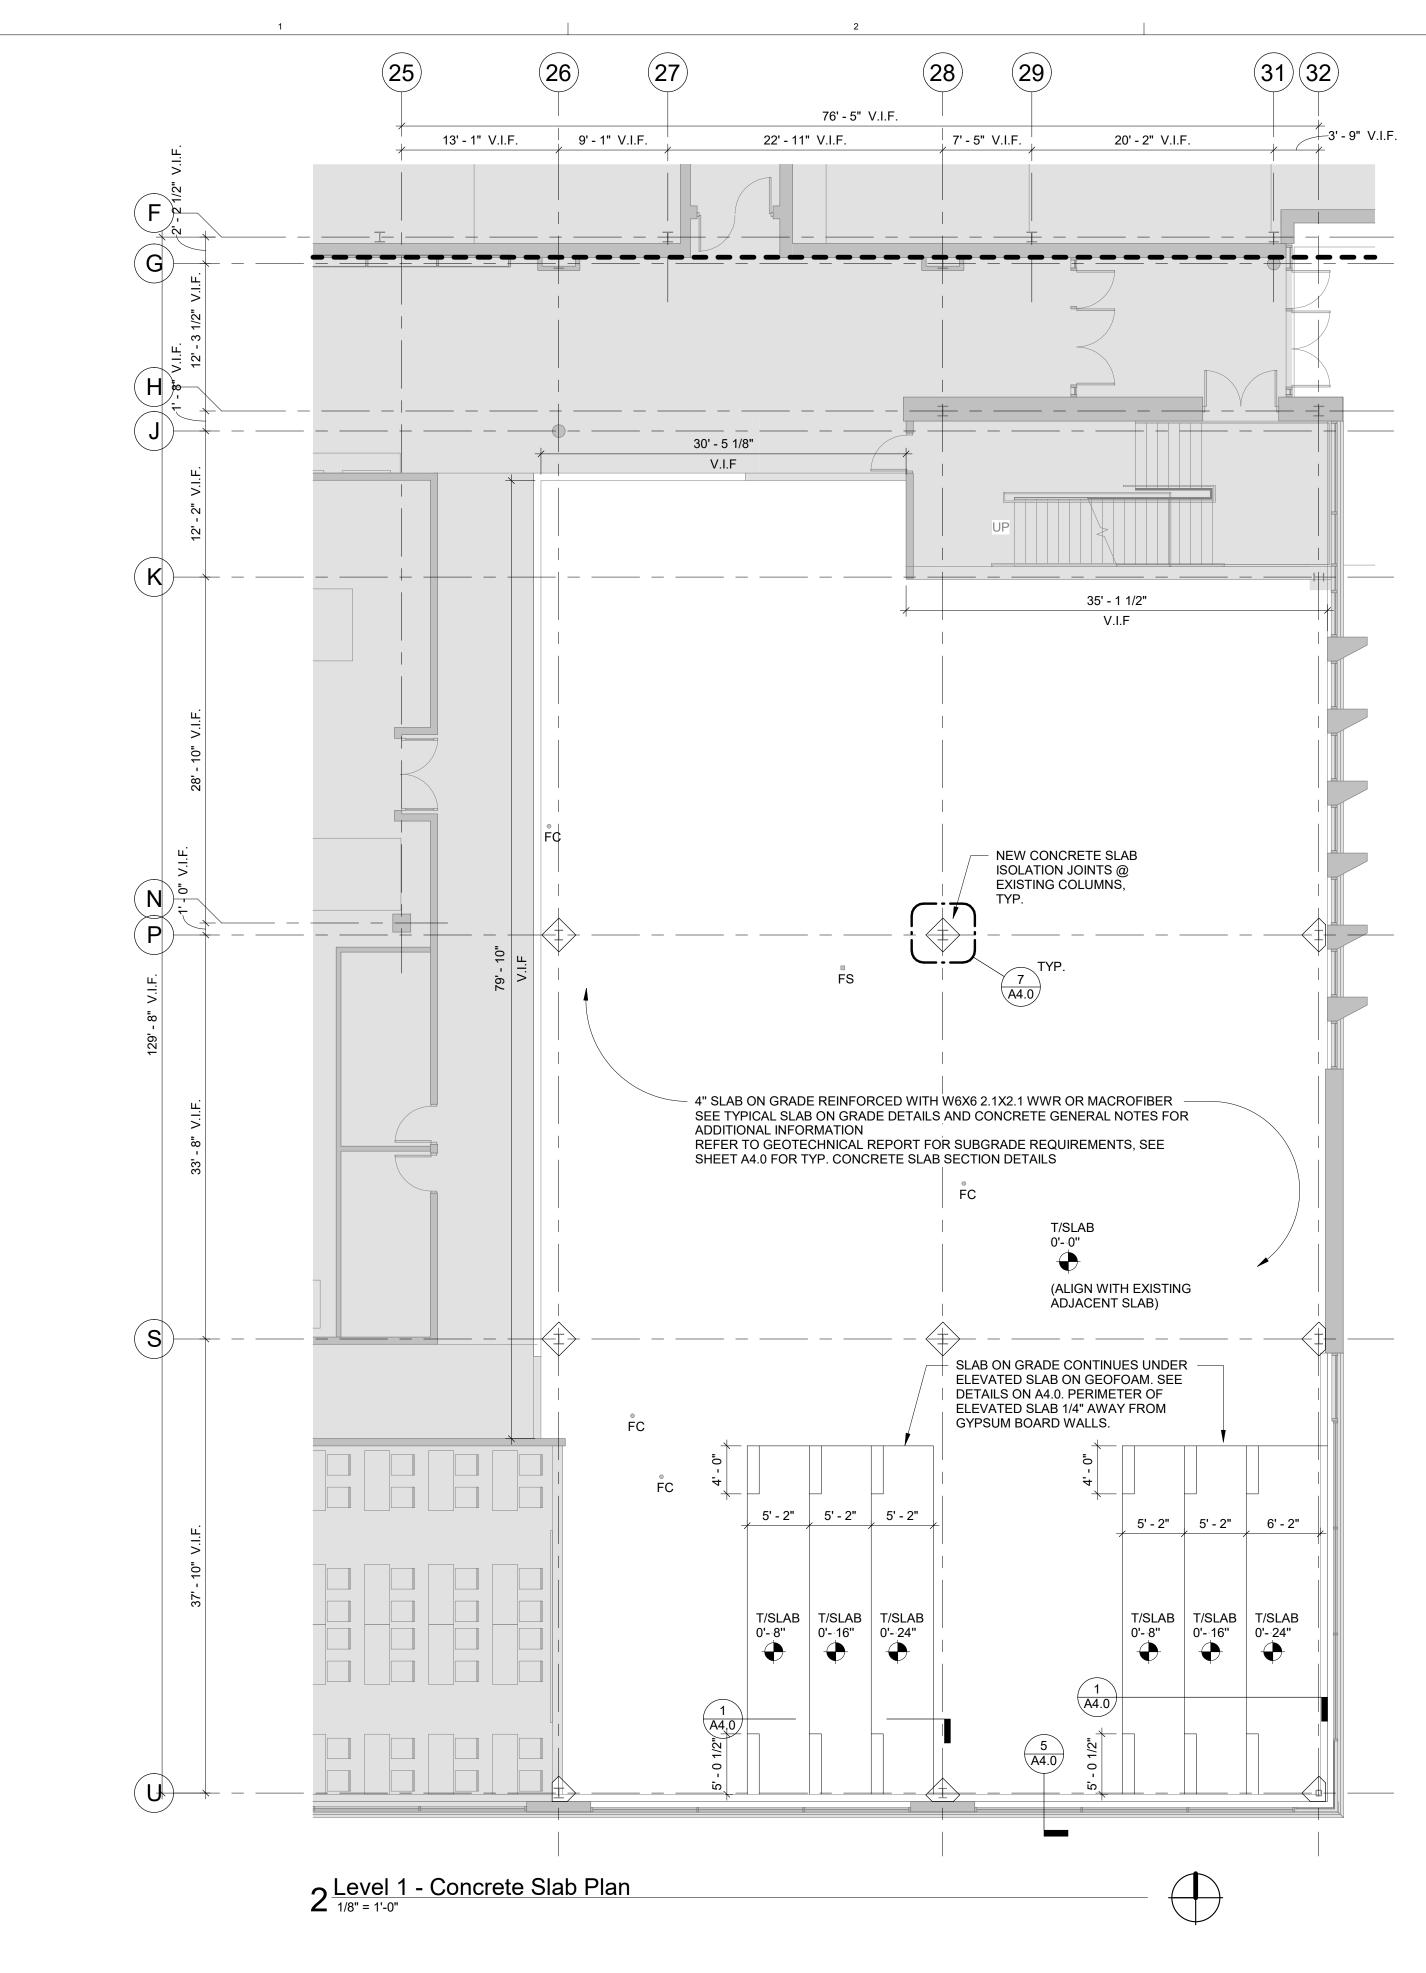
1 09-18-2020 Schematic Design / Design Development

3 11-30-2020 Issued for Bid

2 11-19-2020 Issued for JJC Review

Key Plan



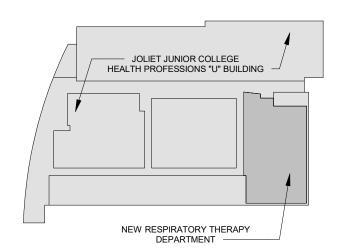

CONCRETE DESIGN CRITERIA

1. CODE:

AMERICAN CONCRETE INSTITUE BUILDING CODE REQUIREMENTS FOR STRUCTURAL CONCRETE (ACI 318-05) 2. SPECIFIED 28-DAY CONCRETE COMPRESSIVE STRENGTHS (fc)

SLABS ON GRADE SEE PROJECT SPECIFICATION SECTION 033000

3. CONCRETE REINFORCING STEEL SHALL BE HIGH STRENGTH NEW BILLET STEEL CONFORMING TO THE FOLLOWING STANDARDS:

DEFORMED BARS ASTM A615, GRADE 60 Fy = 60 KSI WELDED WIRE REINFORCING ASTM A185 Fy = 65 KSI

REINFORCING STEEL

1. FOR CAST-IN-PLACE CONCRETE THE FOLLOWING MINIMUM CONCRETE COVER SHALL BE PROVIDED FOR REINFORCEMENT UNLESS NOTED OTHERWISE:

CONCRETE CAST AGAINST AND PERMANENTLY EXPOSED TO EARTH 3 INCH

CONCRETE EXPOSED TO EARTH OR WEATHER NO.5 BARS OR SMALLER 1 1/2 INCHES


SLABS NOT EXPOSED TO WEATHER OR IN CONTACT WITH EARTH NO.11 BARS OR SMALLER 3/4 INCH

SLAB ON GRADE

1. REFER TO GEOTECHNICAL ENGINEERING REPORT DATED MARCH 24, 2010 BY TERRACON CONSULTANTS, INC. FOR SLAB ON GRADE SUBGRADE REQUIREMENTS

2. PROVIDE SAW CUT CONTROL JOINTS IN ALL SLABS-ON-GRADE. LOCATE JOINTS ALONG COLUMN LINES WITH INTERMEDIATE JOINTS SPACED AT A MAXIMUM OF 36 TIMES THE SLAB THICKNESS, UNLESS NOTED OTHERWISE. CONTROL JOINTS SHALL BE CONTINUOUS, NOT STAGGERED OR OFFSET. SLAB PANELS SHALL HAVE A MAXIMUM LENGTH TO WIDTH RATIO OF 1.5 TO 1. PROVIDE ADDITIONAL CONTROL JOINTS AT ALL RE-ENTRANT CORNERS FORMED IN SLAB ON GRADE.

3.COMPACT NEW FILL MATERIAL TO 95% OF THE MATERIALS MODIFIED PROCTOR MAXIMUM DRY DENSITY (ASTM D 1557).

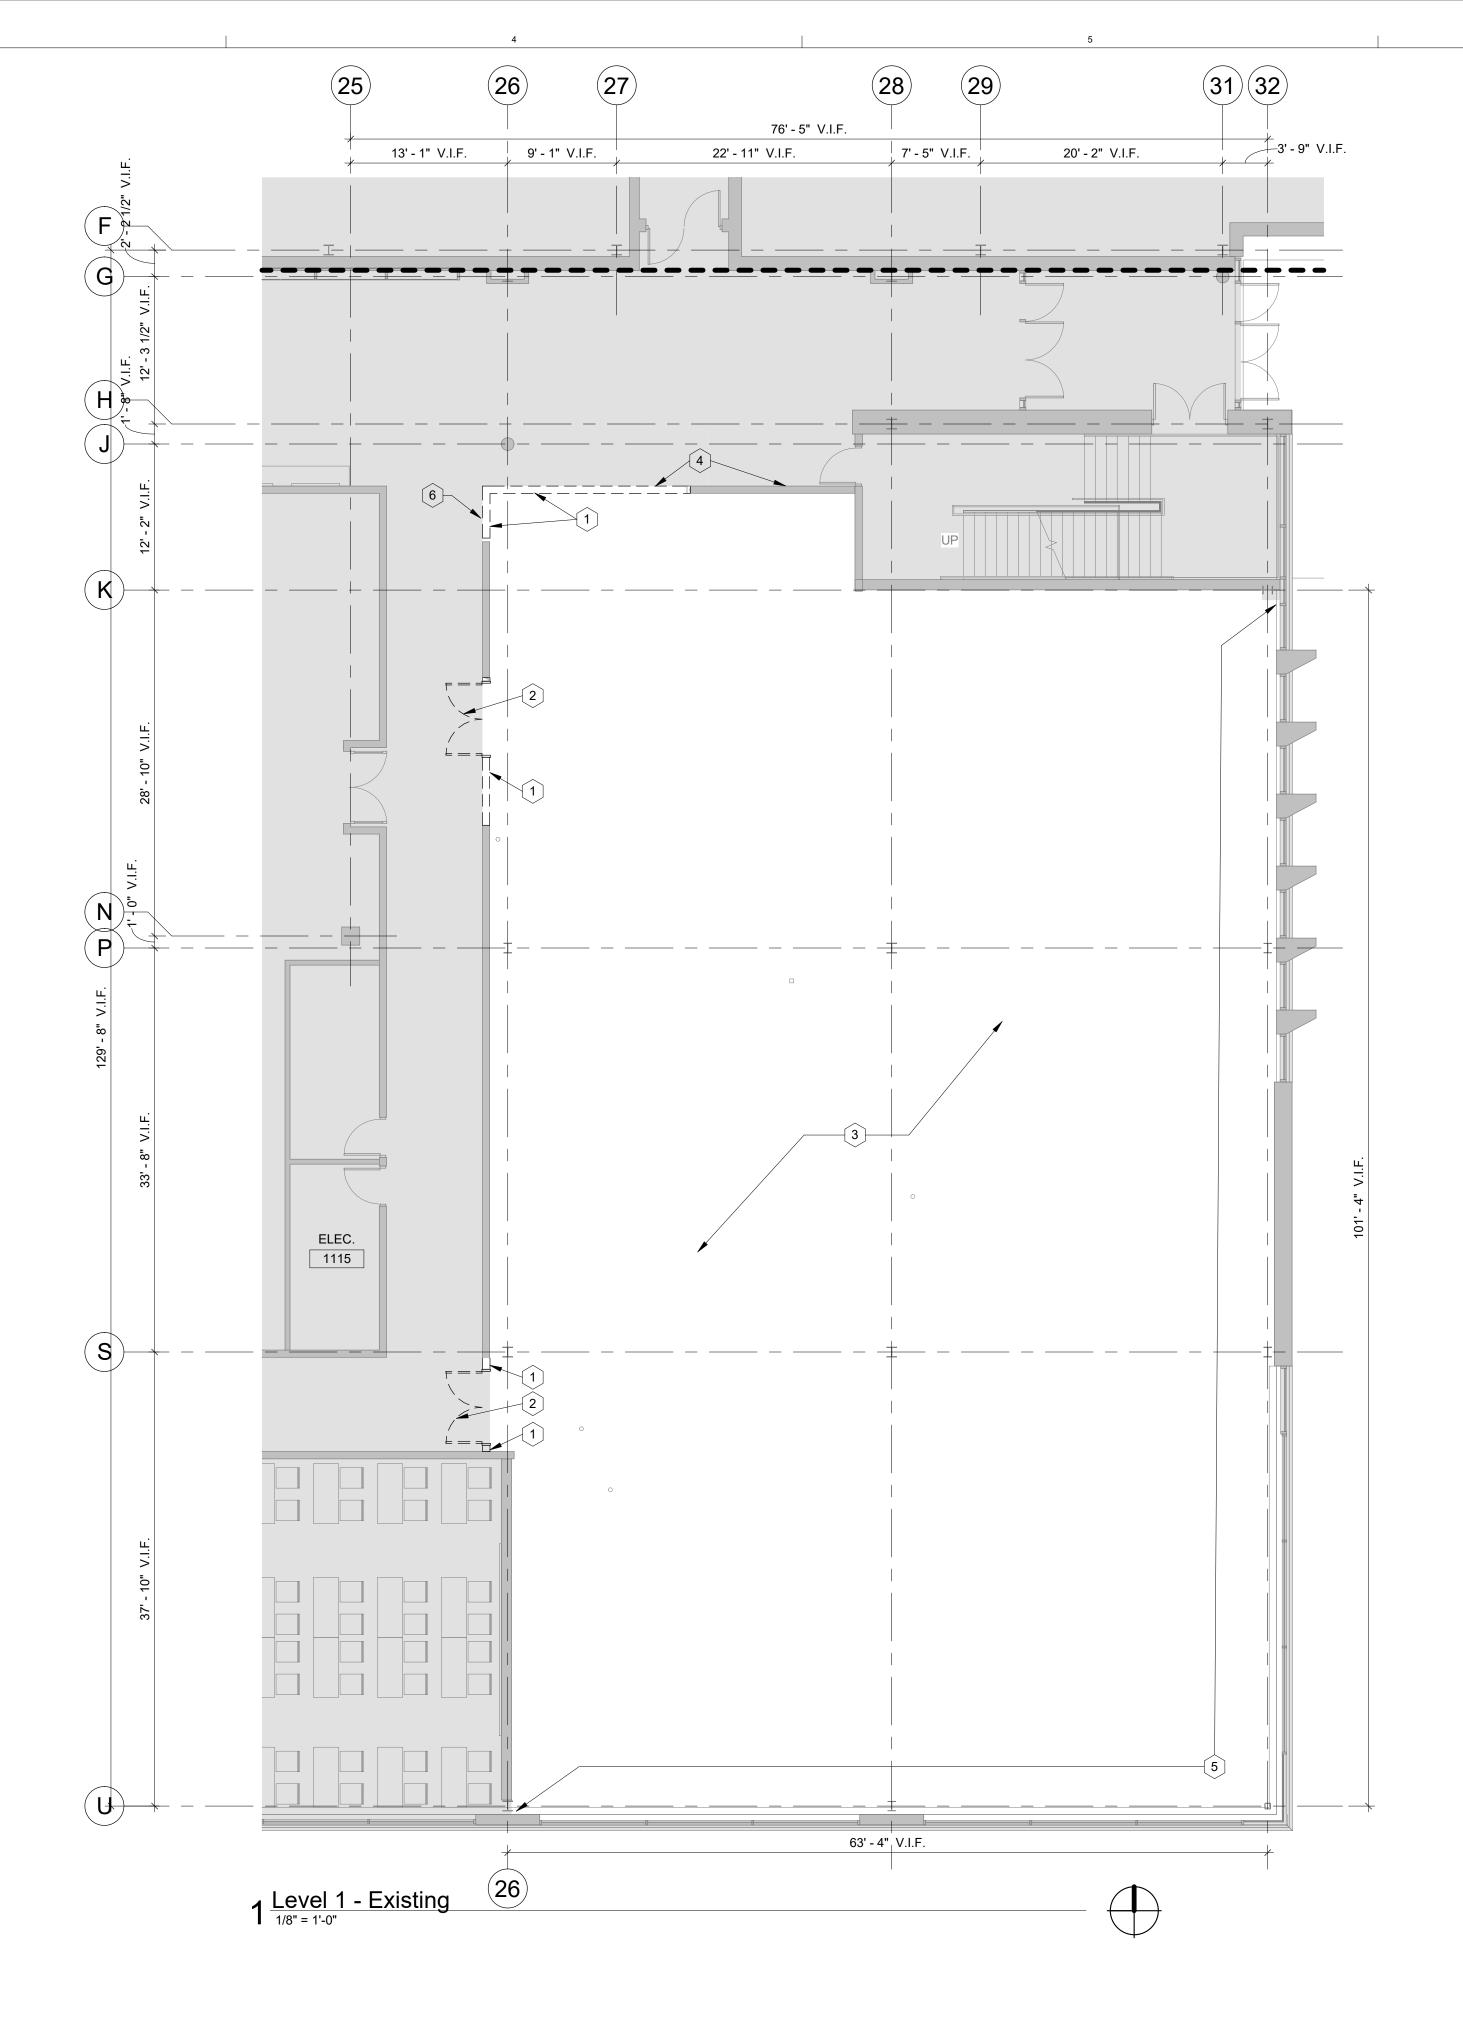

SPECIAL INSPECTIONS

IN ACCORDANCE WITH CHAPTER 17 OF THE INTERNATIONAL BUILDING CODE, THE OWNER SHALL EMPLY A SPECIAL INSPECTION AGENCY TO PERFORM THE DUTIES AND RESPONSIBILITIES SPECIFIED IN SECTION 1704:

RESPONSIBILITIES SPECIFIED IN SECTION 1704:							
CONCRETE AND CONCRETE PLACEMENT	CONTINUOUS	PERIODIC	REFERENCED STANDARD	IBC REFERENCE			
VERIFYING USE OF REQUIRED DESIGN MIX		Х	ACI 318: CH.4, 5.2-5.4	1904.2.2			
SAMPLING FRESH CONCRETE AND PERFORMING SLUMP, AIR CONTENT AND DETERMINING THE TEMPERATURE OF FRESH CONCRETE AT THE TIME OF MAKING PECIMENS FOR STRENGTH TESTS.	X		ASTM C172, ASTM C31, ACI 318: 5.6,5.8				
INSPECTION OF CONCRETE PLACEMENT FOR PROPER APPLICATION TECHNIQUES	Х		ACI 318: 5.9, 5.10	1704.4			
INSPECTION FOR MAINTENANCE OF SPECIFIED CURING TEMPERATURE AND TECHNIQUES		Х	ACI 318: 5.11-5.13				
VERIFICATION OF IN-SITU CONCRETE STRENGTH, PRIOR TO REMOVAL OF SHORES AND FORMS FROM BEAMS AND STRUCTURAL SLABS		Х	ACI 318: 6.2				
FF AND FL SLAB ON GRADE FLATNESS TESTING			ASTM E1155				

DEMOLITION LEGEND

	NOT IN SCOPE
	EXISTING WALL TO REMAIN
r	EXISTING TO BE DEMOLISHED

DEMOLITION NOTES

1. THE TOTAL AMOUNT OF DEMOLITION REQUIRED FOR THE PROJECT IS NOT INDICATED ON THE DEMOLITION PLANS. THEY ARE INCLUDED FOR THE CONVENIENCE OF THE CONTRACTOR. THEY INDICATE THE GENERAL EXTENT OF THE REMOVAL WORK REQUIRED. IT IS THE CONTRACTOR'S RESPONSIBILITY TO FULLY INSPECT THE BUILDING AND VERIFY ALL CONDITIONS AND FULL EXTENT OF DEMOLITION PRIOR TO SUBMITTING BID.

2. THE SUBCONTRACTORS FOR PLUMBING, ELECTRICAL, HVAC AND FIRE PROTECTION ARE RESPONSIBLE FOR ESTABLISHING THE SCOPE OF DEMOLITION REQUIRED TO PERFORM THE WORK FOR THEIR RESPECTIVE TRADE. DEMOLITION DRAWINGS FOR THESE DISCIPLINES ARE INCLUDED FOR THE CONVENIENCE OF THE CONTRACTOR.

3. MAINTAIN BUILDING IN STRUCTURALLY SOUND CONDITION AT ALL TIMES. DO NOT REMOVE ANY PORTION OF THE BUILDING STRUCTURE INCLUDING COLUMNS, LOAD BEARING WALLS, BEAMS FLOOR CONSTRUCTION, PERIMETER WALLS OR FIREPROOFING OF STRUCTURAL ELEMENTS UNLESS SPECIFICALLY NOTED.

4. PROTECT ALL FINISHES AND COMPONENTS OF BUILDING WHICH ARE TO REMAIN. ANY DAMAGED MATERIAL, EQUIPMENT OR ITEMS TO REMAIN SHALL BE REPAIRED OR REPLACED TO MATCH EXISTING CONSTRUCTION, AND ARE THE RESPONSIBILITY OF THE

5. VERIFY CONCEALED CONSTRUCTION CONDITIONS PRIOR TO REMOVAL OF ANY ITEMS. CAREFULLY ASSESS EACH ITEM TO BE REMOVED FOR DETRIMENTAL RESULTS IF REMOVED. PERFORM EXPLORATORY DEMOLITION TO DETERMINE METHODS OF ATTACHMENTS, UTILITY INTERFACES, INTERCONNECTIONS AND OTHER CONCEALED CONDITIONS PRIOR TO DEMOLITION.

6. ITEMS DESIGNATED TO BE REMOVED AND SALVAGED SHALL BE DELIVERED TO A SAFE REMOTE LOCATION FOR RETROFITTING OR A SAFE LOCATION ON SITE FOR CLEANING AND STORAGE BY THE CONTRACTOR.

7. MAINTAIN CODE COMPLIANT AND UNOBSTRUCTED EXIT PATHS AT ALL TIMES.

8. PRIOR TO DEMOLITION WORK, THE CONTRACTOR SHALL ASSESS AND IDENTIFY UTILITIES WITHIN THE DEMOLITION AREA THAT SERVE OCCUPIED SPACES OUTSIDE OF THE AREA OF THAT PHASE OF WORK. THOSE UTILITIES SHALL BE PROTECTED AND RESUPPORTED WHERE NECESSARY TO MAINTAIN CONTINUITY OF SERVICE.

9. AREAS SURROUNDING THE AREA OF THIS CONTRACT SHALL REMAIN FULLY OCCUPIED DURING THE WORK. CAREFULLY SCHEDULE AND COORDINATE THIS WORK WITH THE OWNER TO MINIMIZE DISRUPTION TO ANY ACTIVITIES. SOME OF THE WORK MAY NEED TO BE PERFORMED OFF HOURS.

10. WHERE PARTIAL DEMOLITION IS NOT INDICATED BUT IS NECESSARY TO PERFORM NEW WORK, THAT AREA SHALL BE REMOVED AS NECESSARY AND REFINISHED/REPLACED TO MATCH THE EXISTING CONTIGUOUS CONSTRUCTION.

11. REMOVE FLOOR FINISHES IN ALL DEMOLITION AREAS UNLESS OTHERWISE NOTED.

DEMOLITION KEY NOTES

- WALL TO BE DEMOLISHED.
 DOOR AND FRAME TO BE REMOVED AND SAVED
- DOOR AND FRAME TO BE REMOVED AND SAVED FOR OWNER.
 REMOVE EXISTING VAPOR BARRIER TO PREPARE FOR NEW CONSTRUCTION. PREPARE SUB BASE
- FOR NEW CONSTRUCTION. PREPARE SUB BASE
 FOR NEW VAPOR BARRIER AND CONCRETE SLAB
 TO CONNECT TO EXISTING.
 4 ALL SOLID SURFACE WAINSCOTTING AND
- ARTWORK RECESSES TO BE REMOVED ON THIS WALL. PATCH, REPAIR, AND PAINT TO MATCH ADJACENT DRYWALL TO EAST.
- 5 CONTRACTOR TO INSPECT PERIMETER WALL FOR MISSING COMPONENTS AND DAMAGE
- REQUIRED FOR NEW CONSTRUCTION WORK.
 SALVAGE FIRE EXTINGUISHER CABINET FOR RELOCATION

Pr	oject	t No
1	91	30

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Demolition Plan and Slab on Grade Plan

A1.0

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Respiratory Therapy

Joliet Junior College

130 East Randolph Suite 1850 Chicago IL 60601 312.786.1204p esadesign.com

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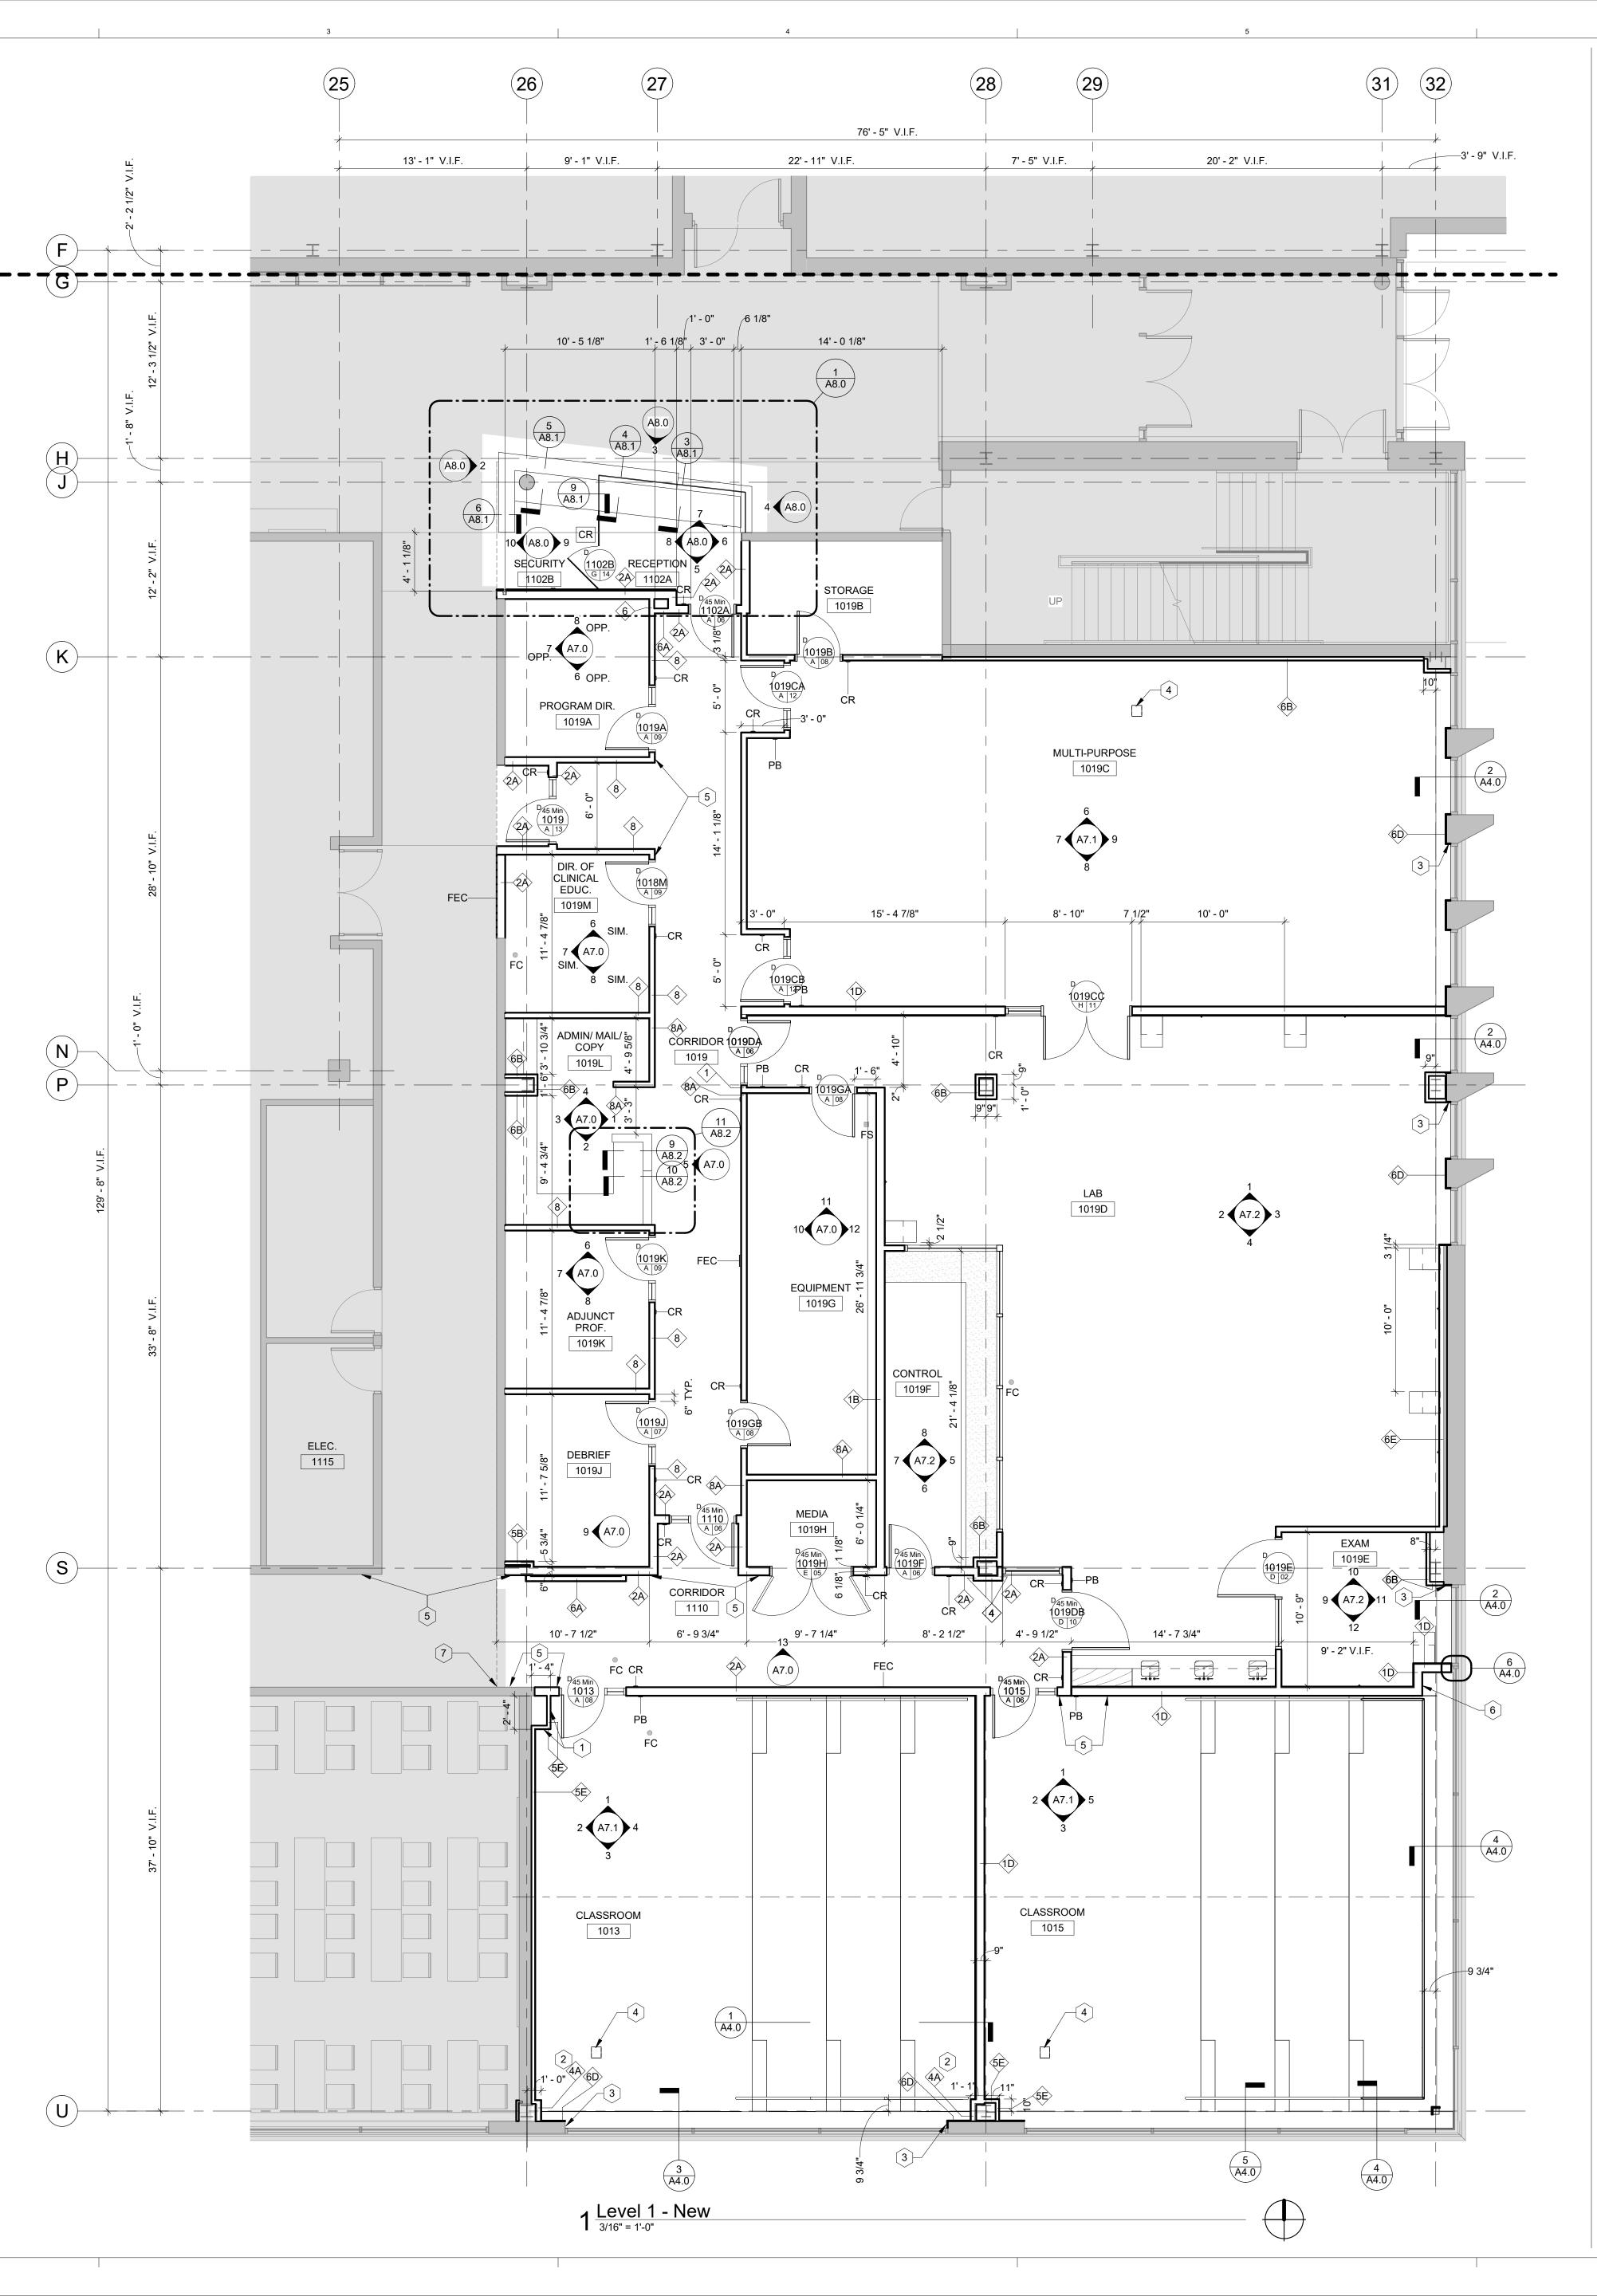
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Key Plan

MEP/AV
Affiliated Engineers, Inc. (AEI)
Structural
Helen Torres & Associates, PLLC

DATE: 11/30/2020 11:58:40 AM FILE: C:\Users\rpate\\Documents\19130 JJC Respiratory Therapy (rpatel).rv



-

PLAN LEGEND

- O FLOOR CLEANOUT
- (FC) FLOOR SINK (FS)

PLAN NOTES

1. ALL PARTITIONS TO BE TYPE 1 AND FURRING TO BE TYPE 5B U.N.O. REFER TO SHEET A9.0 FOR PARTITION TYPES. PATCH AND REPAIR EXISTING DRYWALL AS REQUIRED TO ACHIEVE A UNIFORM SURFACE.

2. PARTITIONS TO BE CENTERED ON CENTER OF WINDOW MULLION PER DETAIL, U.N.O.

3. RATED ASSEMBLIES SHALL BE ERECTED IN ENTIRETY PRIOR TO NON-RATED ASSEMBLIES. REFER TO LIFE SAFETY DRAWINGS FOR EXTENT OF RATED PARTITIONS.

4. ALL DIMENSIONS ARE TO FACE OF GYPSUM PARTITION U.N.O. SEE FINISH SCHEDULE ON A11 SHEET SERIES AND ELEVATIONS ON A7 SHEET SERIES FOR APPLIED FINISHES (PAINT, VINYL WALLCOVERING, ETC.)

5. A SURVEY OF ALL FLOOR SURFACES SHALL BE MADE PRIOR TO CONSTRUCTION TO DETERMINE OUT-OF-LEVEL CONDITIONS THAT WOULD PROHIBIT THE LEVEL PLACEMENT OF FLOORING, FILES, FURNITURE OR INTERFERE WITH THE INSTALLATION OF ARCHITECTURAL OR MILLWORK ELEMENTS.

6. GENERAL CONTRACTOR AND SUBCONTRACTORS SHALL BE RESPONSIBLE FOR COORDINATING THE WORK OF ALL ARCHITECTURAL DRAWINGS WITH ARCHITECTURAL SCHEDULES. ANY DISCREPANCY REASONABLY DISCOVERABLE WITH DUE DILIGENCE SHALL BE NOTED AS A

QUALIFICATION TO THE GENERAL CONTRACTOR'S BID SUBMISSION. ANY REASONABLY DISCOVERABLE DISCREPANCY NOT INDICATED AS A QUALIFICATION SHALL BE CONSTRUED IN FAVOR OF THE OWNER AT NO COST.

7. PROVIDE CONTROL JOINTS AT 30' MAX. INTERVALS, OR WHEN APPROPRIATE, IN GYP.

8. FIELD VERIFY ALL DIMENSIONS LOCATED IN EXISTING CONSTRUCTION PRIOR TO PROCEEDING WITH ANY WORK.

9. PROVIDE ACCESS PANELS WHERE PLUMBING AND HEATING VALVES, WATER SWITCHES, OXYGEN PRESSURE SWITCHES, VENTILATION SPLITTER DAMPERS, ETC. ARE SHOWN ON MEP DRAWINGS. COORDINATE FINAL LOCATION WITH ARCHITECT.

10. FURNITURE N.I.C, SHOWN FOR REFERENCE AND COORDINATION PURPOSES.

11. "CARD READER" AND "PANIC BUTTON" LOCATIONS ARE INDICATED ON THE PLAN AS "CR" AND "PB". AT PANIC BUTTON LOCATIONS, CONRACTOR TO PROVIDE JUNCTION BOX W/ SINGLE GANG COVER, STUB 1/2" CONDUIT 12" ABOVE CEILING (JJC WILL PROVIDE AND INSTALL PANIC BUTTON WITH JUNCTION BOX 44" A.F.F. TO CENTER OF BOX). REFER TO ELECTRICAL AND TECHNOLOGY DRAWINGS.

SHEET NOTES (1)

- 1 ACCESS PANEL. COORDINATE WITH MEPFP.
- 2 SHAFT WALL PARTITION FOR ACOUSTIC CONTINUITY. NOT REQUIRED TO BE RATED.
- 3 PROVIDE 5/8" GYPSUM BOARD OVER EXISTING BLOCKING. CAULK JOINT TO FRAME. TYPICAL AT
- JAMBS. 4 ELEC/DATA ELOOR BOX, COORDINATE EXACT
- 4 ELEC/DATA FLOOR BOX. COORDINATE EXACT LOCATION WITH PODIUM AND CONSULT WITH JJC.
 5 ALIGN
- 6 OUTSIDE FACE OF PARTITION SHALL CLEAR EXISTING LIGHT SHELF BY 1". CONTINUE ELEVATED SLAB IN NICHE.
- ELEVATED SLAB IN NICHE. 7 PROVIDE CONTROL JOINT ALIGNED WITH CORNER TO THE NORTH TO PROVIDE A STOPPING POINT FOR NEW PAINT.

Project No. 19130

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Sheet Title

Floor Plan

1215 Houbolt Rd, Joliet, IL 60431

Respiratory Therapy

A1.1

Joliet Junior College

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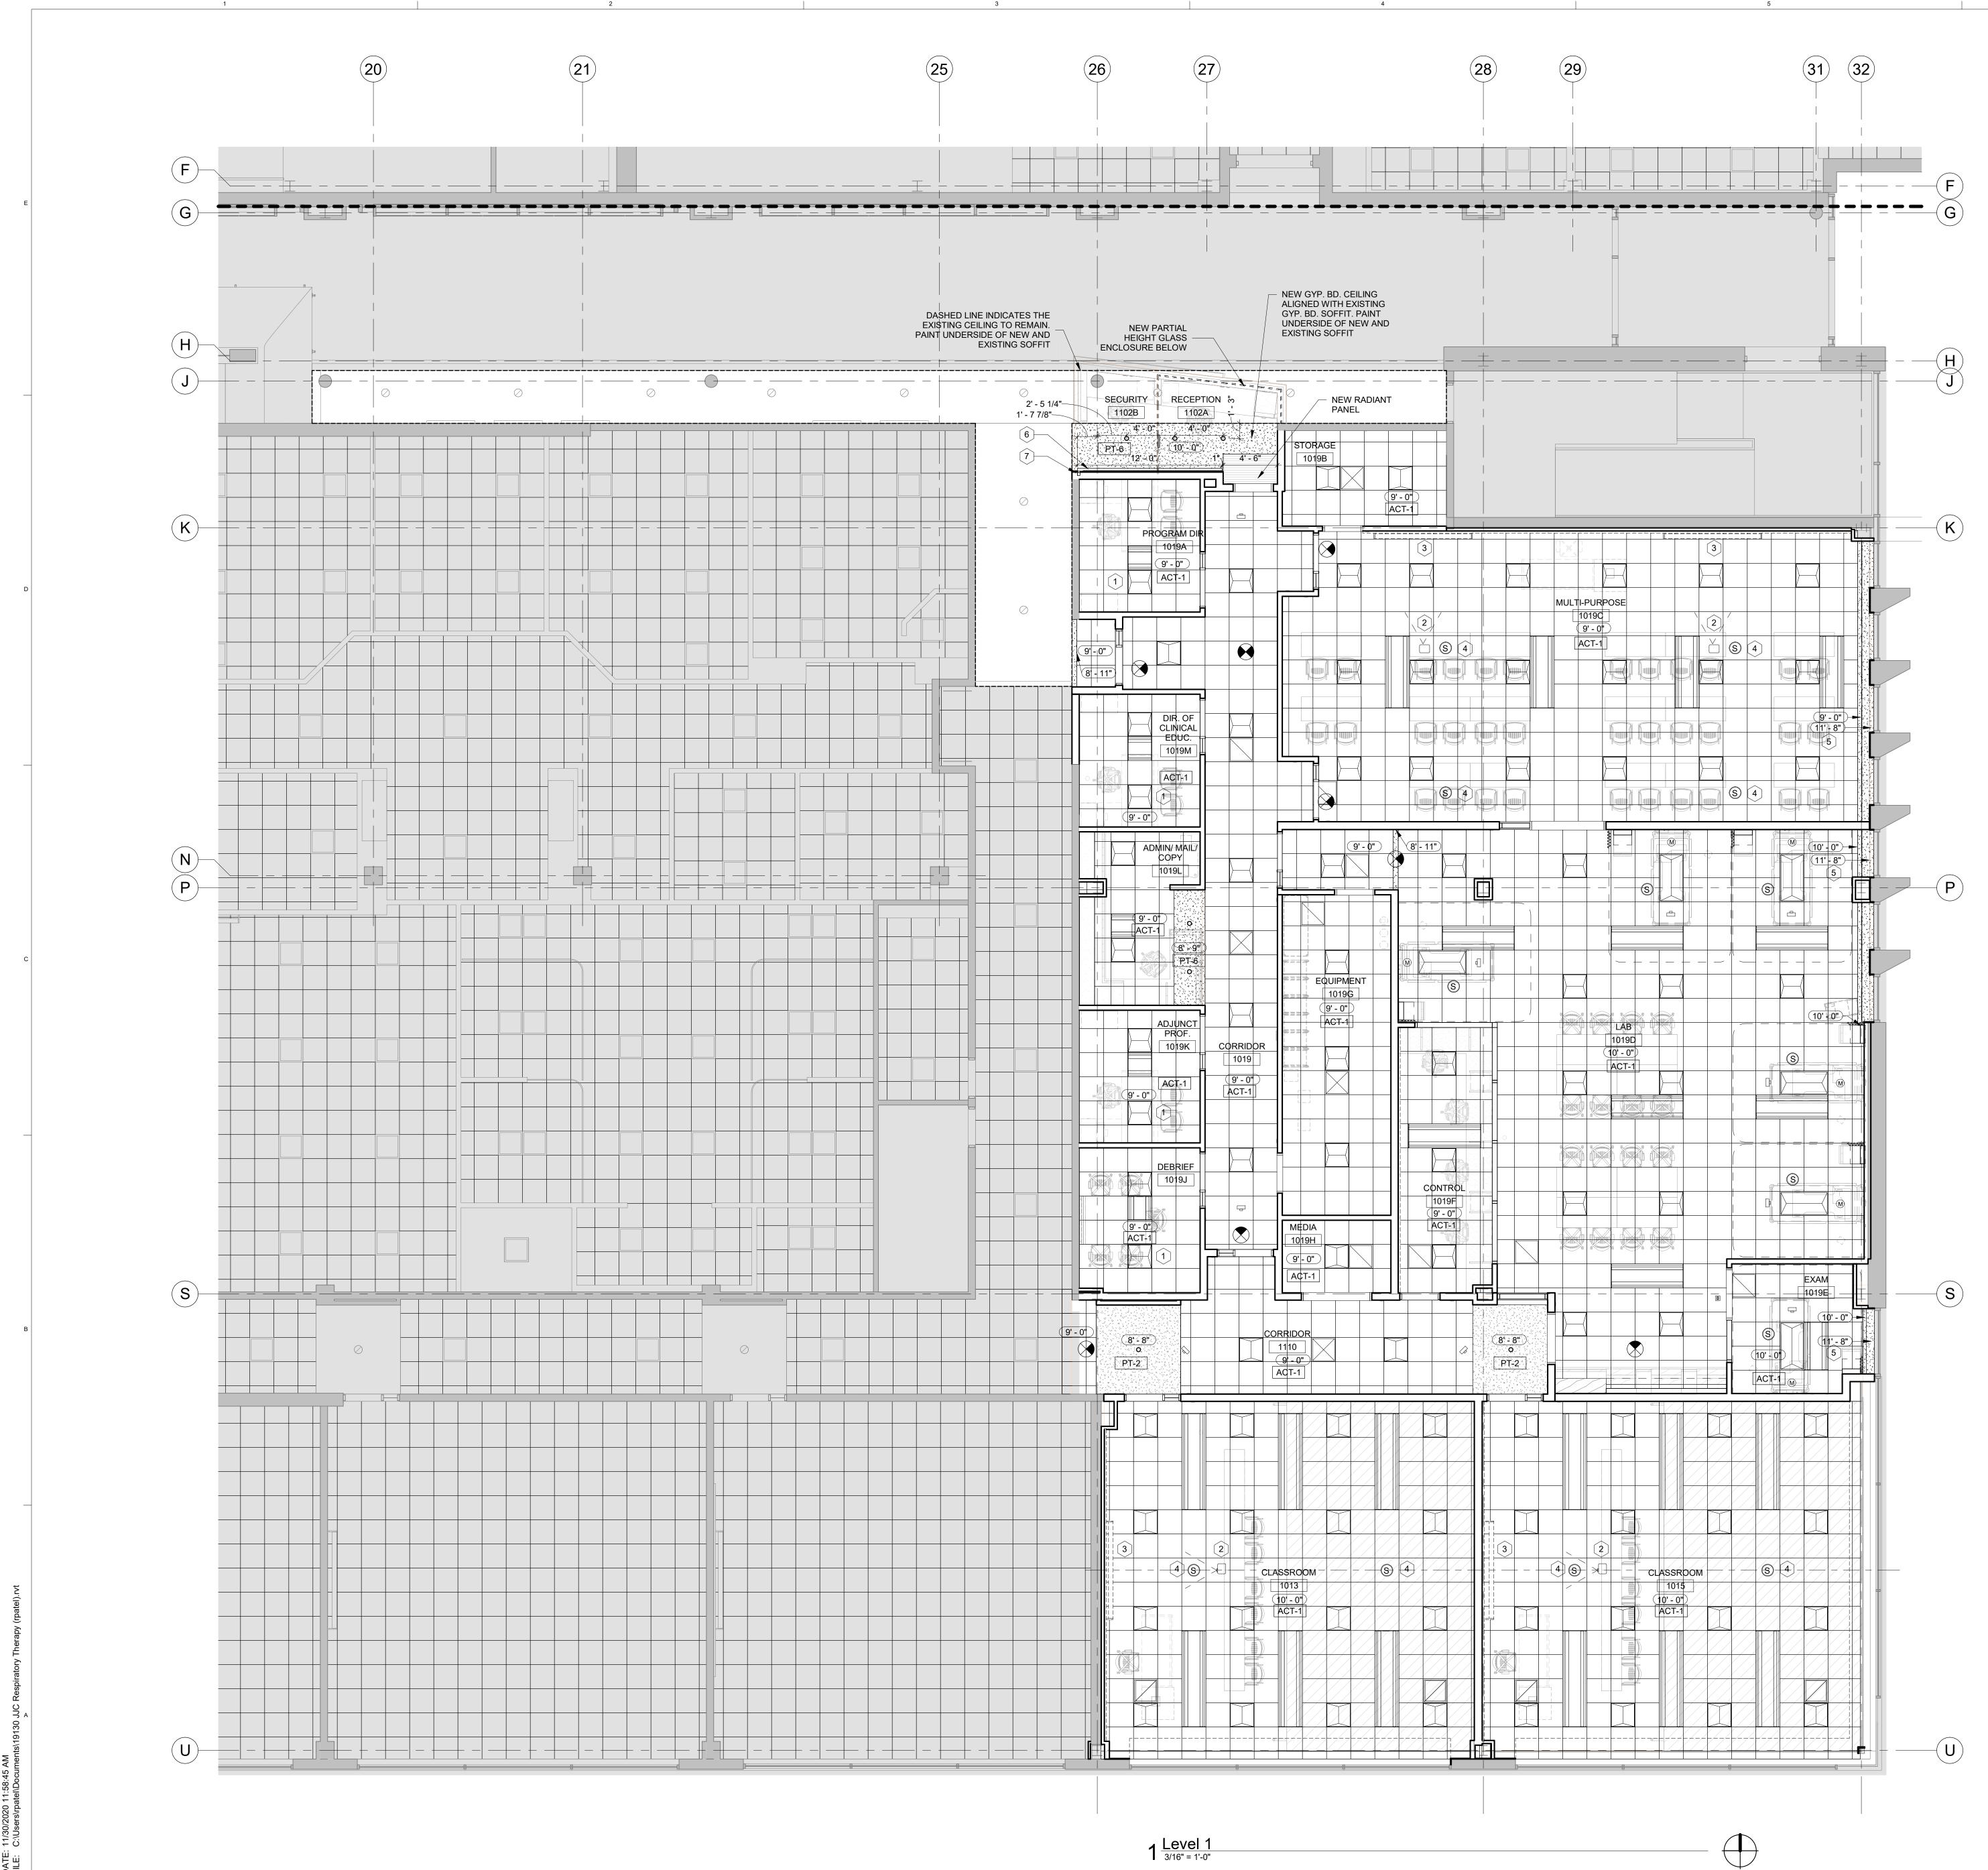
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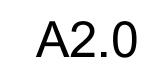


RCP LEG	GEND
	2 x 2 SUSPENDED CEILING WITH ACOUSTICAL CEILING TILE.
	GYP. BD. CEILING
	WOOD PANEL
0	RECESSED DOWNLIGHT FIXTURE
	2 X 2 FLUORESCENT LIGHT FIXTURE
	2 X 4 FLUORESCENT LIGHT FIXTURE
>{	1 X 4 LIGHT FIXTURE
	RECESSED LINEAR FIXTURE
Ξ	DOME LIGHT / NURSE CALL
\bigotimes	EXIT SIGN (ONE-SIDE)
	EXIT SIGN (TWO-SIDE)
	CAMERA
	PROJECTOR
S	SPEAKER
M	MICROPHONE
	2 x 2 SUPPLY DIFFUSER
	2 x 2 RETURN DIFFUSER
	CHILLED BEAM
/	
	CURTAIN TRACK
	TES
REFER TO ELECTRI	CAL DRAWINGS FOR FIXTURE
	DRAWINGS FOR CEILING ALL DEVICES MAY NOT BE ACHITETURAL RCP.

SHEET NOTES ⁽⁾

- EXTEND ALL UNRATED PERIMETER WALLS 12" ABOVE CEILING AND LAY BATT INSULATION OVER 1 ACT TO PROVIDE ADDITIONAL ACOUSTIC PRIVACY FOR OFFICES. SEE PARTITION TYPES FOR MORE INFORMATION.
- JJC WILL PROVIDE PROJECTOR AND CEILING PROJECTOR PLATES. COORDINATE LOCATION WITH 2 JJC.
- JJC WILL PROVIDE SCREEN. COORDINATE LOCATION 3 WITH JJC. 4 COORDINATE LOCATION OF SPEAKERS WITH JJC. COORDINATE EXACT HEIGHT OF GYPSUM POCKET WITH SHADE ENCLOSURE. PREFABRICATED SHADE 5
- POCKET SHALL ALIGN WITH BOTTOM OF HORIZONTAL MULLION. CEILING MOUNT LINEAR LIGHTING WITH CONTINUOUS LENS. BASIS OF DESIGN FOCAL POINT 6
- SEEM 2: FSM2L-TF-375LF-35K-1C-UNV-LD1-XFF-WH-12'
- VERTICAL WALL MOUNT LINEAR LIGHTING WITH CONTINUOUS LENS. BASIS OF DESIGN FOCAL POINT SEEM 2: FSM2L-FL-375LF-35K-1C-UNV-LD1-XFF-WH-9'-8"

Project No. **19130**



Sheet Title **Reflected Ceiling Plan**

1215 Houbolt Rd, Joliet, IL 60431

Respiratory Therapy

Joliet Junior College

No. Date ECKENHOFF SAUNDERS One Prudential Plaza 130 East Randolph Suite 1850 Chicago IL 60601 312.786.1204p esadesign.com

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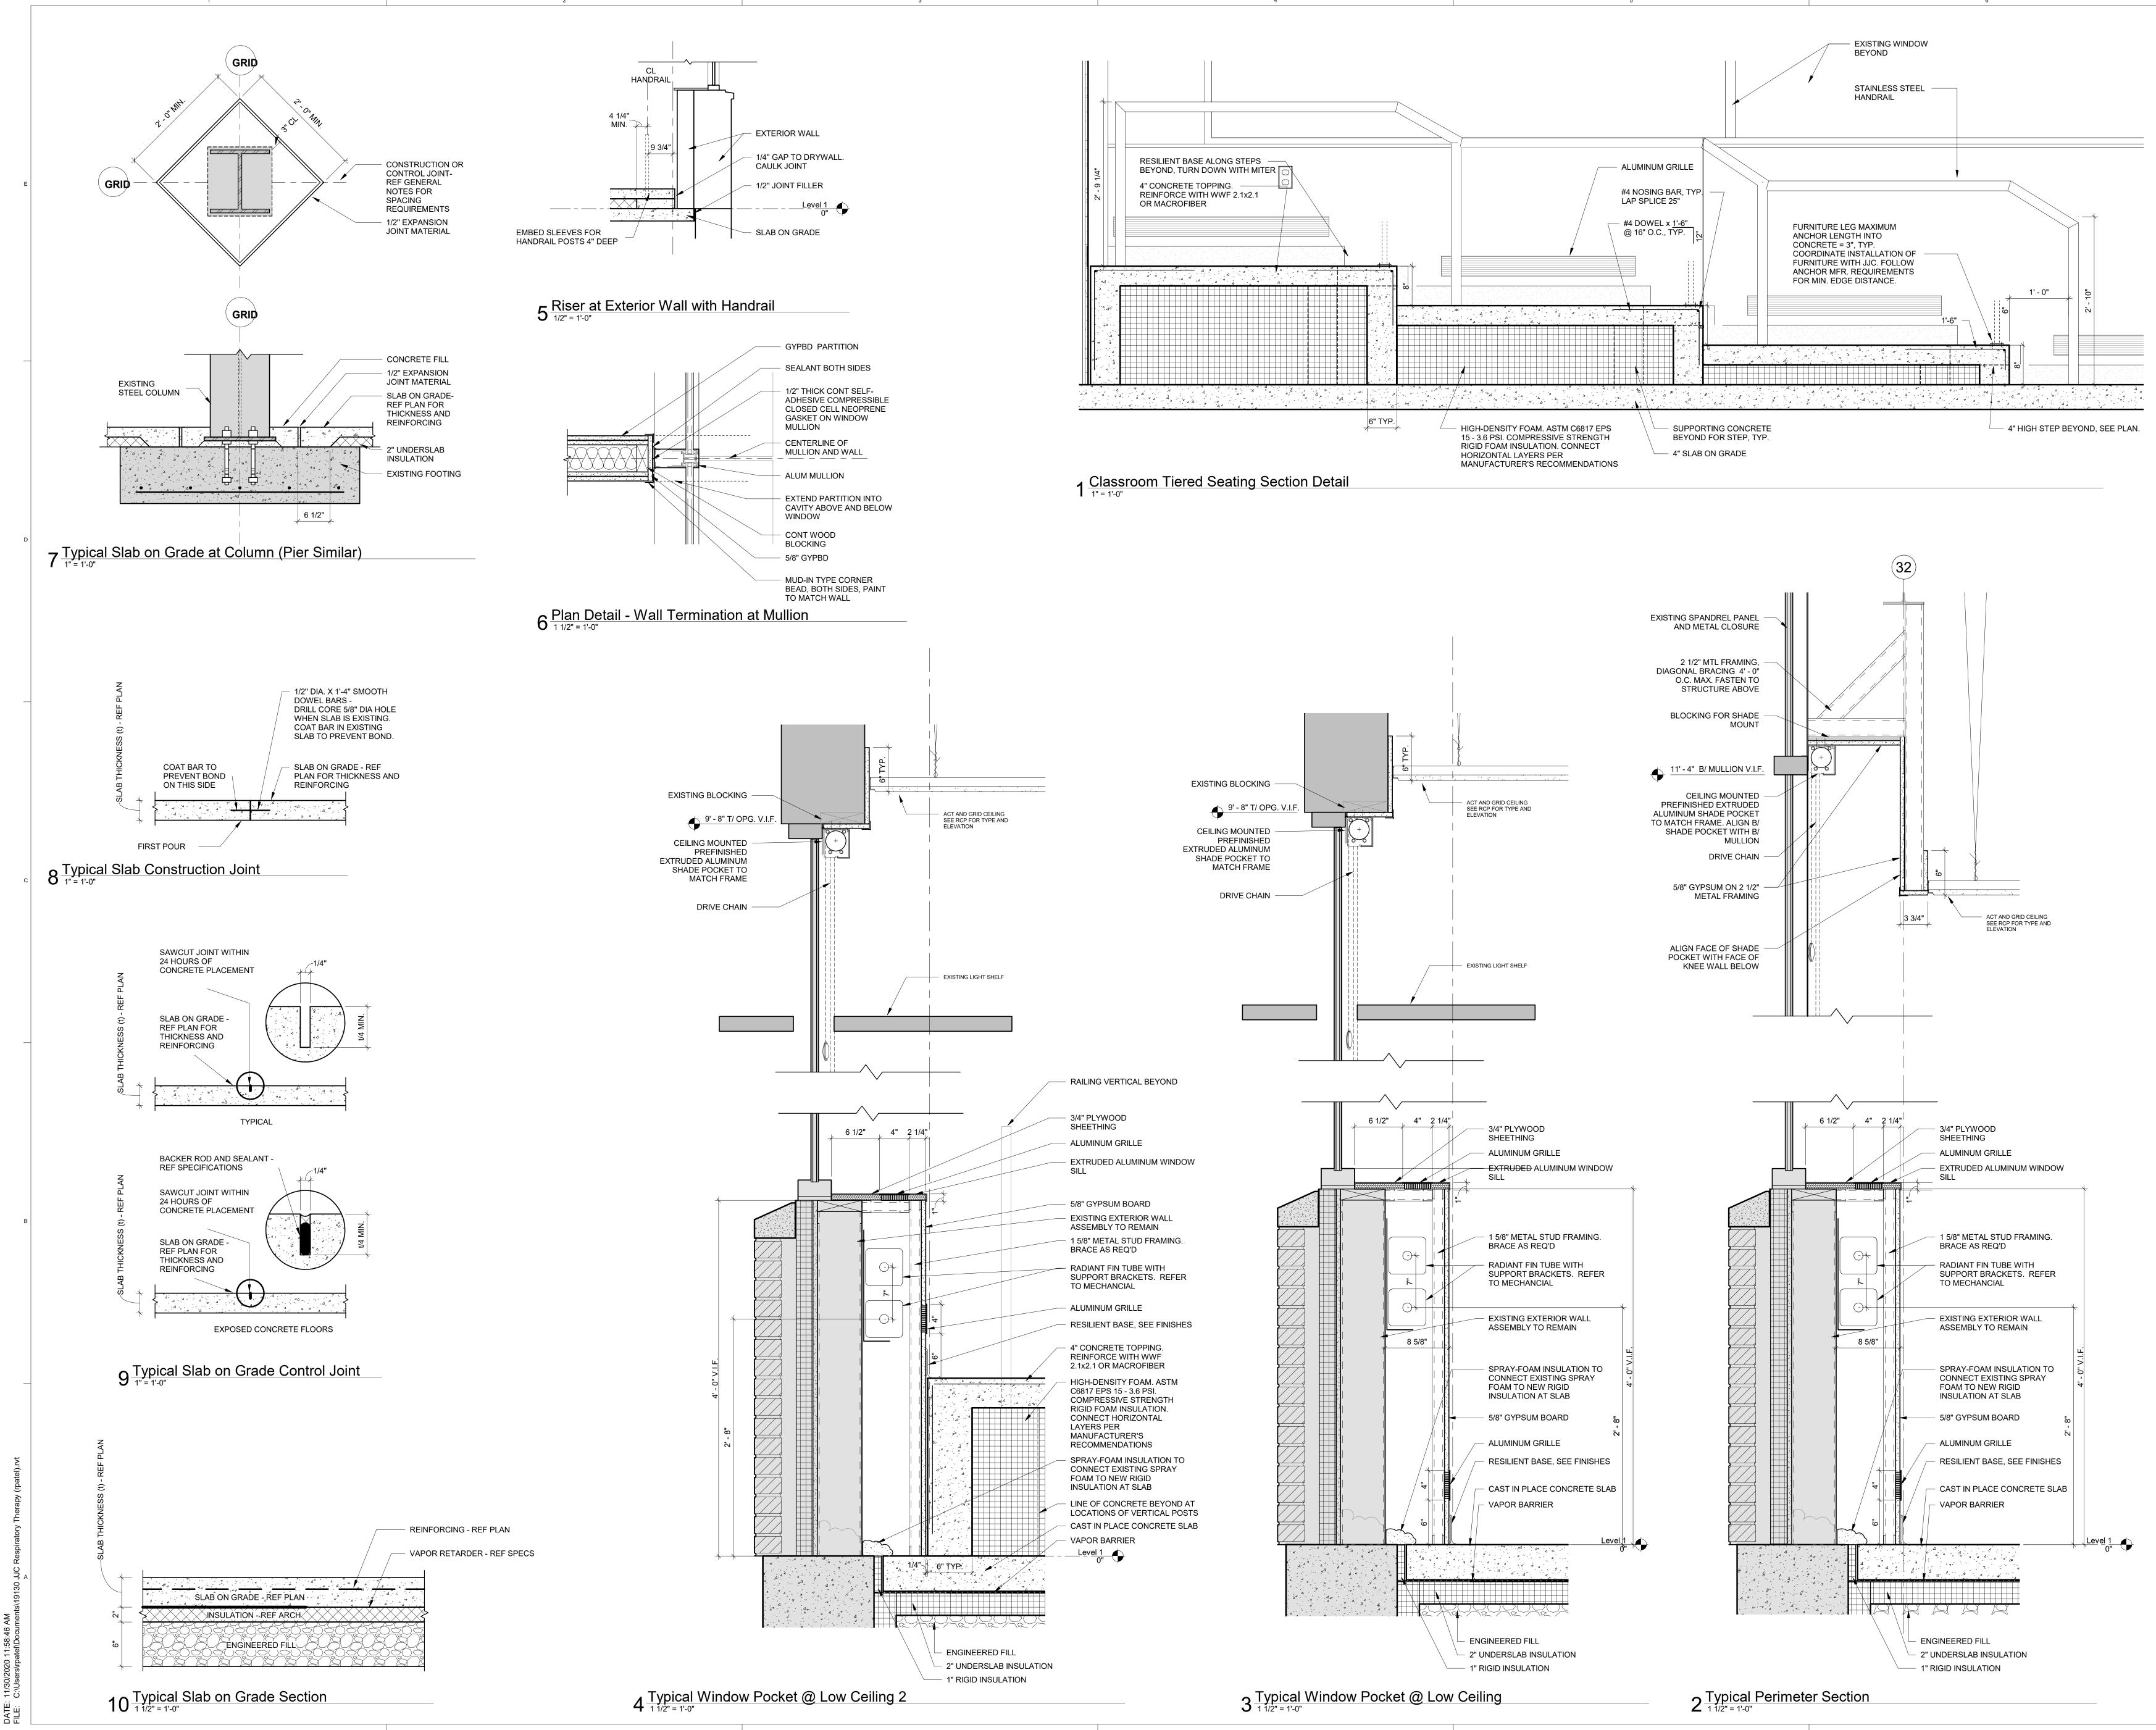
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2 11-19-2020 Issued for JJC Review

1 09-18-2020 Schematic Design / Design Development

Issue Description



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Project No.
19130

Concrete Details

A4.0

Sheet Title Perimeter Sections and


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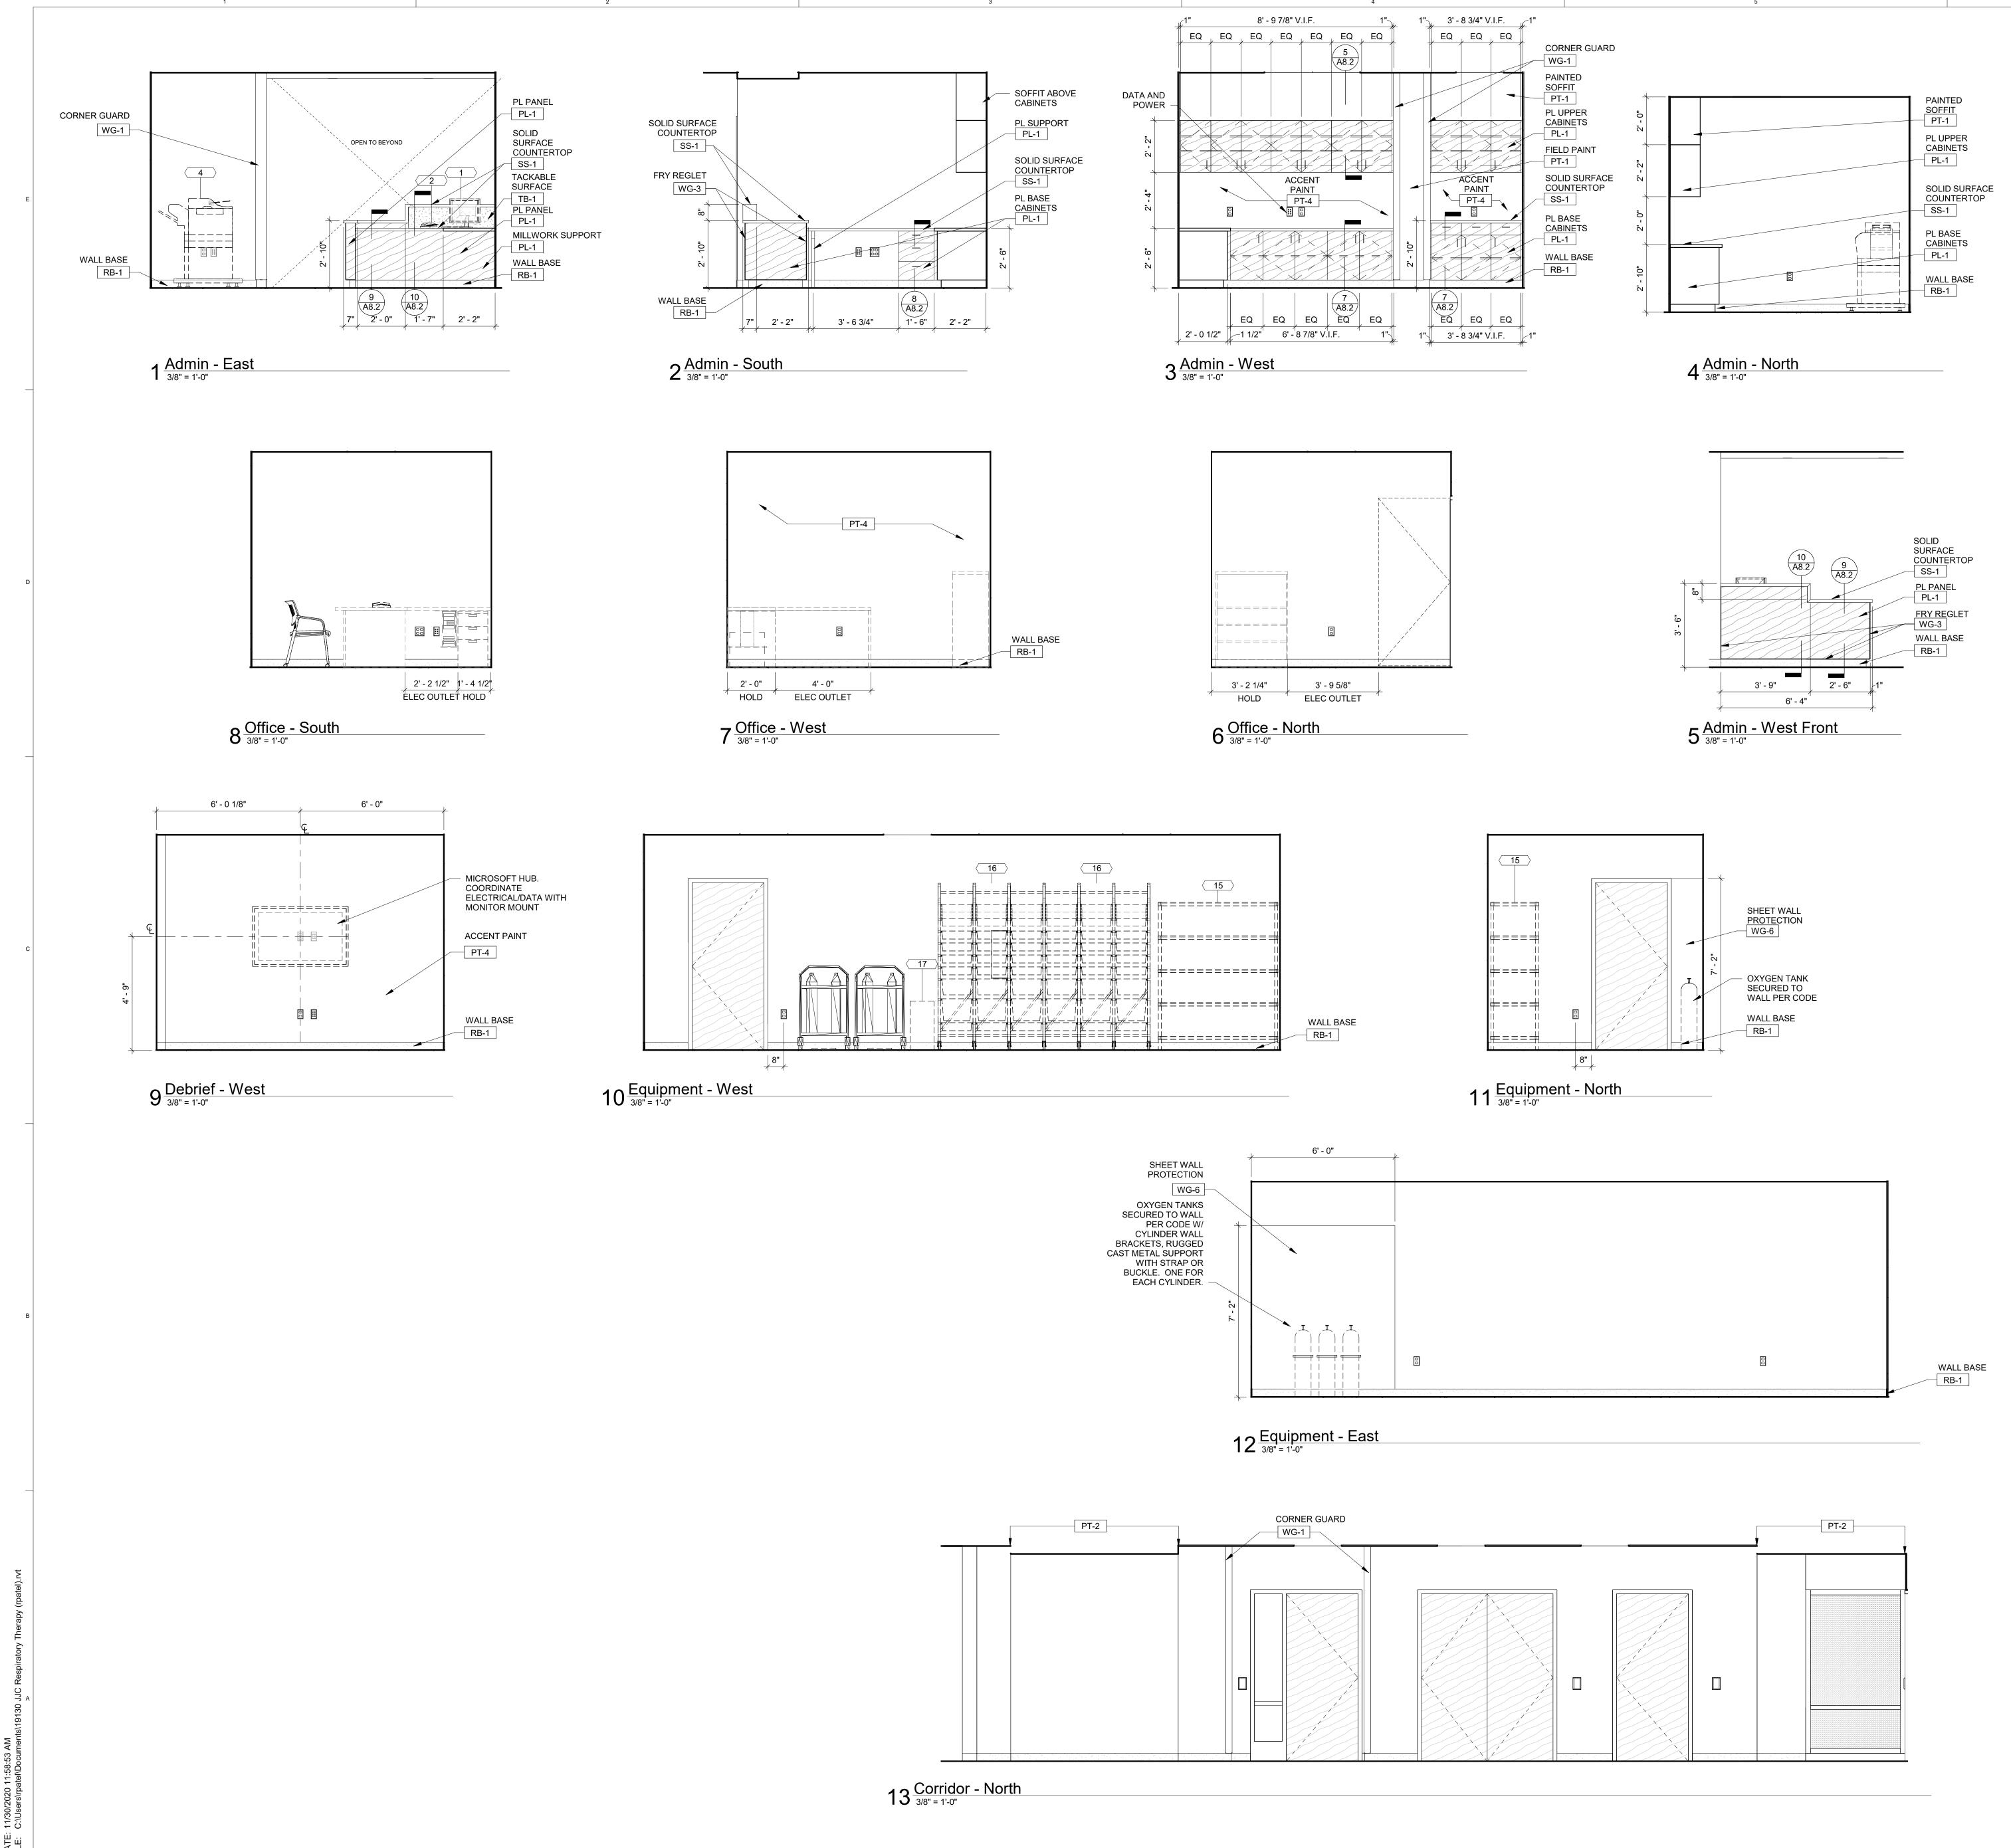


Key Plan


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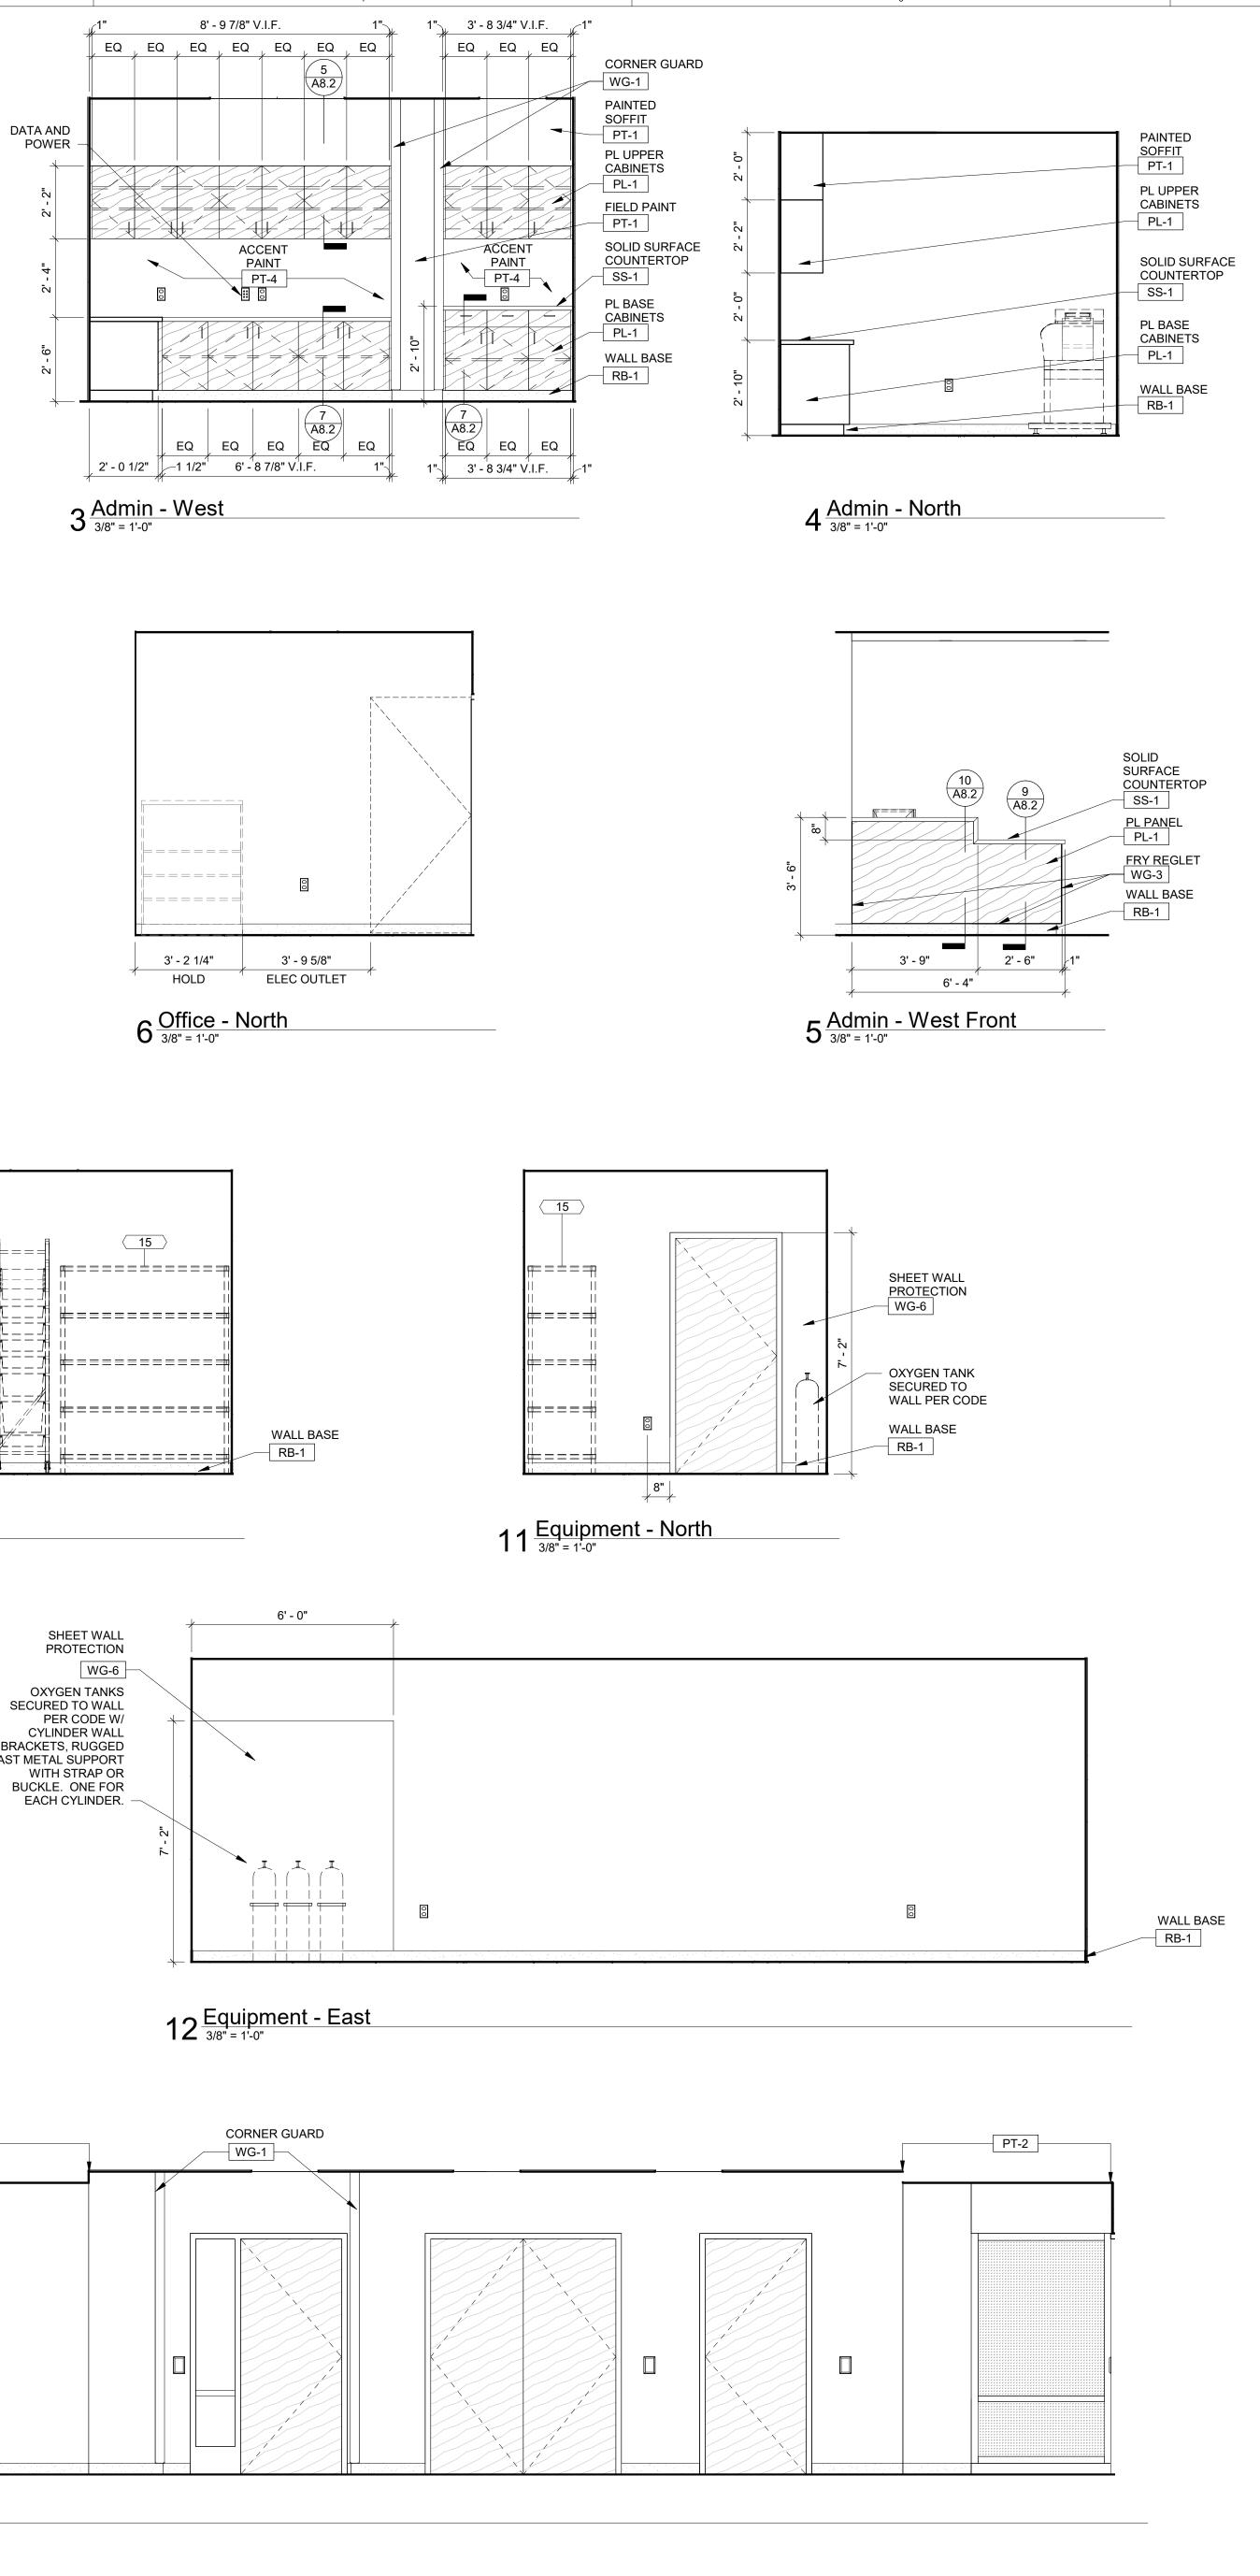
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INT. ELEV. NOTES

1. SEE FINISH PLAN FOR WINDOW TREATMENT TYPE AND LOCATION. 2.REFER TO ELECTRICAL DRAWINGS FOR POWER AND DATA. 3. COORDINATE ELECTRICAL OUTLETS WITH OWNER PROVIDED AND INSTALLED FF&E. 3. FURNITURE SHOWN DASHED BY OWNER.

Project No. **19130**

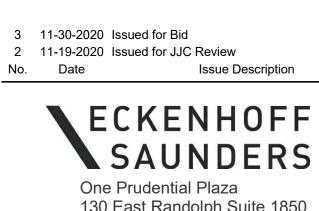

Sheet Title Interior Elevations
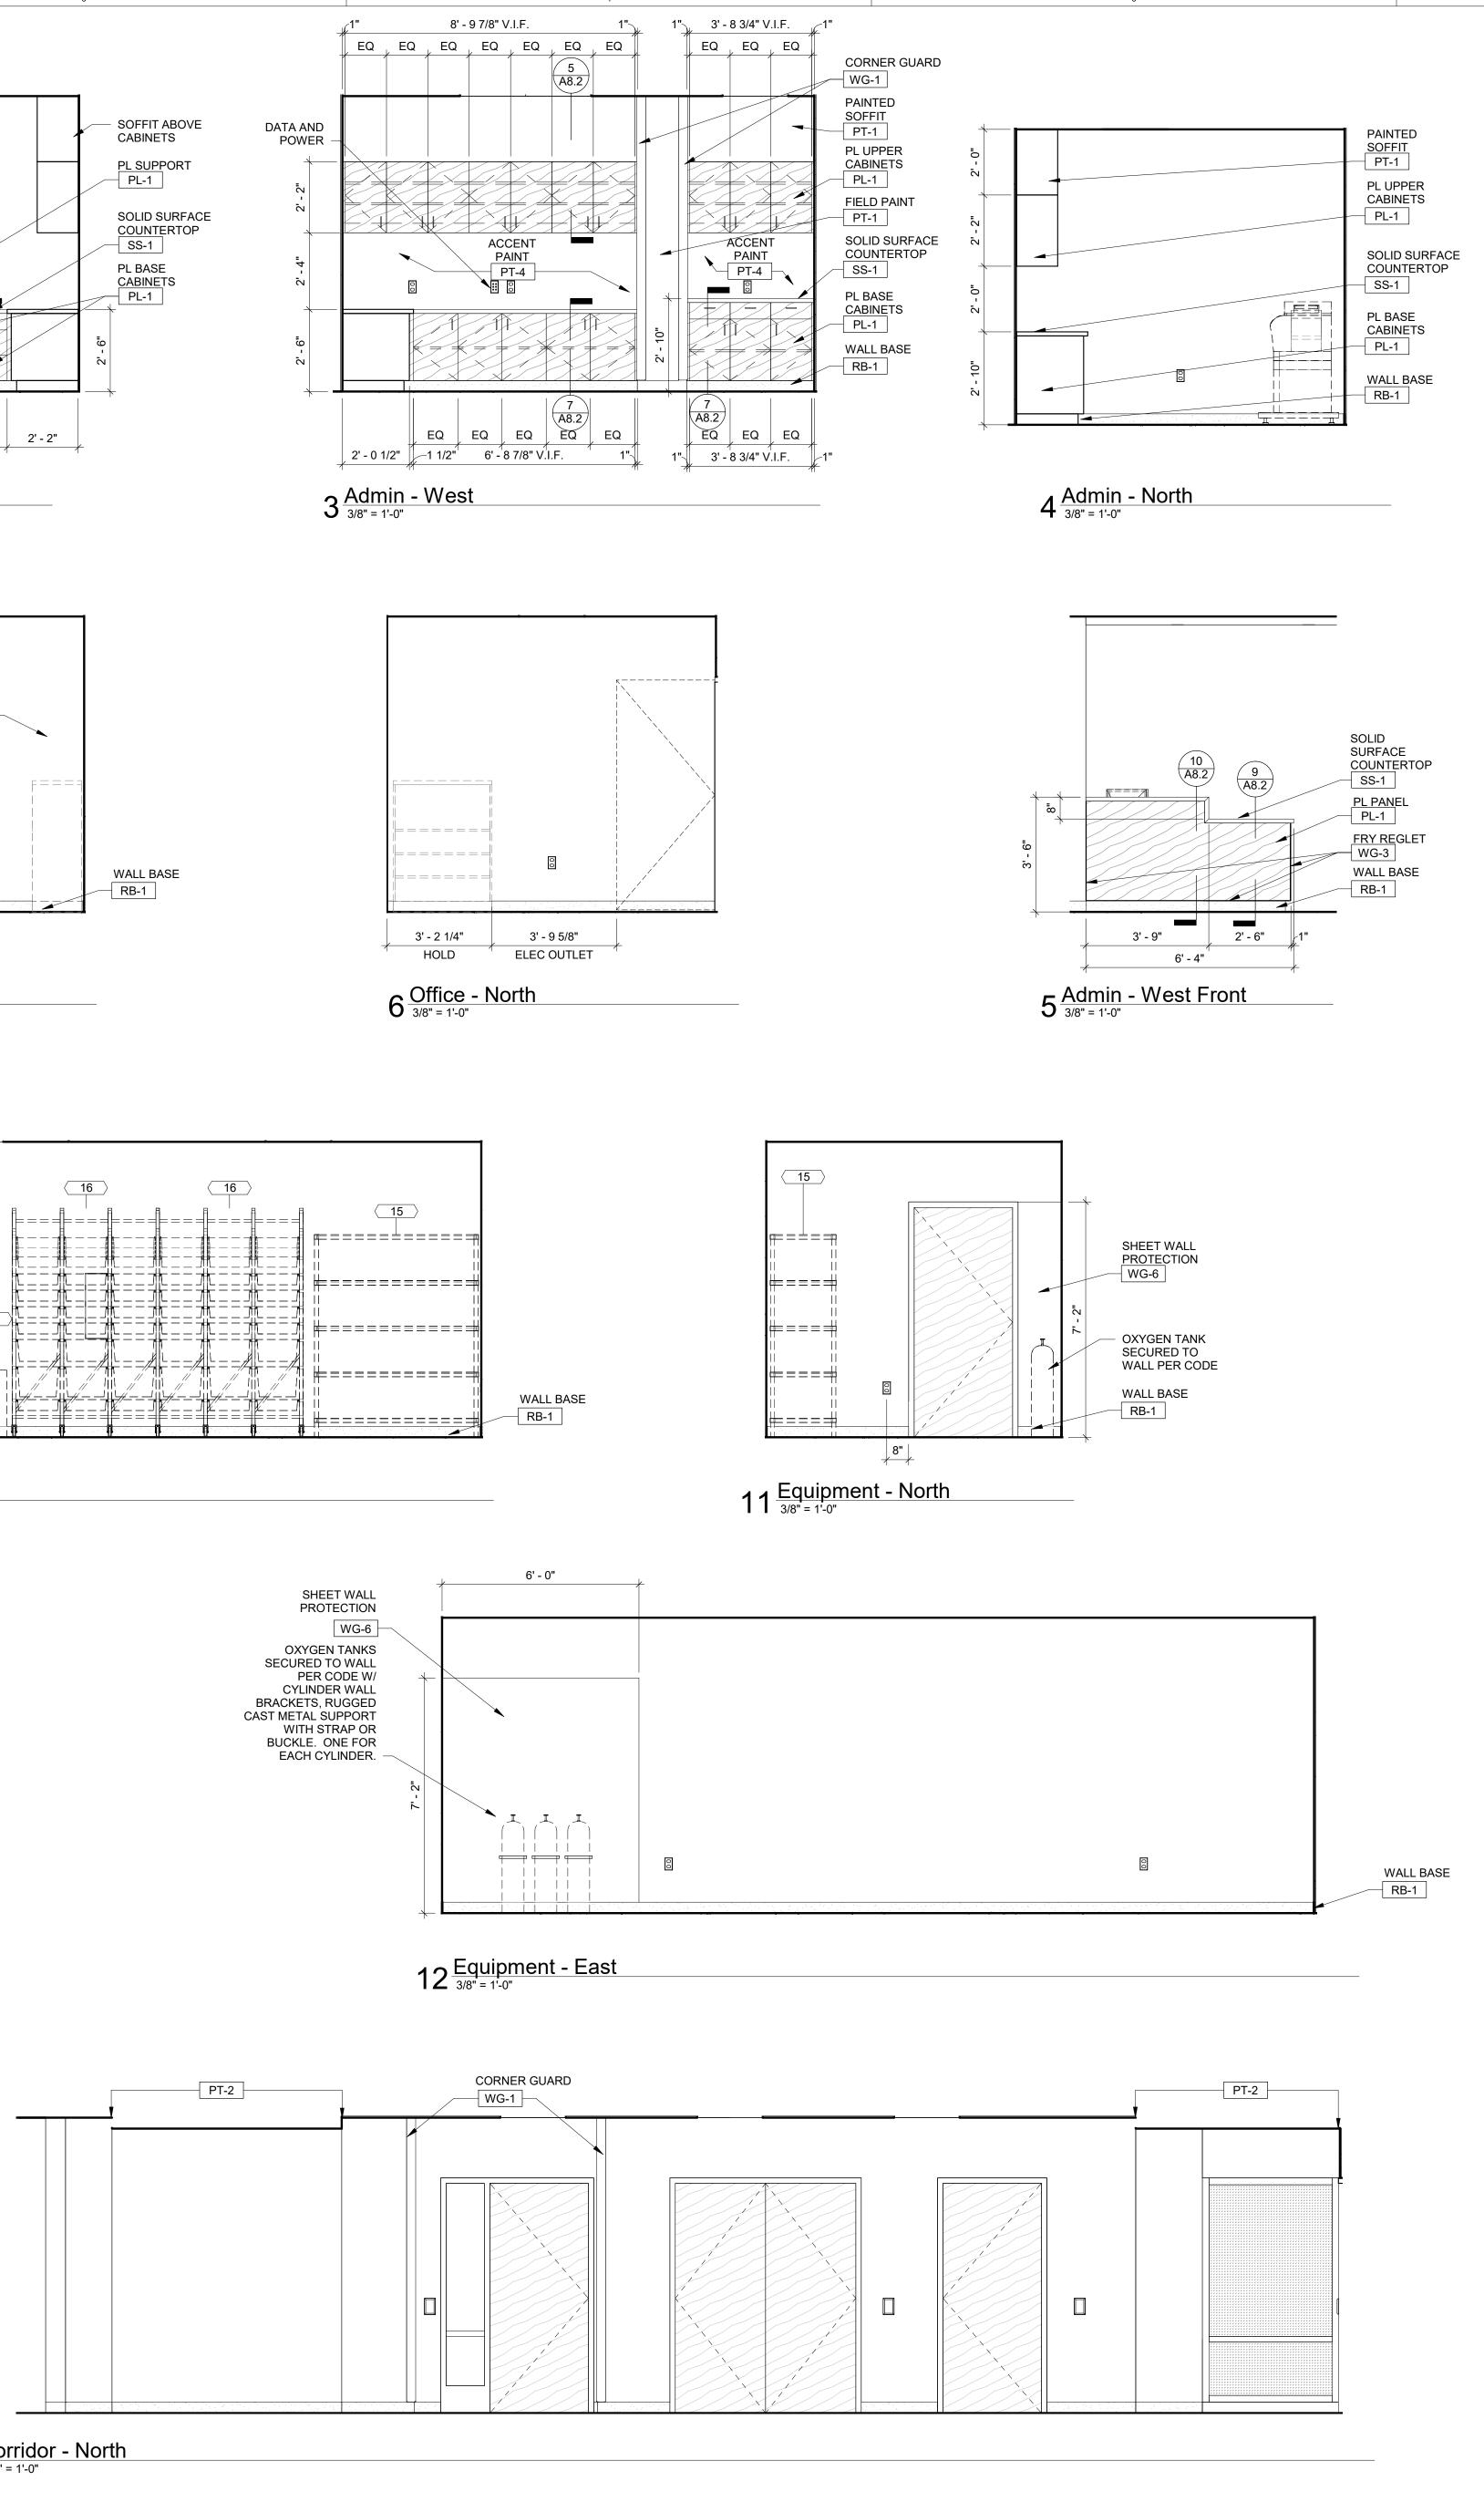
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Respiratory Therapy

Joliet Junior College

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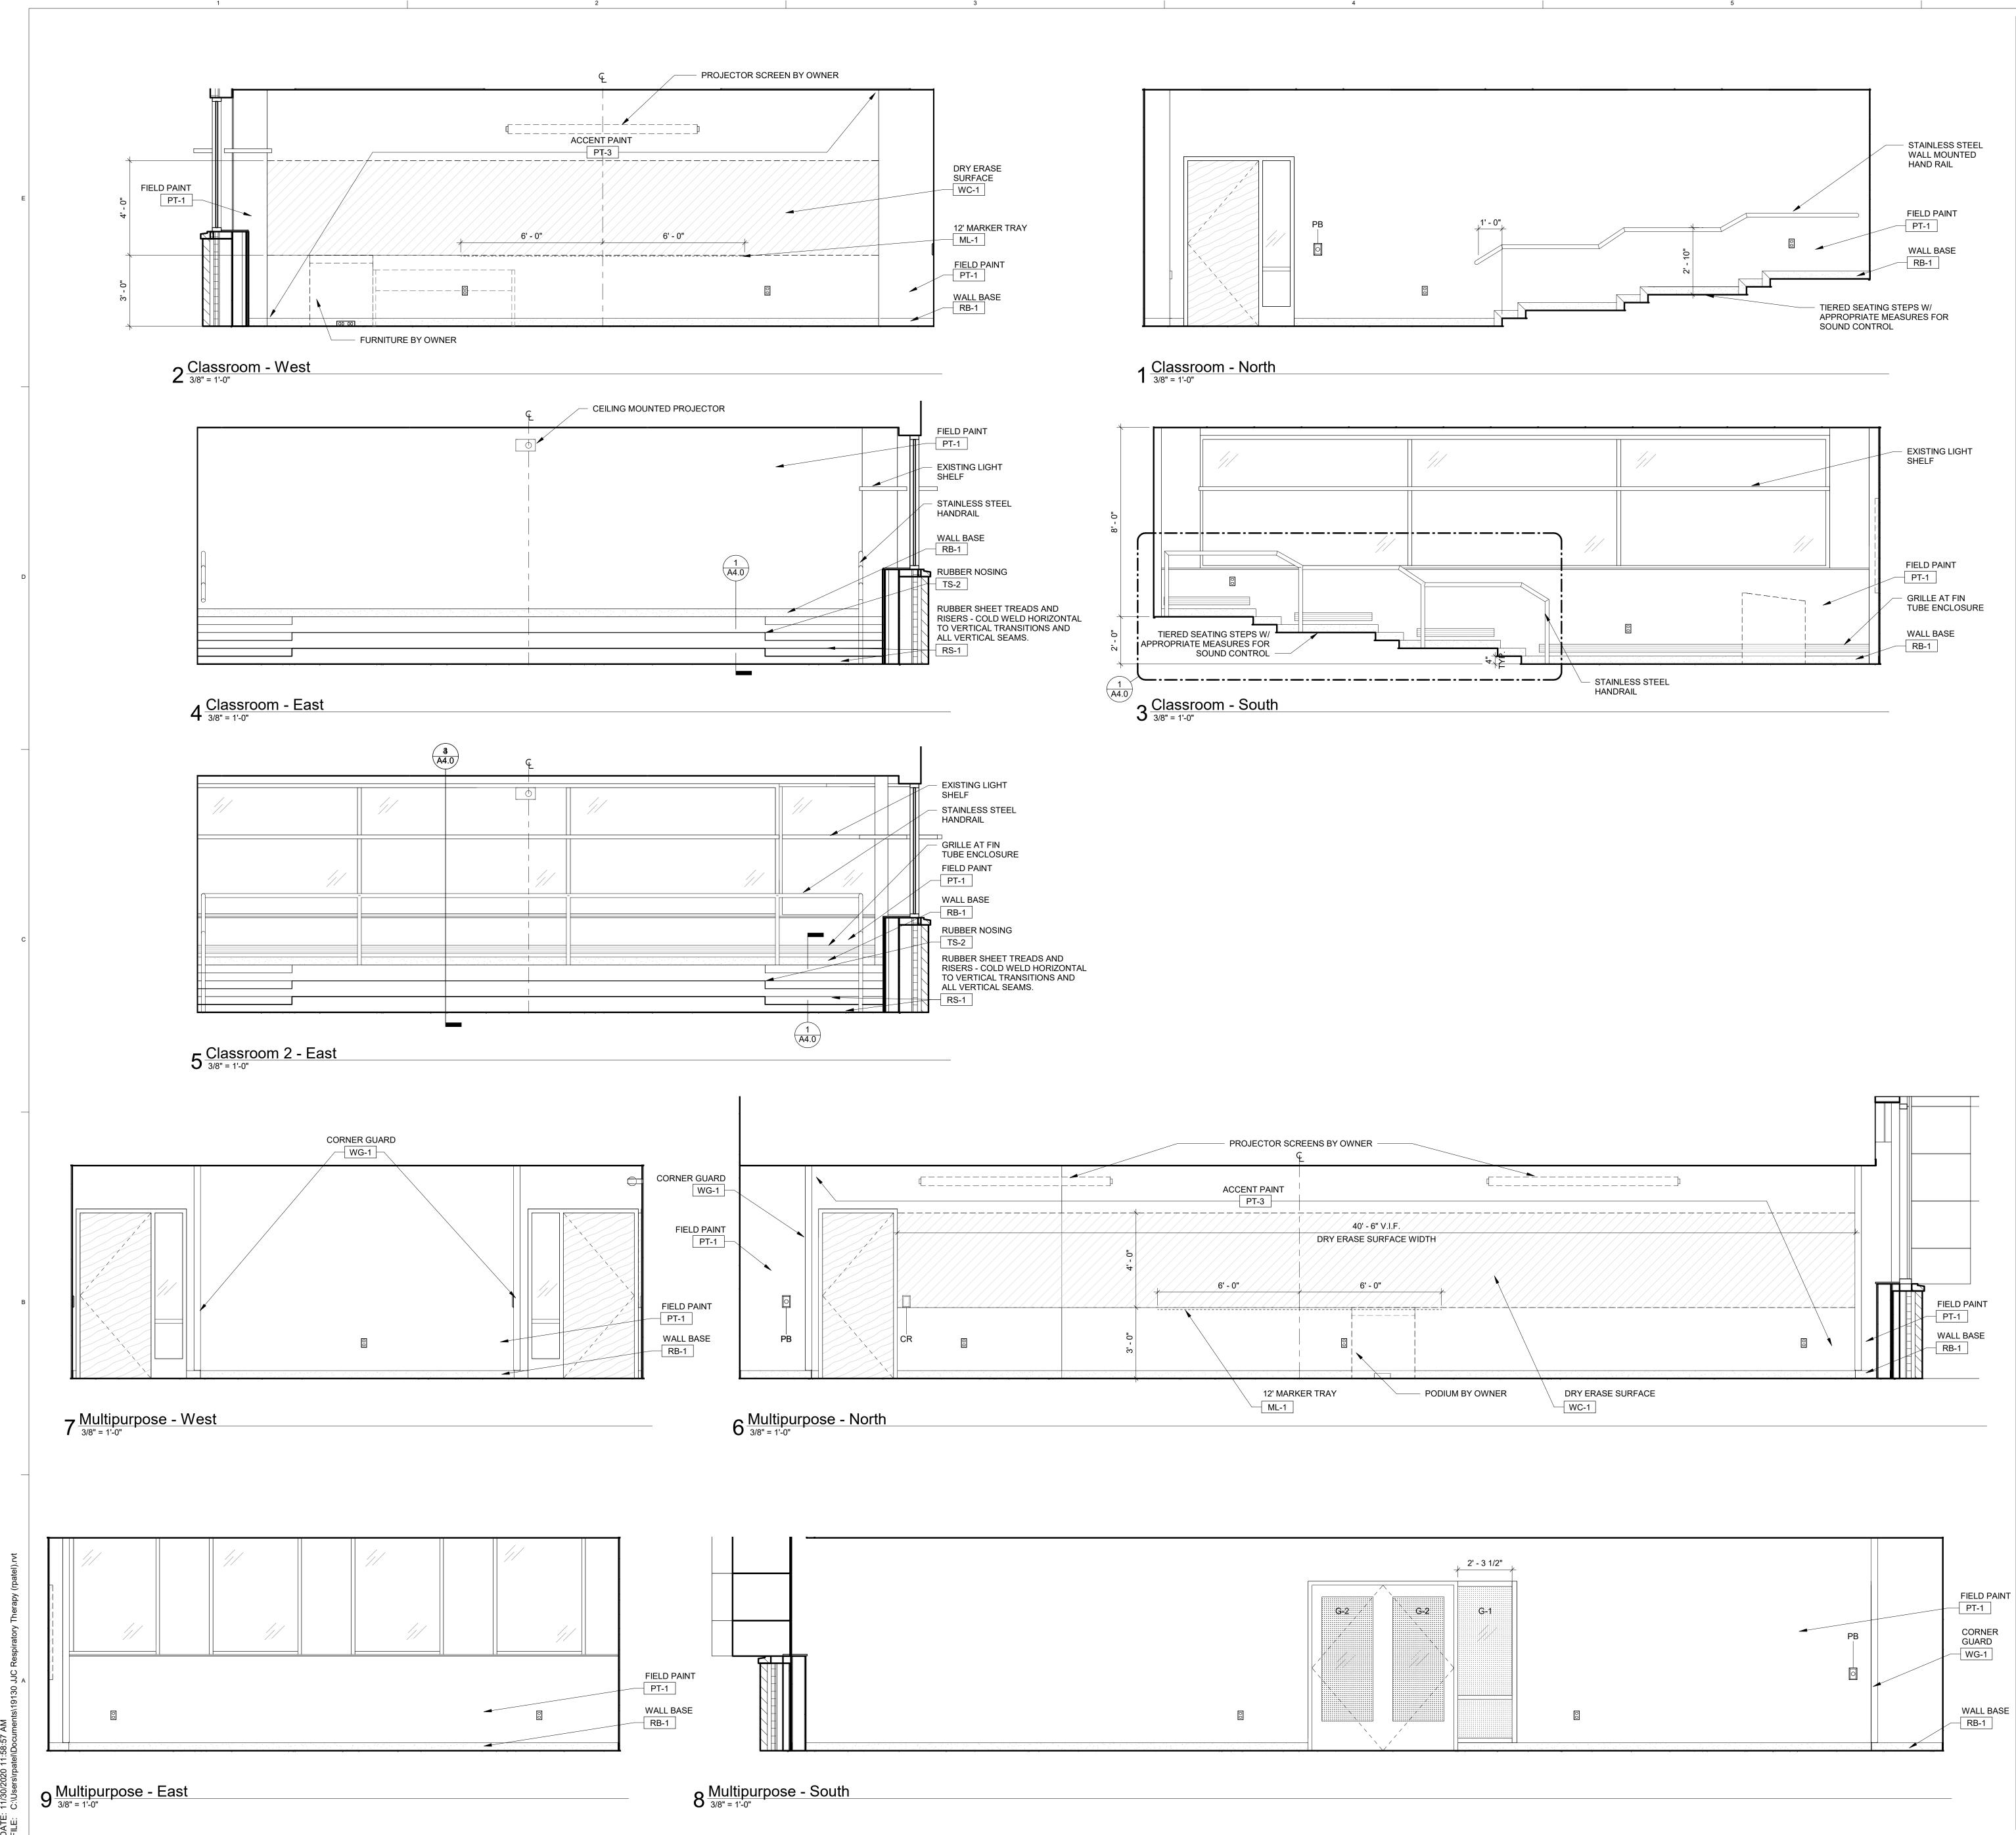
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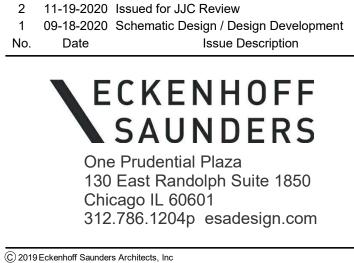
Sheet Title Interior Elevations

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Respiratory Therapy

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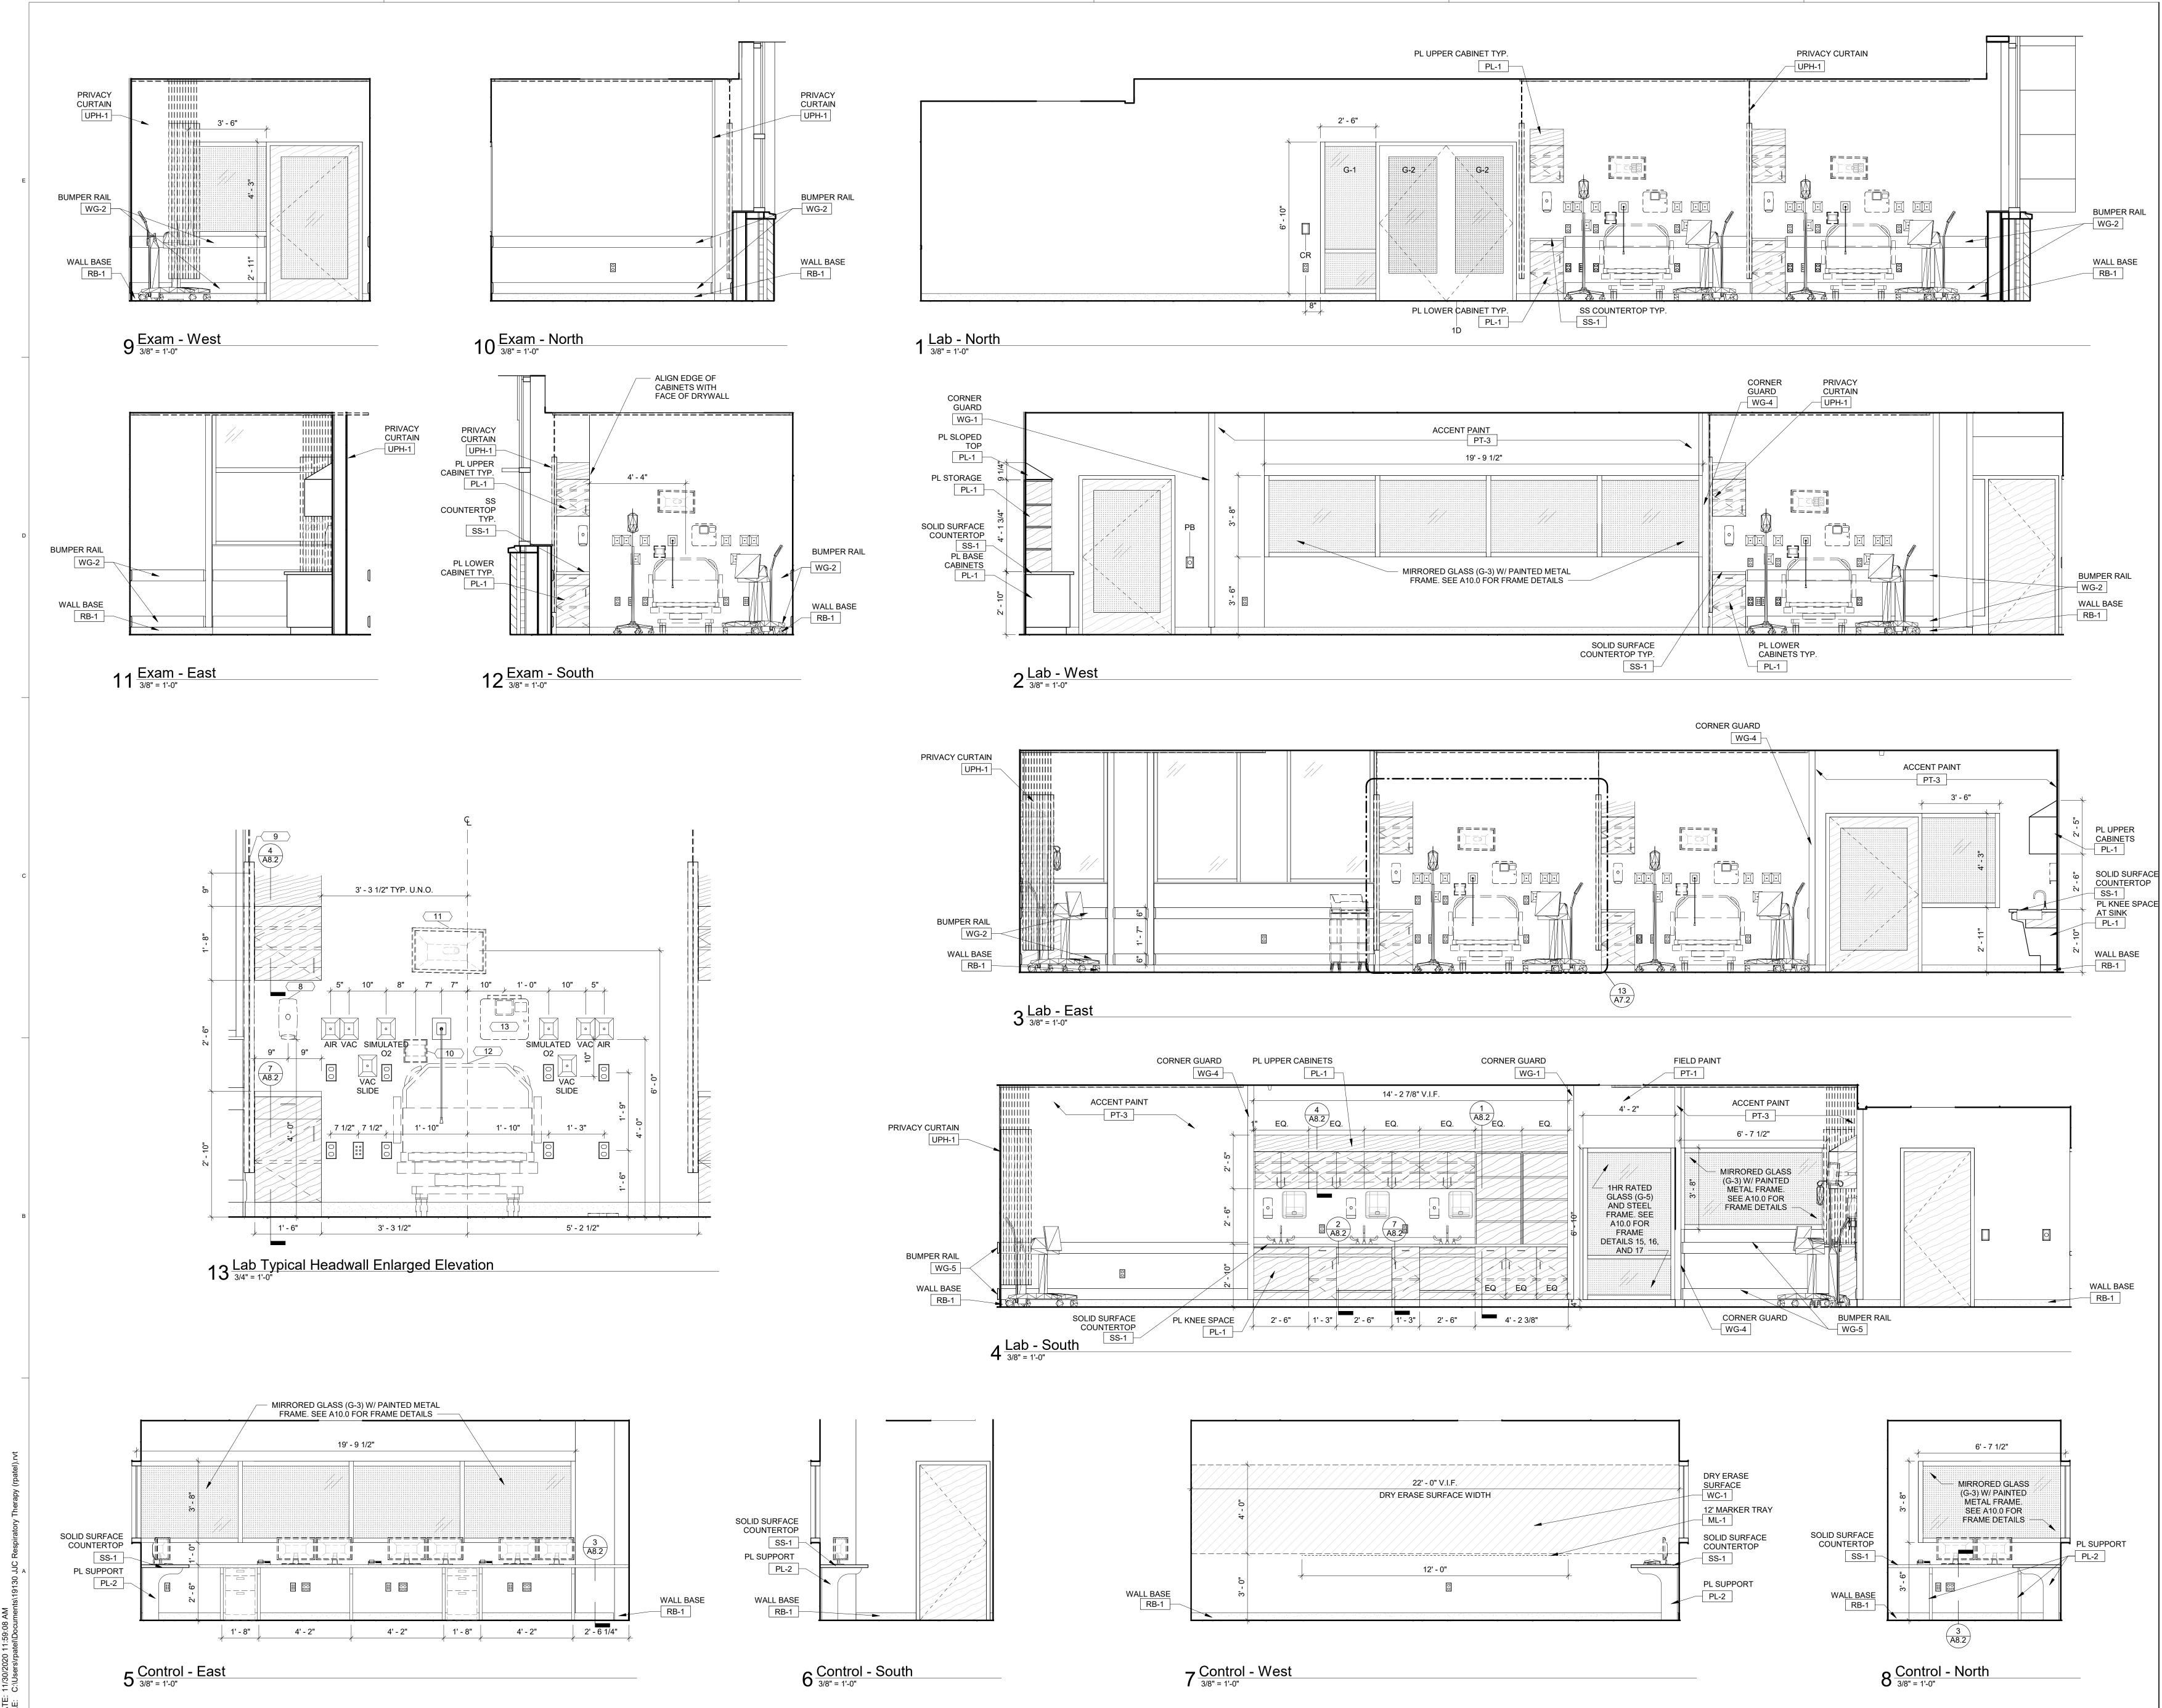
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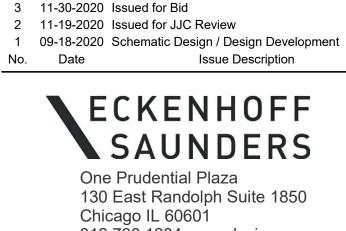
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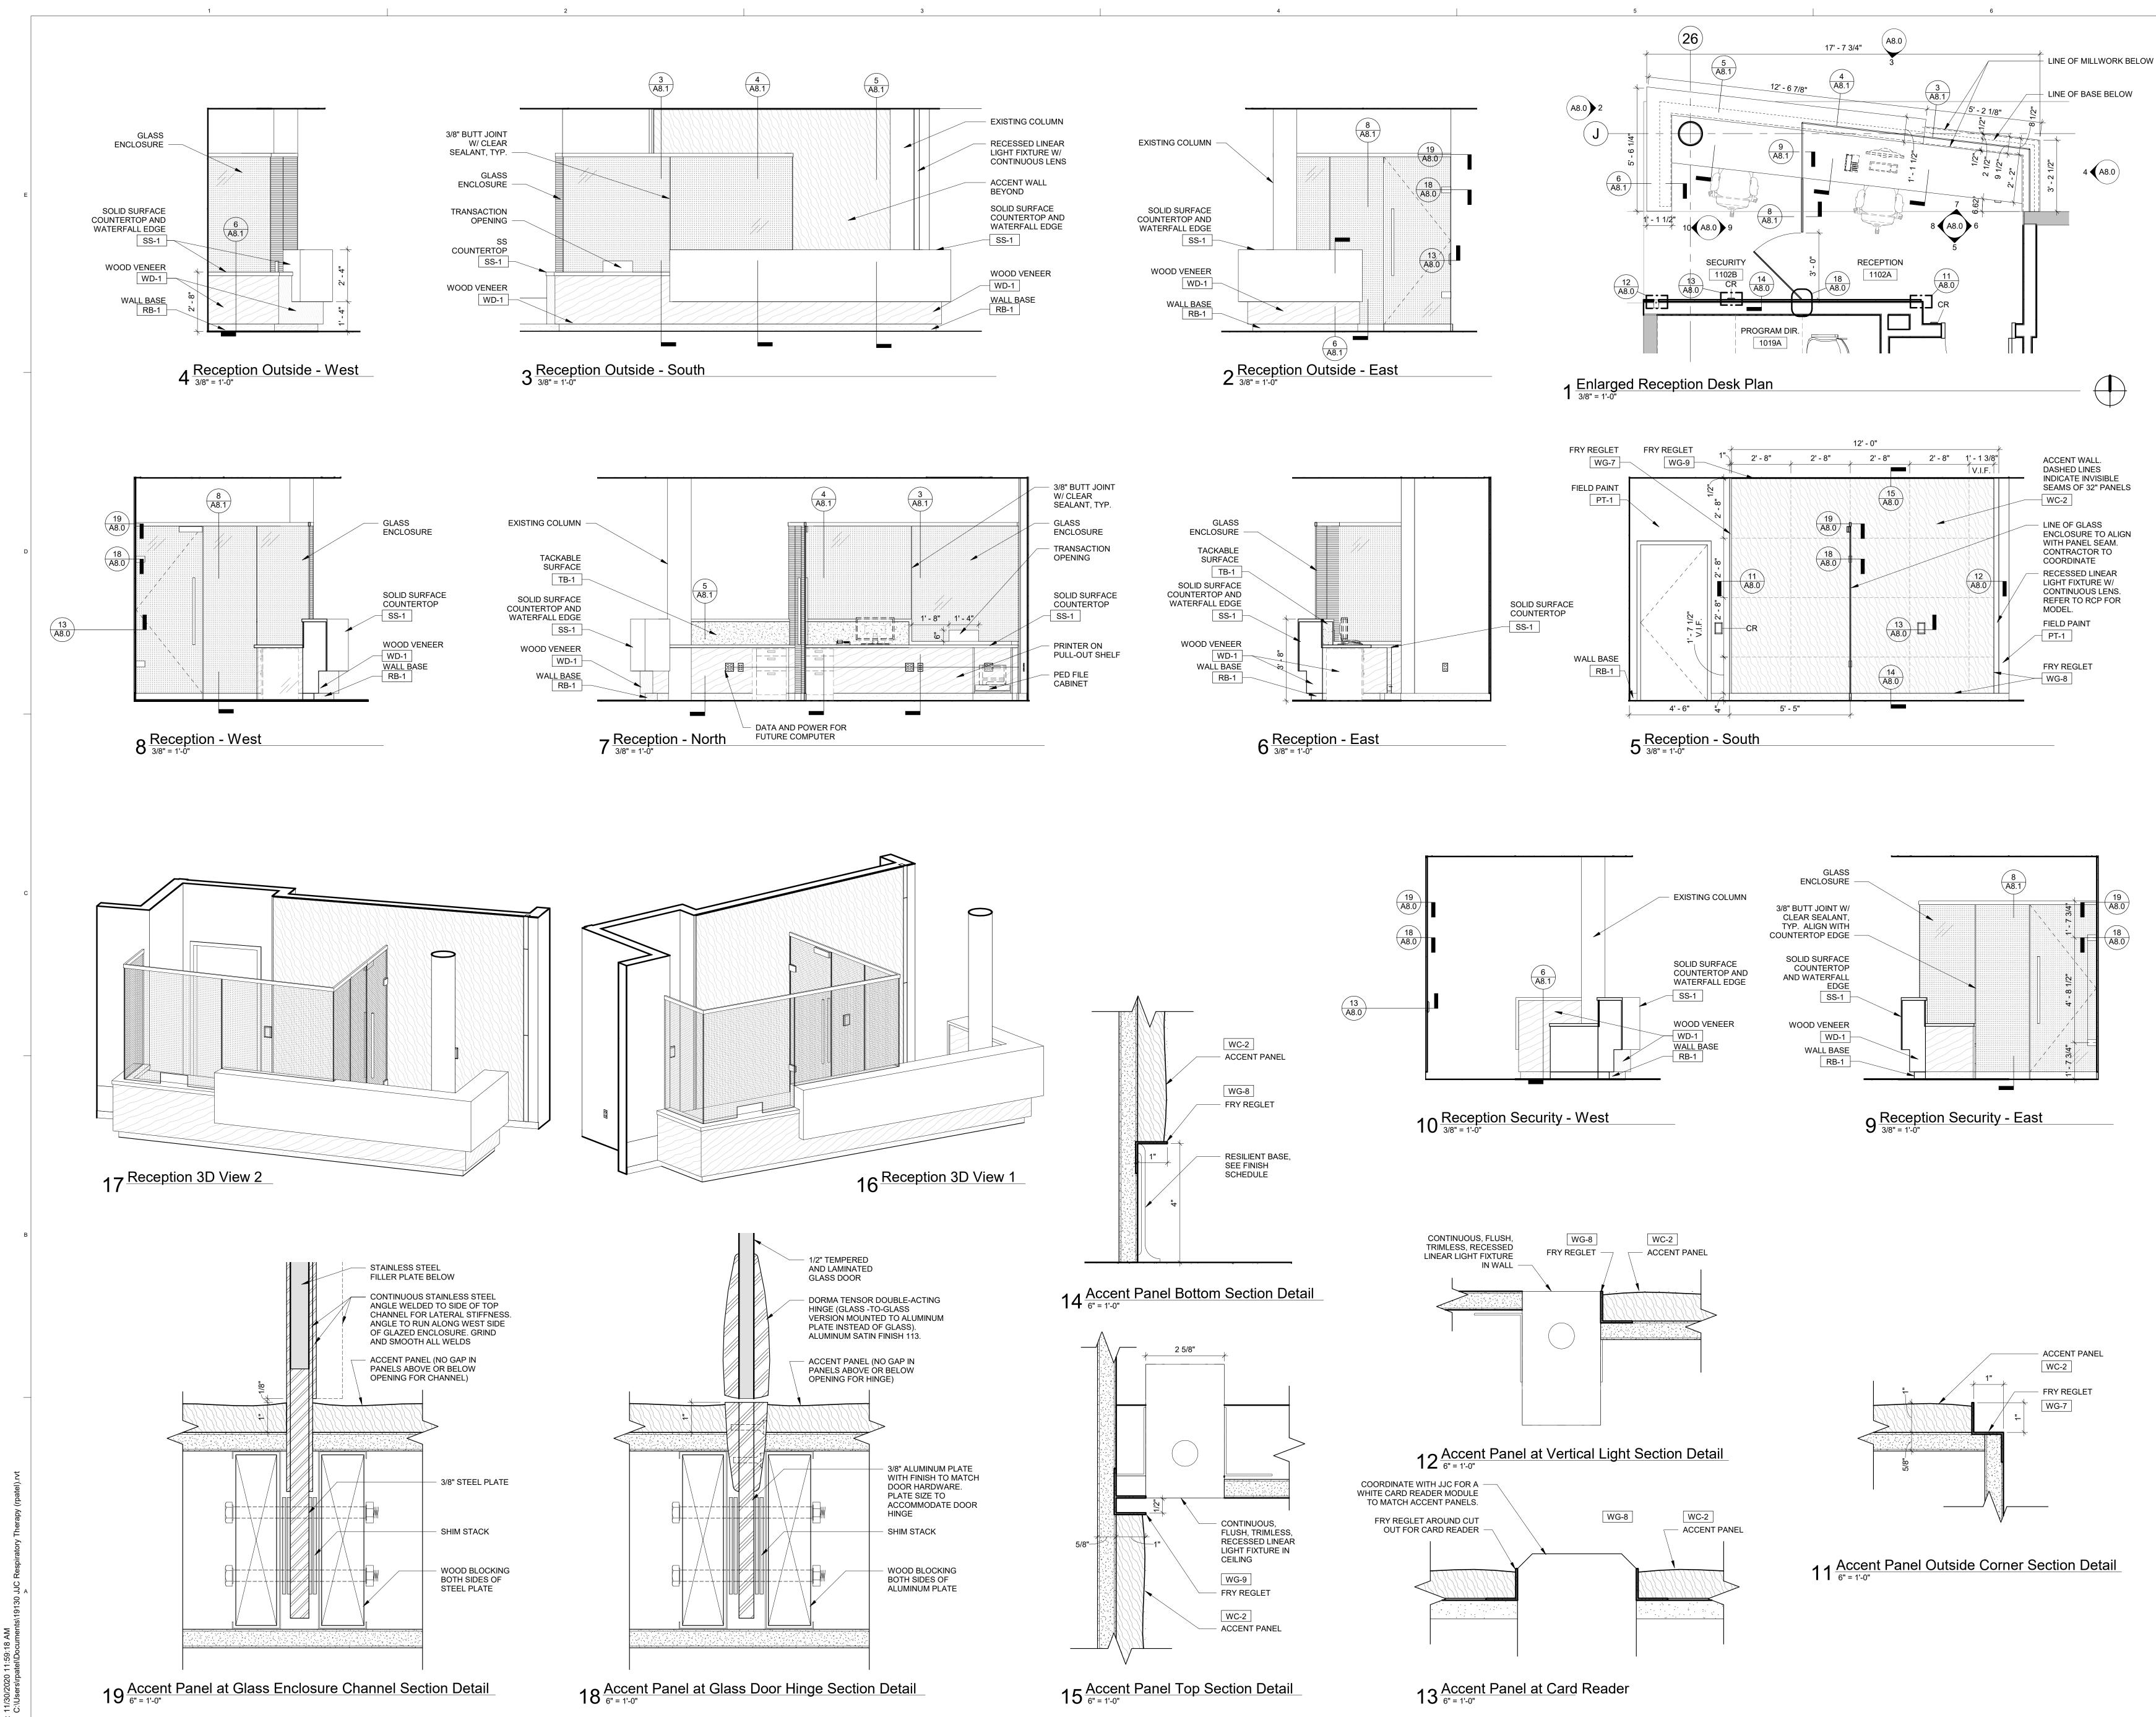


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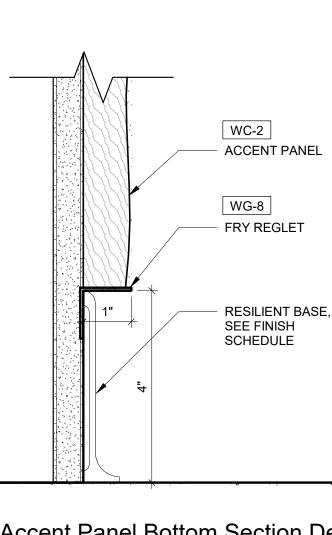
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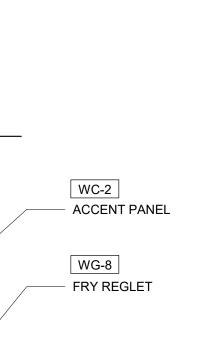
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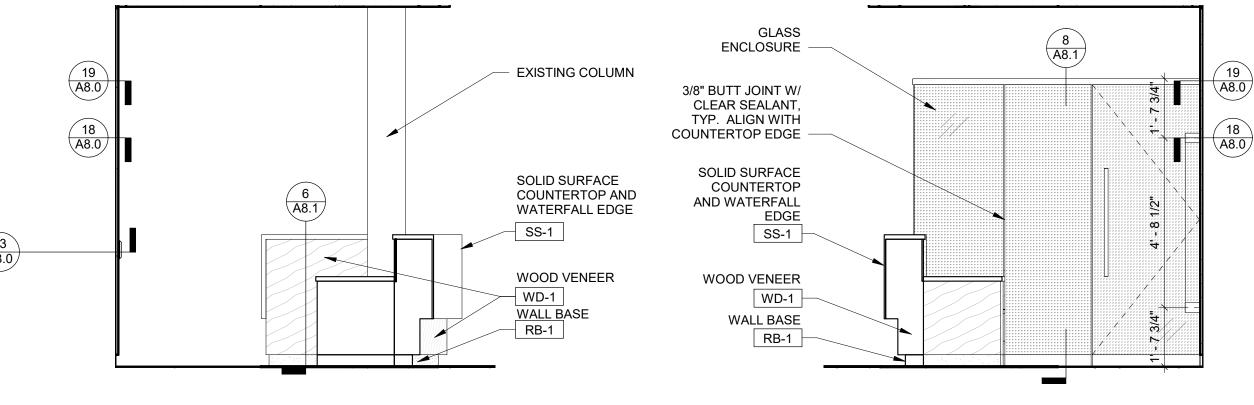












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Sheet Title

Interior Details, Elevations, and Enlarged Plan -Reception

A8.0

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Respiratory Therapy

Joliet Junior College


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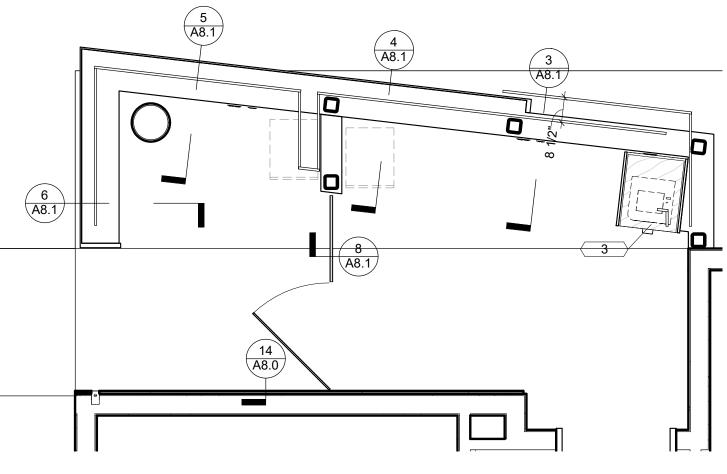


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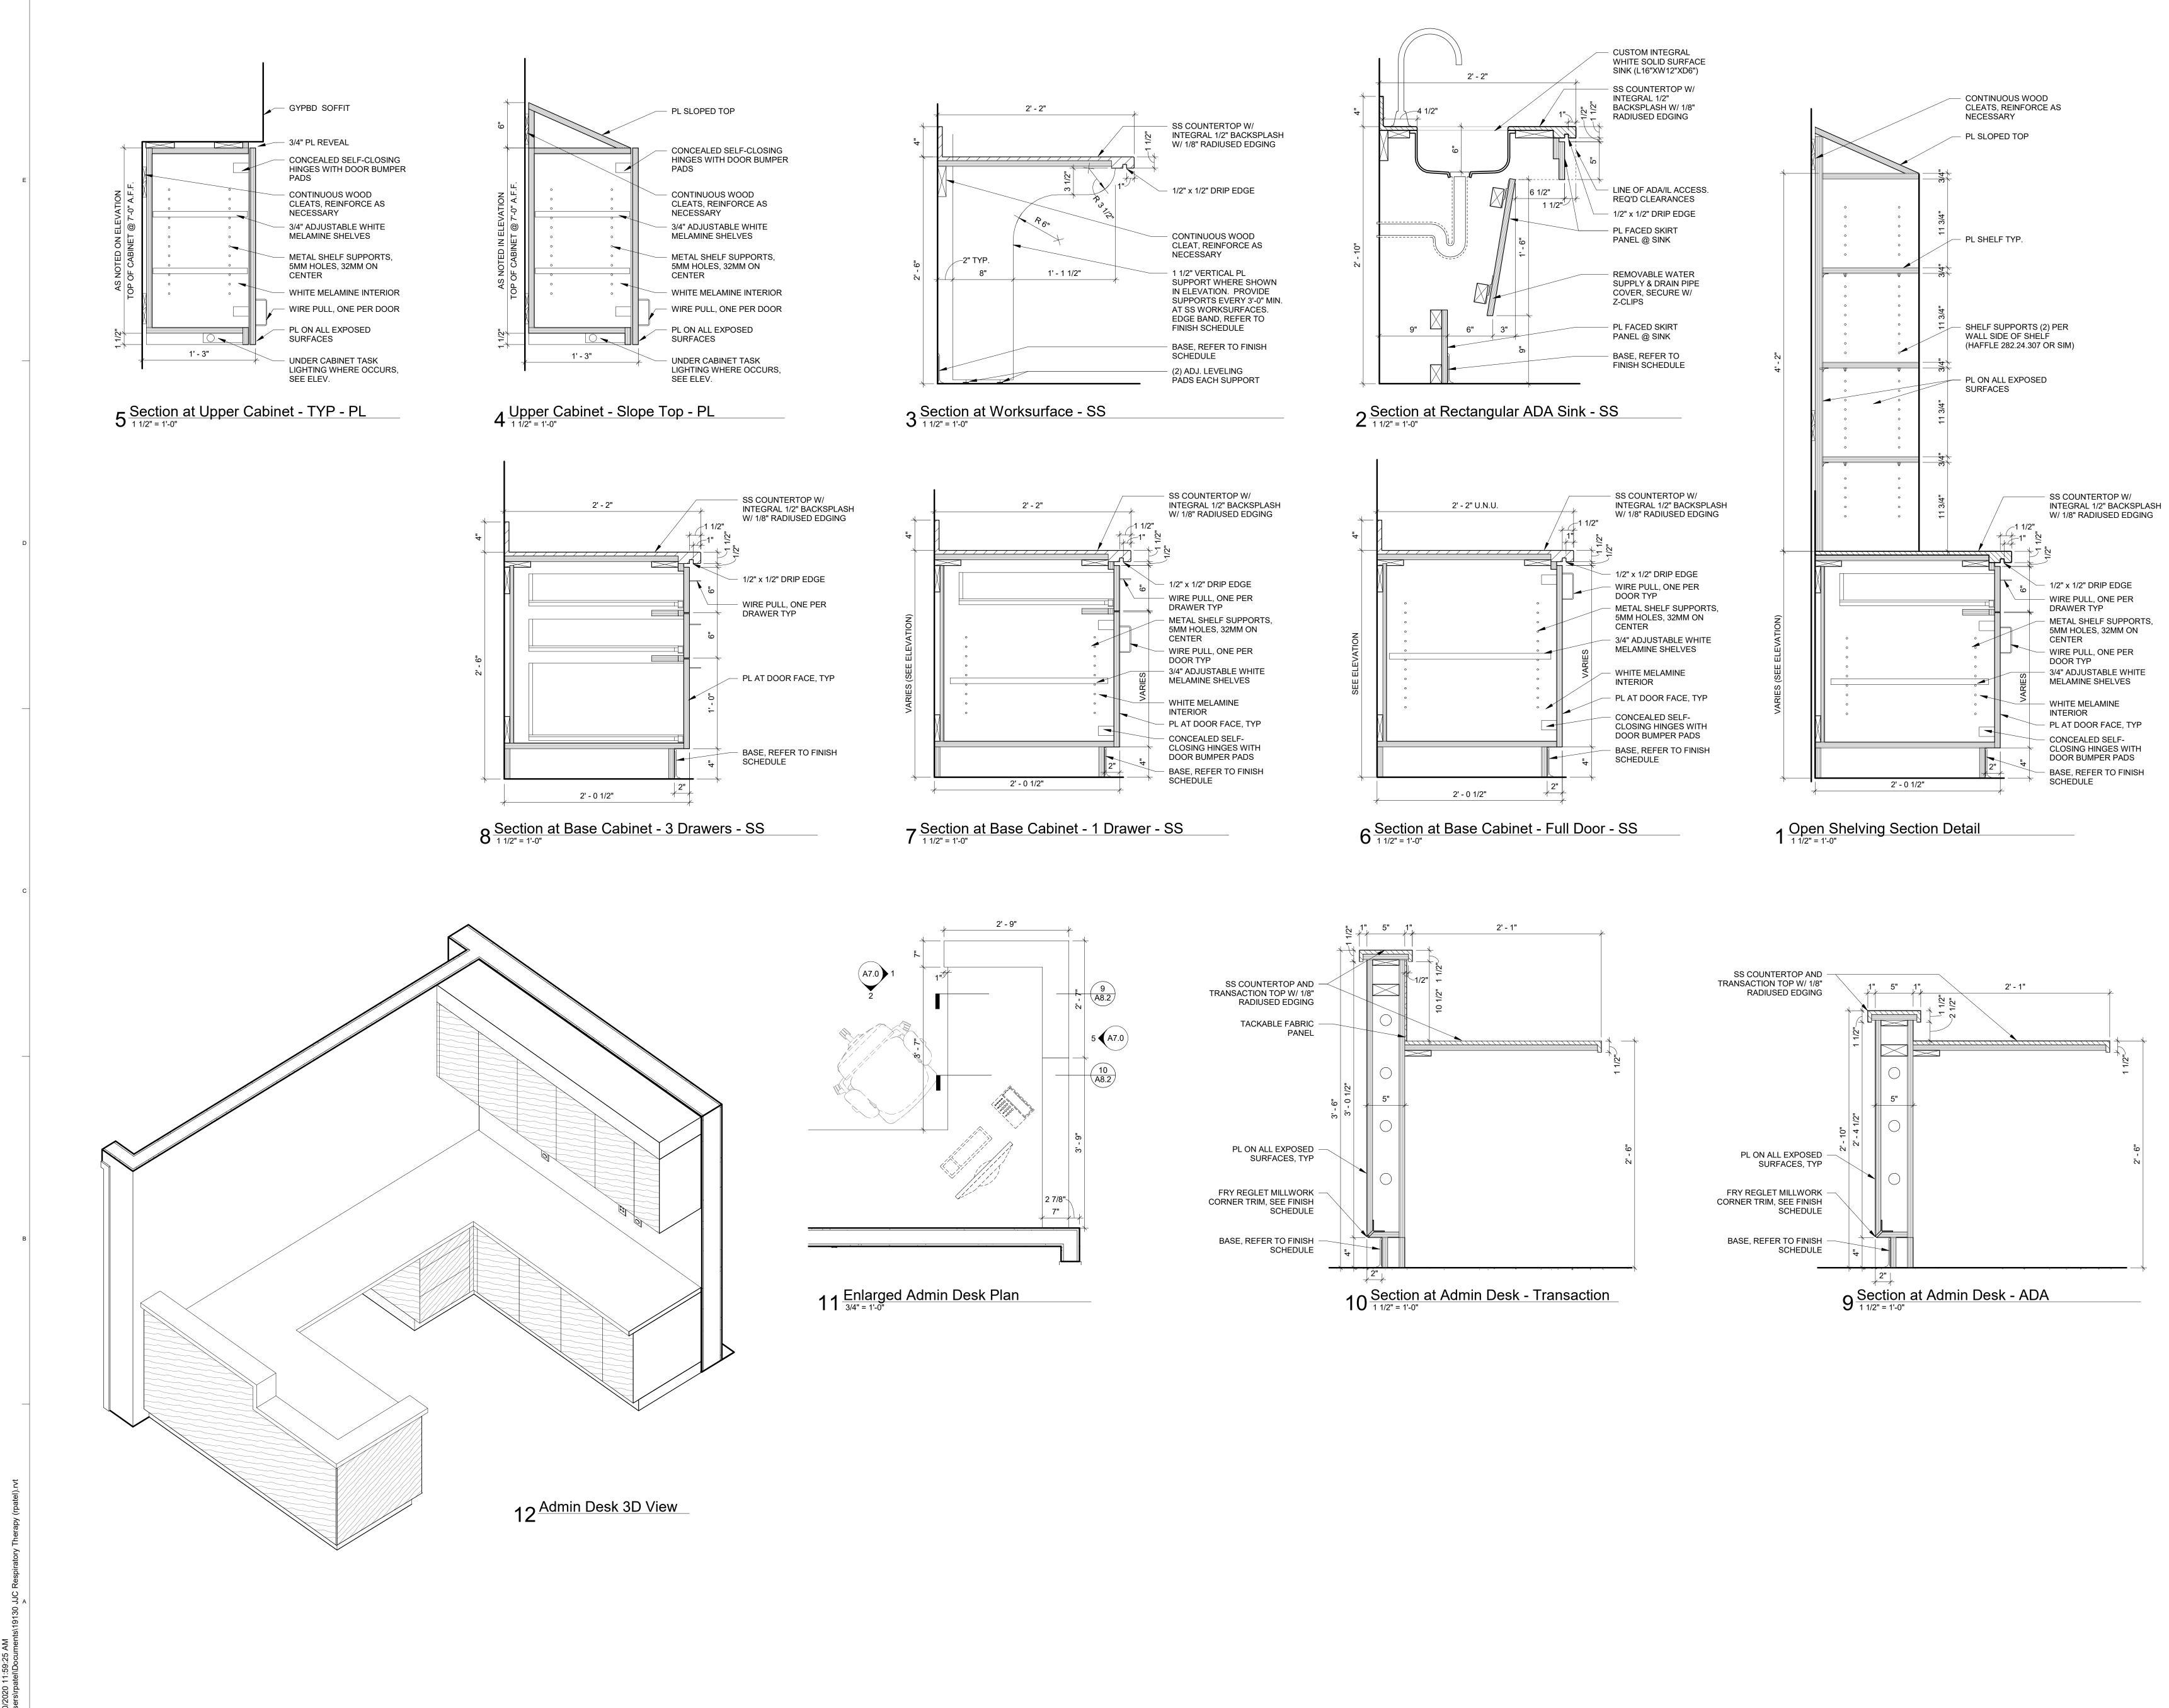




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Reception	AII -
QAQC Checker Project No. 19130	48.1

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Sheet Title Interior Details

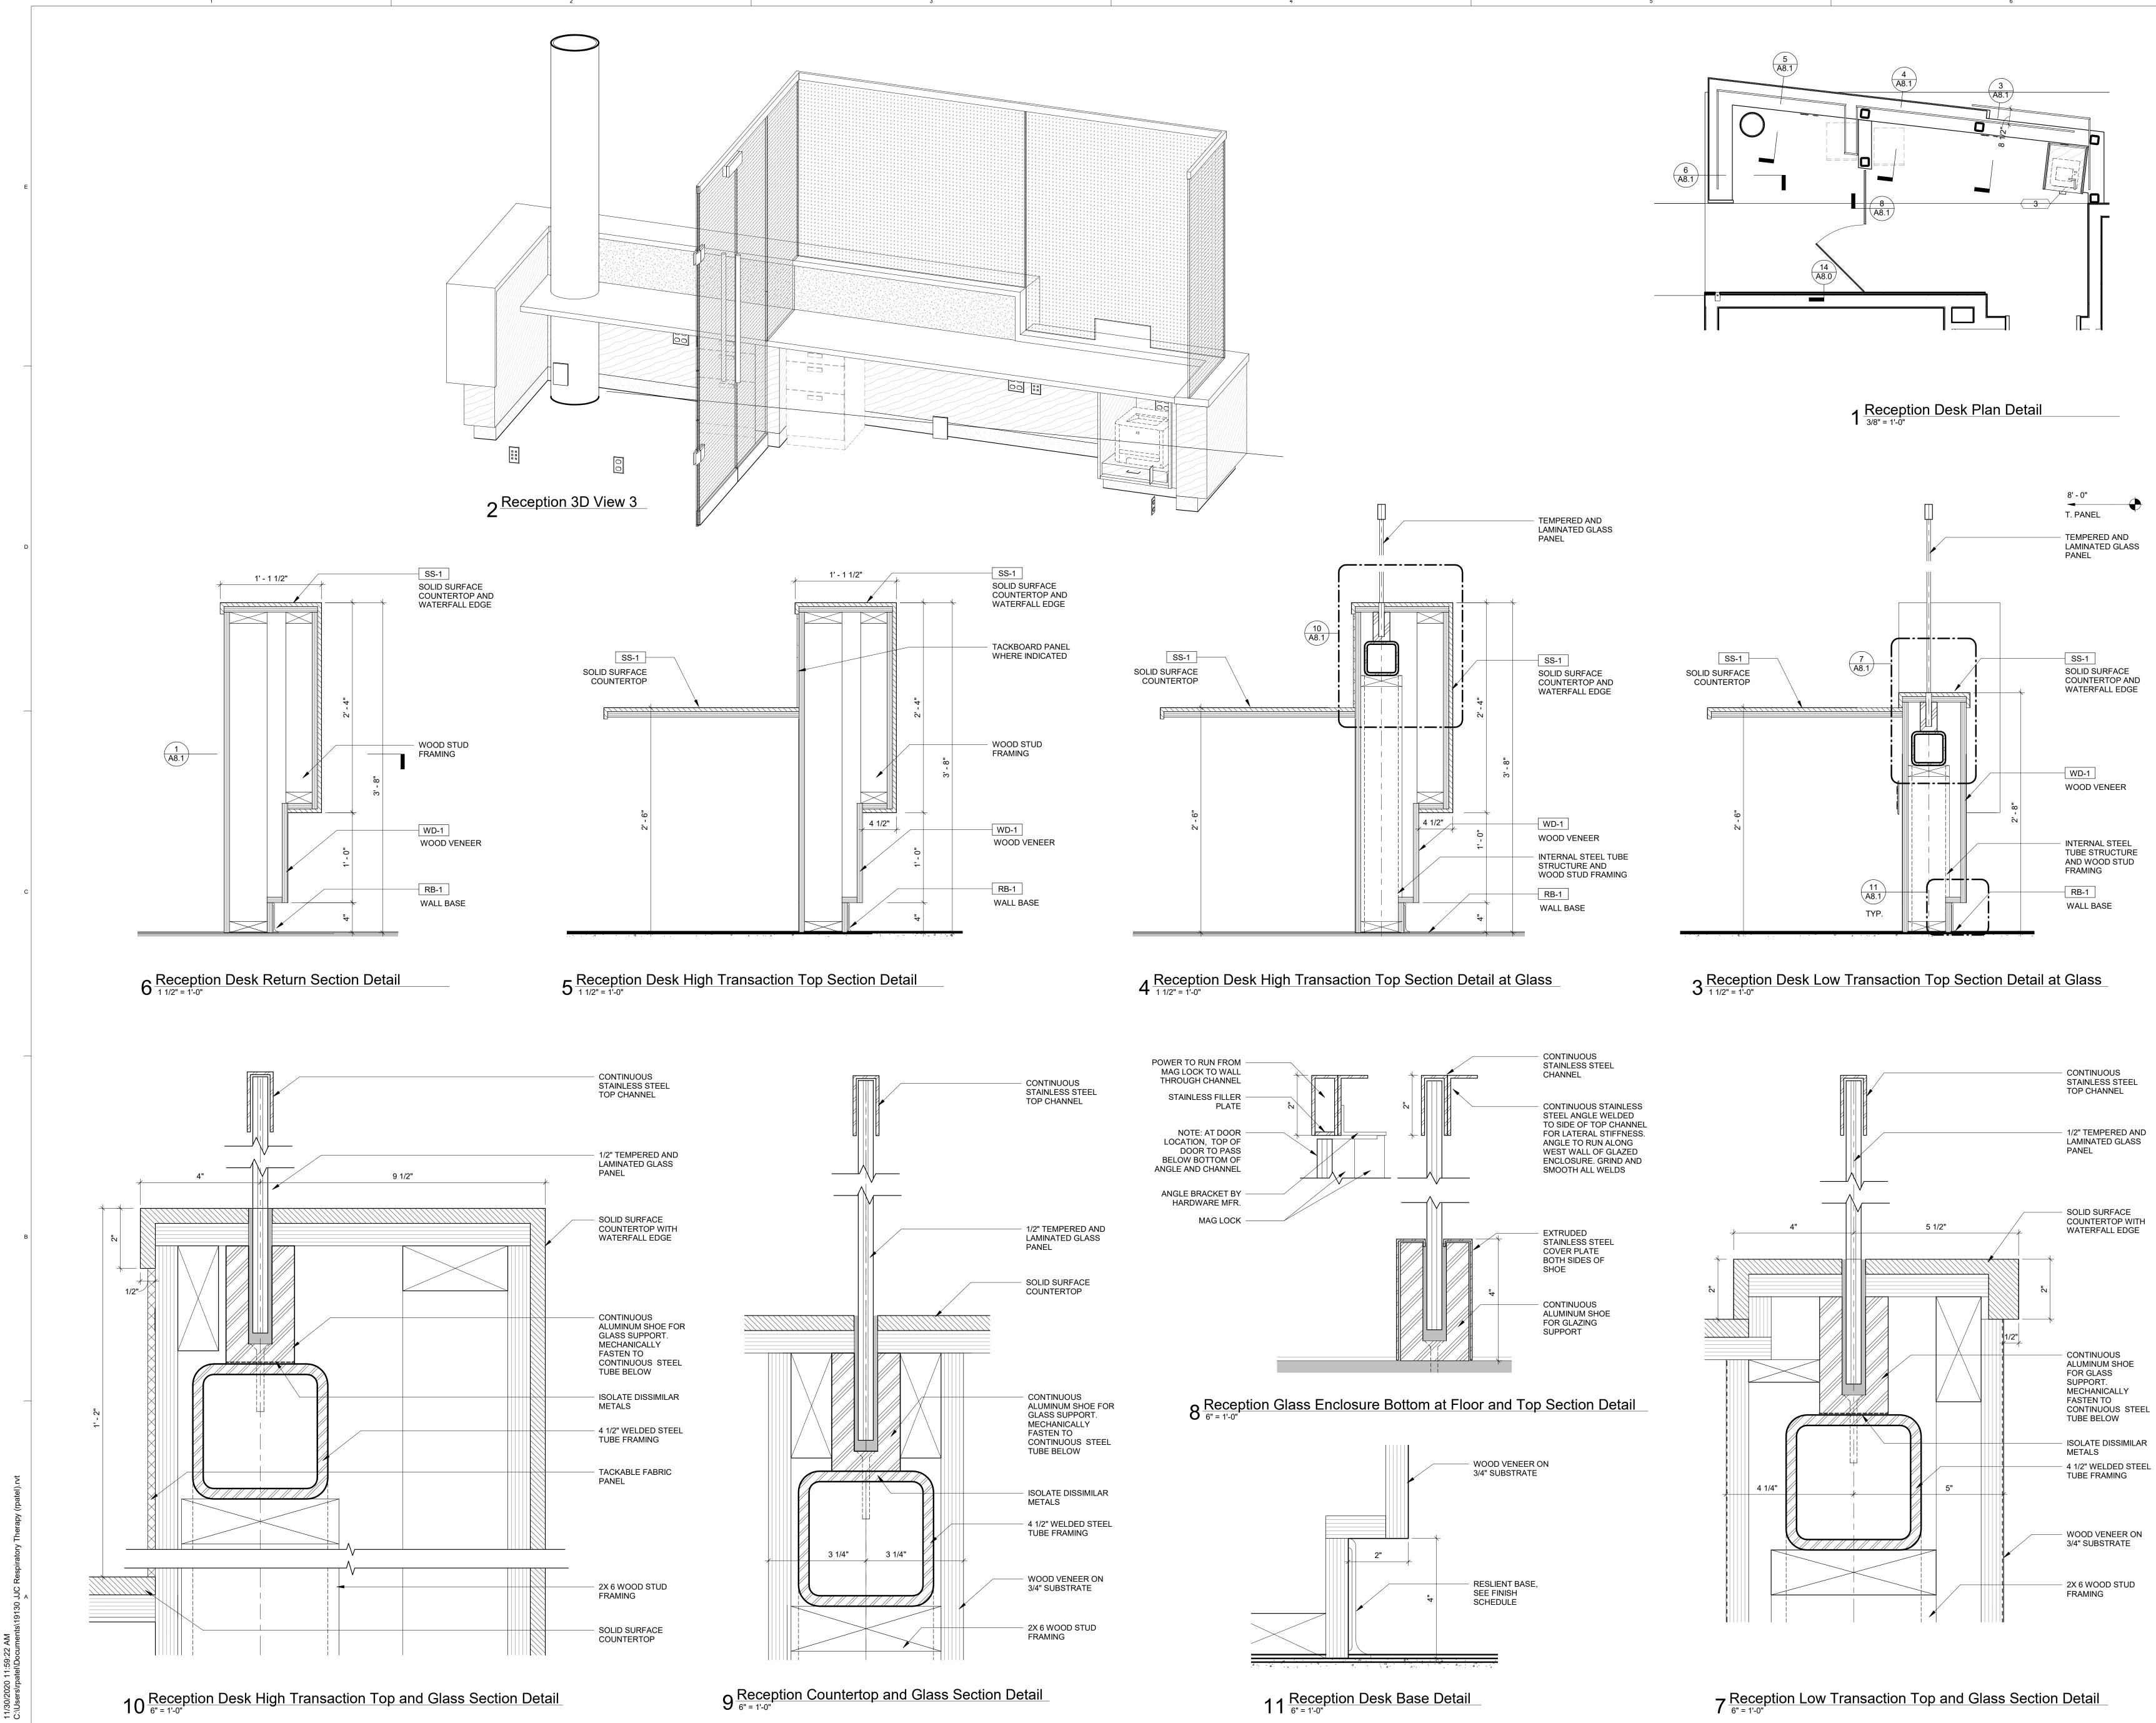
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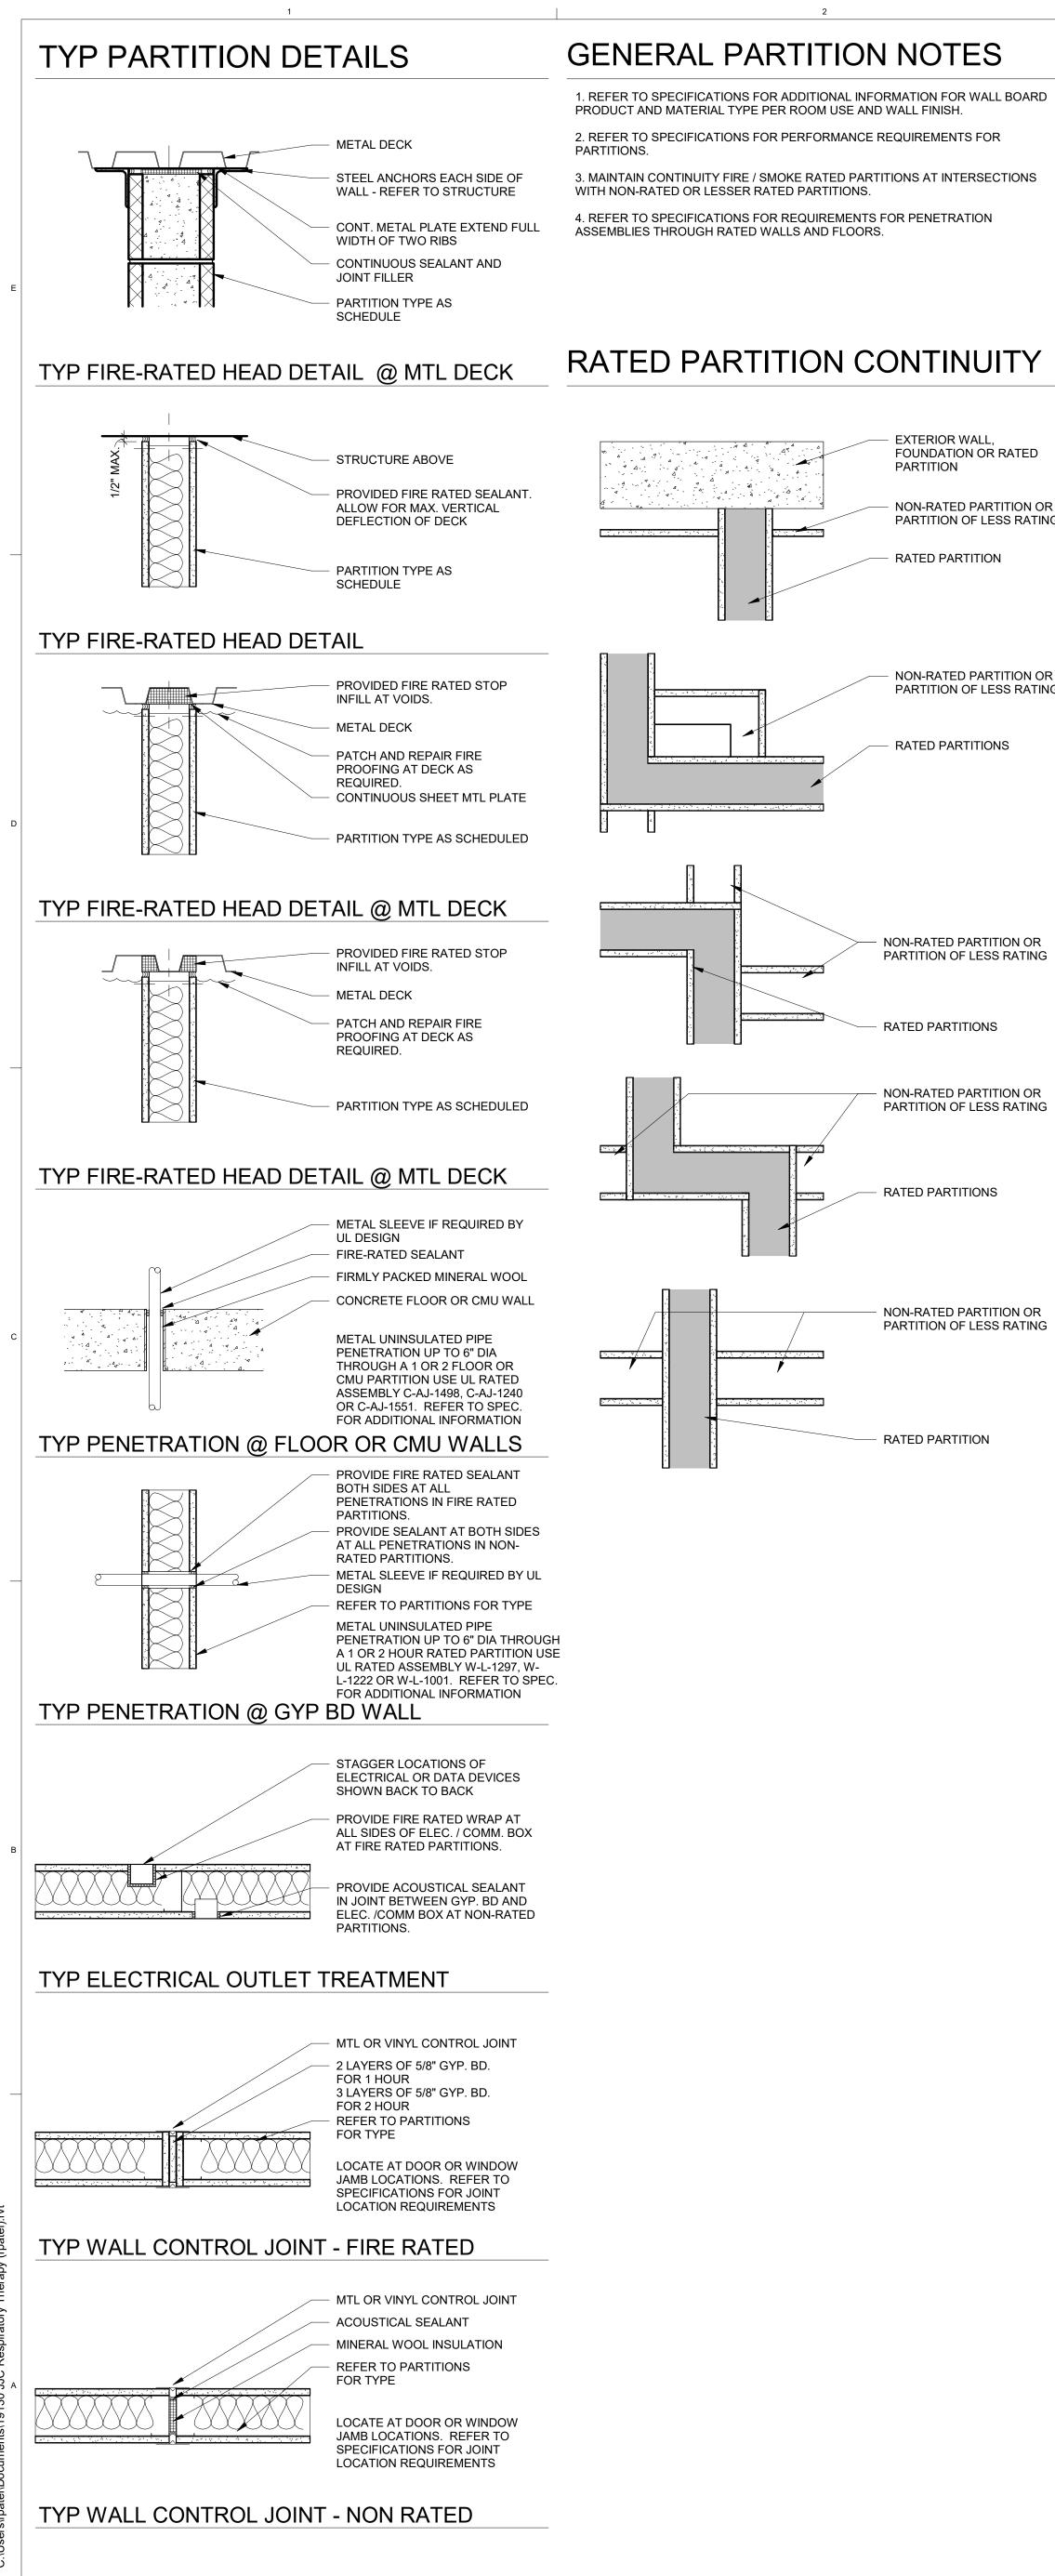


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			3								4			
	HE	AD	12" MIN.	TRACK. CONFIRM DEFI ARCHITECT AND STRU ENGINEER	ECTION TRACK STUDS DOWN 1/2" FROM RM DEFLECTION WITH			AD			 UNDERSIDE OF STRUCTURE METAL "J" RUNNER TOP AND BOTTOM FINISH CEILING 			
,	PL4			FINISH CEILING 2" ACOUSTICAL INSULA 5/8" GYP. BD. METAL STUDS @ 16" O **PROVIDE METAL STR WHEN ADJACENT TO S STOP STUDS 6" ABOVE	.C. AP ANCH	BSTRATE AND	PL/ SH/ SII	4FT			- 3" MINERAL \ - 1" GYP. BD. S - "C-H" METAL - 5/8" GYP. BD 3/4" GYP. BD	SHAFTWAL STUDS, 24 1 HOUR	L 4" O.C.	
DR ING	BAS	SE 1/2"		WALL SUBSTRATE WH ACOUSTICAL SEALANT AND PERIMETER. BASE AND FLOORING - FINISH SCHEDULE **METAL STUD SIZE LE BE USED ONLY WITH S ONLY	TOP ANI	о воттом °О 2 1/2" ТО	BA	SE		_	 SEALANT AR PARTITION V BASE AND FI FINISH SCHE 	VITH UL CL	ASSIFICA	ATION.
	UL DESI	GN -			SCAL	E: 1-1/2"= 1'-0"	UL DESI	IGN U41	5				SCALE	E: 1-1/2"=
	TYPE		DESCRIPTION	STUD SIZE	STC	TOTAL THICKNESS	TYPE		DESC	RIPTION		STUD SIZE	STC	TOT/ THICKN
	6	FURRING PARTI	TION	3 5/8"	-	4-1/4"	4	1 HOU	IR SHAFT WALL			4"	-	4-5/8'
)r Ng	6A	FURRING PARTI	TION W/ NO ACOUS	TICAL 3 5/8"	-	4-1/4"	4A	2 HOU	IR SHAFT WALL			4"	-	4-3/4'
	6B	FURRING PARTI	TION W/ NO ACOUS	TICAL 2 1/2"	-	3-1/8"	~							
	6C	FURRING PARTI	TION W/ NO ACOUS	TICAL 1 5/8"	-	2-1/4"								
	6D	FURRING PARTI SUBSTRATE	TION APPLY GYP BD	ото -	-	5/8"								
	$\dot{\wedge}$	FURRING PARTI												

TOTAL TRACKIESS TYPE DESCRIPTION STUD SUE STU SUE STU TOTAL SUE STU SUE STU TOTAL SUE STUD SUE STUD SU		<u> </u>	5						6			
TOTAL TYPE DESCRIPTION STO TOTAL 4.60* 2 1 HOUR FREE RATED PARTITION 31/0* 40 4.79* 1 NON-COMPUTINE FRATTION 31/0* 40 4.39* 2 1 HOUR FREE RATED PARTITION 0* - 7.14* NON-COMPUTINE FRATTION 35/9* 40 4.39* 2 1 HOUR FREE RATED PARTITION 0* - 7.14* NON-COMPUTINE FRATTION 35/9* 40 2 2 1 HOUR FREE RATED PARTITION WIND 3/8* 40 4.79* NON-COMPUTINE FRATTION WIND 3/8* 40 2 1 1 1 1 NON-COMPUTINE FRATTION WIND USING 20 8* 3/9* - 1 1 1 1 1 NON-COMPUTINE FRATTION WIND USING 20 8* 3/9* - 1 1 1 1 1 1 1 NON-COMPUTINE FRATTION WIND USING 20 8* 3/9* - 1 1 1 1 1 1 1	METER OF TION.	 PL	AD HOLD TOP OI TRACK. CONI ARCHITECT A ENGINEER FINISH CEILIN 2" MINERAL V 5/8" GYP. BD. METAL STUD SE SE BASE AND FL	FLECTION F STUDS D FIRM DEFL AND STRUC NG VOOL INSU EACH SIDE S @ 16" O.0 TH SIDES, PERIMETEI ION.	TRACK OWN 1/2" ECTION W CTURAL JLATION E C. TOP AND R WITH U	VITH BOTTOM L	PLAN		 SLOTTED DEF HOLD TOP OF TRACK. CONF ARCHITECT A ENGINEER FINISH CEILIN 2" ACOUSTICA 5/8" GYP. BD. METAL STUDS METAL STUDS ACOUSTICAL AND BOTTOM BASE AND FLO 	ELECTION STUDS D IRM DEFL ND STRUC G AL INSULA EACH SID S @ 16" O. SEALANT AND PER DORING -	TRACK OWN 1/2" ECTION W CTURAL TION E C. BOTH SID IMETER	/ITH ES, TOP
THICKNESS THE DESCRIPTION SIZE SNL THEOREES 4.53* 2 1 HOUR FREE RATED PARTITION 3 68* 49 4.78* Non-COMUSTILE PARTITION 3 58* 40 4.34* 20 1 HOUR FREE RATED PARTITION 0* - 7.54* Non-COMUSTILE PARTITION 3 58* 40 4.34* 20 1 HOUR FREE RATED PARTITION 0* - 7.54* Non-COMUSTILE PARTITION 3 58* - 4.34* 20 1 HOUR FREE RATED PARTITION WIND 3 58* 45 4.76* Non-COMUSTILE PARTITION 3 58* - 4.34* 1 HOUR FREE RATED PARTITION WIND 3 58* 45 4.76* Non-COMUSTILE PARTITION 3 58* - 4.35* 1 HOUR FREE RATED PARTITION WIND 3 58* - Non-COMUSTILE PARTITION 3 58* - 4.36* 1 HOUR FREE RATED PARTITION WIND 3 58* - - - Non-COMUSTILE PARTITION 3 58* - 100 0 - 0 - - -	:: 1-1/2"= 1'-0"	UL DESI	GN U419		SCALE:	: 1-1/2"= 1'-0"	UL DESIGN	i I -			SCALE:	1-1/2"= 1'-0"
4-bs* 2 1 HOUR FRE RATED PARTITION 3.58* 49 4.75* 4-39* 2.0 1 HOUR FRE RATED PARTITION 6* - 7.14** 1 4-39* 2.0 1 HOUR FRE RATED PARTITION 6* - 7.14** 1 4-39* 2.0 1 HOUR FRE RATED PARTITION 6* - 7.14** 1 1 1 HOUR FRE RATED PARTITION 6* - 7.14** 1 1 1 HOUR FRE RATED PARTITION WIND 3.6** 40 4.75** 1 1 <t< td=""><td></td><td>TYPE</td><td>DESCRIPTION</td><td></td><td>STC</td><td></td><td>TYPE</td><td>DESCRIPTION</td><td></td><td></td><td></td><td>TOTAL</td></t<>		TYPE	DESCRIPTION		STC		TYPE	DESCRIPTION				TOTAL
4-34" 71 HOUR FIRE BATED PARTITION 6" 7.14" 11 270 IHOUR FIRE INFECT PARTITION 6" 7.14" 11 NON-COMBUSTIBLE PARTITION 3.56" 40 270 IHOUR FIRE INFECT PARTITION 5.58" 40 4.78" NON-COMBUSTIBLE PARTITION 5.56" 40 270 IHOUR FIRE INFECT PARTITION 5.58" 40 4.78" NON-COMBUSTIBLE PARTITION 5.56" 40 270 INMERIAL WOOL INSULATION 3.56" 40 4.78" NON-COMBUSTIBLE PARTITION 5.56" 53 271 INMERIAL WOOL INSULATION 4.78" 10 50 54 53 272 INMERIAL WOOL INSULATION 5.58" 40 4.78" 100 56" GWIR ONE SINCe Partition WIR 20 53 273 INMERIAL WOOL INSULATION 5.58" 54 54 54 55 274 INMERIAL WOOL INSULATION 56" GWIR ONE SINCE 56" GWIR ONE SINCE 56" GWIR ONE SINCE INSULATION 56" GWIR ONE SINCE INSULATION INSULATION INSULATION INSULATION INSULATION INSULATION INSULATION INSULATION INSULATION I												THICKNESS 4-7/8"
4-34 20 - <td></td> <td></td> <td>1 HOUR FIRE RATED PARTITION</td> <td></td> <td></td> <td></td> <td></td> <td>ION-COMBUSTIBLE PARTITION W</td> <td>// NO</td> <td></td> <td></td> <td></td>			1 HOUR FIRE RATED PARTITION					ION-COMBUSTIBLE PARTITION W	// NO			
Immethal WOOL INSULATION 3.58° 40° 4.78° 11° Immethal WOOL INSULATION 5 5 5 5 Immethal WOOL INSULATION Immethal WOOL INSULATION Immethal WOOL INSULATION 5 5 5 5 Immethal WOOL INSULATION Immethal Wool INSULATION Immethal Wool INSULATION Immethal Wool INSULATION 5 6 Immethal Wool INSULATION Immethal Wool INSULATION Immethal Wool INSULATION Immethal Wool INSULATION 6 Immethal Wool INSULATION Immethal Wool INSULATION Immethal Wool INSULATION Immethal Wool INSULATION 6 Immethal Wool INSULATION Immethal Wool INSULATION Immethal Wool INSULATION Immethal Wool INSULATION 6 Immethal Wool INSULATION Immethal Wool INSULATION Immethal Wool INSULATION Immethal Wool Insulation Receiver Advection Immethal Wool INSULATION Immethal Study of Program Wool Insulation Receiver Advection Immethal Study of Program Wool Insulation Receiver Advection Immethal Wool Insulation Immethal Study of Program Wool Insulation Receiver Advection Immethal Study of Program Wool Insulation Immethal Study of Program Wool Insulation Immethal Study of Program Wool Insulation Immethal Study of Program Advection Immethal Study of Program Wool Insulation Immethal Study of Program Advectin Insulation Immethal Study of	4-3/4		1 HOUR FIRE RATED PARTITION W/ NO		-						40	4-7/8"
Image: State in the image: St				3 5/8"	40	4-7/8"				6"	-	7-1/4"
Constraints and a second								OF 5/8" GWB ONE SIDE		3 5/8"	-	5-1/2"
HEAD HEAD SLOTTED DEFLECTION TRACK HOLD TOP OF STUDS DOWN 127 H HOLD TOP OF STUDS DOWN 127 H H HOLD TOP OF STUDS DOWN 127 H								GAUGE STEEL STUDS SPACED 24 RESILIENT CHANNEL RC-1 ONE SI 4" O.C. 5" MINERAL WOOL INSUL	" O.C. W/ DE, SPACED ATION. DESIGN	6"	56	7-3/4"
TYPE DESCRIPTION STUD SIZE STC 8 NON-COMBUSTIBLE PARTITION 3 5/8" - 0.0 NON-COMBUSTIBLE PARTITION - 2 5/0" -							PLAN		 SLOTTED DEF HOLD TOP OF TRACK. CONF ARCHITECT A PROVIDE LATI REQUIRED DRAPE INSUL 2" ACOUSTICA FINISH CEILIN 2" ACOUSTICA 5/8" GYP. BD. METAL STUDS WALL SUBSTF ACOUSTICAL PERIMETER. BASE AND FLO 	ELECTION STUDS D IRM DEFL ND STRUC ERAL BRA ATION OV AL INSULA G AL INSULA EACH SID S @ 16" O. RATE WHE SEALANT	TRACK OWN 1/2" ECTION W CTURAL E CING AS ER GYPSI TION EAC TION EAC TION E C.	/ITH NGINEER JM BOARD H SIDE CABLE ES AND
ITTPE DESCRIPTION SIZE STC 8 NON-COMBUSTIBLE PARTITION 3 5/8" - 01 NON-COMBUSTIBLE PARTITION - 2 5/8" -							UL DESIGN	I -		07115	SCALE:	1-1/2"= 1'-0"
8 3 5/8" NON-COMBUSTIBLE PARTITION - 2 5/8"											STC	TOTAL THICKNESS
										3 5/8"	-	4-7/8"
										3 5/8"	-	4-7/8"

Project No. 19130

QAQC

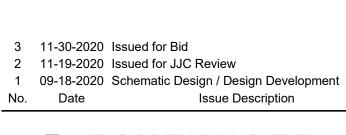Sheet Title

Partition Types

1215 Houbolt Rd, Joliet, IL 60431


Respiratory Therapy

A9.0

Joliet Junior College

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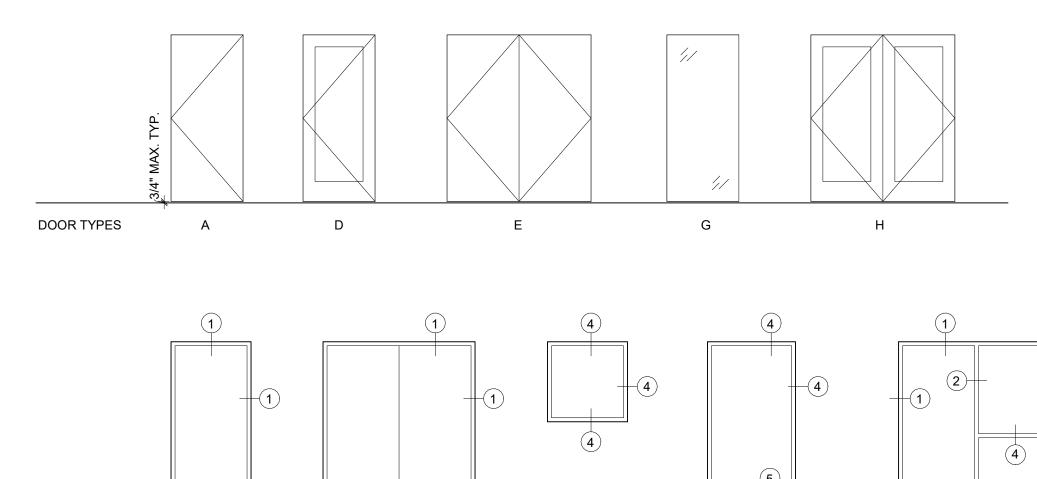
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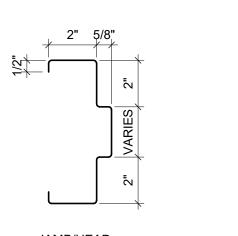
Key Plan

:; ⊐ DATE: File:

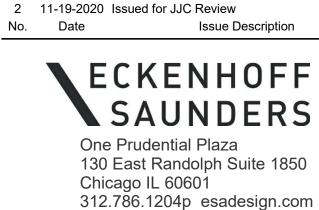								DOOR	SCHEDULE					
				DOOR					FRAME					
DOOR NO.	OF WIDTH	PENING SI	1	STYLE	MATERIAL	FINISH	GLASS	STYLE	MATERIAL	FINISH	HARDWARE	FIRE RATING	REMARKS	DOOR NO.
DOOR NO.			THION.	STILL		TINIOT	OLAGO	STILL			ULT		REMARKO	DOON NO.
1013	3' - 0"	7' - 0"	1 3/4"	A	WD	STAIN	G-4	J	НМ	PT-5	08	45 Min		1013
1015	3' - 0"	7' - 0"	1 3/4"	A	WD	STAIN	G-4	J	HM	PT-5	06	45 Min		1015
1018M	3' - 0"	7' - 0"	1 3/4"	A	WD	STAIN	G-1	J	HM	PT-5	09			1018M
1019	3' - 0"	7' - 0"	1 3/4"	A	WD	STAIN	G-4	J	HM	PT-5	13	45 Min		1019
1019A	3' - 0"	7' - 0"	1 3/4"	A	WD	STAIN	G-1	J	HM	PT-5	09			1019A
1019B	3' - 0"	7' - 0"	1 3/4"	A	WD	STAIN	-	А	HM	PT-5	08			1019B
1019CA	3' - 0"	7' - 0"	1 3/4"	А	WD	STAIN	G-1	J	HM	PT-5	12			1019CA
1019CB	3' - 0"	7' - 0"	1 3/4"	А	WD	STAIN	G-1	J	НМ	PT-5	12			1019CB
1019CC	6' - 0"	7' - 0"	1 3/4"	Н	WD & GLASS	STAIN	G-1 AT SIDELITE AND G-2 AT LITES	L	HM	PT-5	11			1019CC
1019DA	3' - 0"	7' - 0"	1 3/4"	A	WD	STAIN	G-1	J	HM	PT-5	06			1019DA
1019DB	4' - 0"	7' - 0"	1 3/4"	D	WD & GLASS	STAIN	G-4	A	HM	PT-5	10	45 Min		1019DB
1019E	4' - 0"	7' - 0"	1 3/4"	D	WD & GLASS	STAIN	G-1	Н	HM	PT-5	02			1019E
1019F	3' - 0"	7' - 0"	1 3/4"	A	WD	STAIN	-	A	HM	PT-5	06	45 Min		1019F
1019GA	3' - 0"	7' - 0"	1 3/4"	A	WD	STAIN	-	А	HM	PT-5	08			1019GA
1019GB	3' - 0"	7' - 0"	1 3/4"	A	WD	STAIN	-	A	HM	PT-5	08			1019GB
1019H	5' - 6"	7' - 0"	1 3/4"	E	WD	STAIN	-	В	HM	PT-5	05	45 Min		1019H
1019J	3' - 0"	7' - 0"	1 3/4"	A	WD	STAIN	G-1	J	HM	PT-5	07			1019J
1019K	3' - 0"	7' - 0"	1 3/4"	А	WD	STAIN	G-1	J	HM	PT-5	09			1019K
1102A	3' - 0"	7' - 0"	1 3/4"	А	WD	PAINT	-	A	HM	PT-1	06	45 Min		1102A
1102B	2' - 11 3/4"	7' - 6"	1/2"	G	GLASS	-	G-6	-	-	-	14			1102B
1110	3' - 0"	7' - 0"	1 3/4"	A	WD	STAIN	G-4	J	HM	PT-5	06	45 Min		1110




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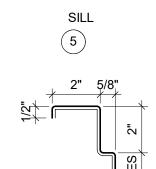



FRAME TYPES

Α







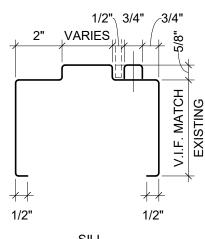


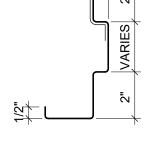




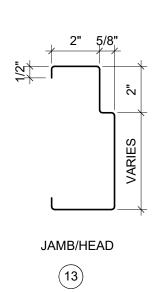


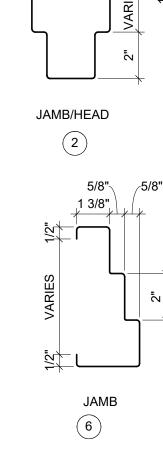

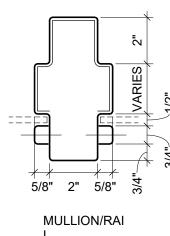



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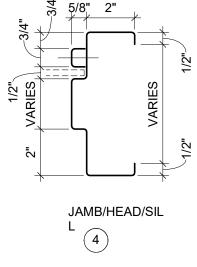

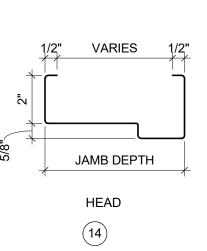
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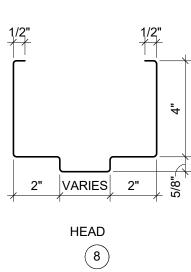


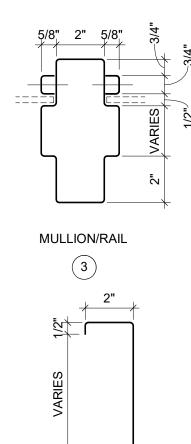



- GLAZING TAPE HEAD - 60 MINUTE RATED (15)

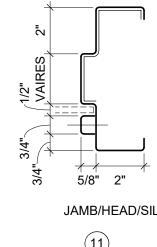

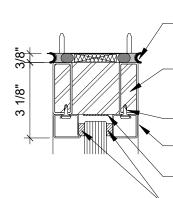
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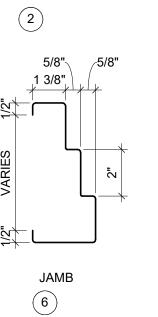


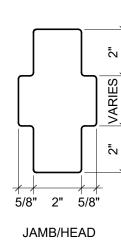


FIRE-RATED
 GLAZING MATERIAL

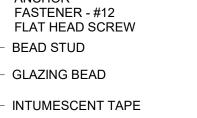
HORIZONTAL MULLION - 60 MINUTE RATED

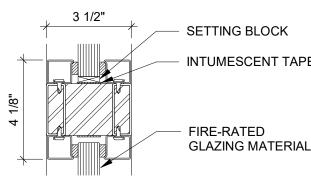
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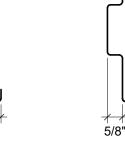





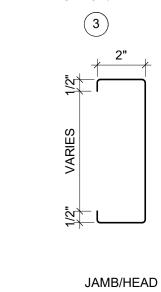



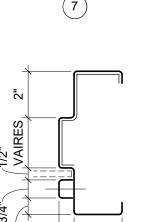


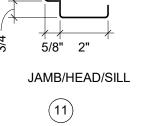

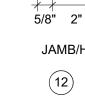






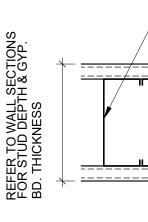

DRYWALL JAMB


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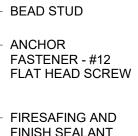
 DOUBLE 20 GA.
 METAL STUDS JAMB ANCHORS MIN. 3 PER JAMB, MIN. 4 WELDED-IN TYPE FOR RATED FRAMES _____

INTUMESCENT TAPE SILL - 60 MINUTE RATED

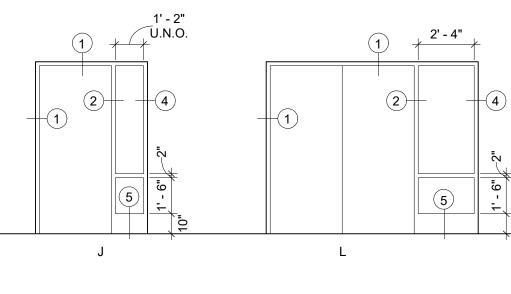

(17)

ANCHOR FASTENER - #12 FIRESAFING AND FINISH SEALANT

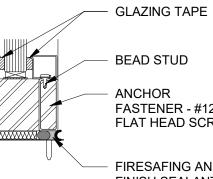

DOOR, FRAME, AND HARDWARE NOTES

6

1. ALL HARDWARE SHALL CONFORM TO APPLICABLE PROVISIONS OF THE AMERICANS WITH DISABILITIES ACT AND ALL APPLICABLE ACCESSIBILITY CODES.

2. KEYING CRITERIA WILL BE ESTABLISHED BY THE OWNER AFTER BID. ALLOW FOR INDIVIDUAL LOCK KEYING AND MULTIPLE MASTERS AND SUBMASTERS. THE HARDWARE CONTRACTOR SHALL PREPARE A SEPARATE KEYING SCHEDULE BASED UPON THE OWNERS CRITERIA.

3. PROVIDE NON REMOVABLE PINS AT ALL DOOR HINGES WHERE THE HINGE IS EXPOSED TO THE LOCK SIDE OF THE DOOR.

4. DOORS SHALL NOT BE LOCKABLE IN THE DIRECTION OF EXIT. ANY DOOR LOCKABLE IN THE DIRECTION OF EXIT SHALL BE TIED TO THE FIRE ALARM AND UNLOCK IN ALARM MODE.

5. PROVIDE UL LISTED HARDWARE AT ALL FIRE RATED DOORS.

6. IN GENERAL DOOR CLOSERS SHALL BE LOCATED ON THE ROOM SIDE OF THE DOOR. PROVIDE REGULAR OF PARALLEL ARMS AS NECESSARY.

7. PROVIDE HOLLOW METAL ASTRAGALS AT DOOR PAIRS WHERE REQUIRED TO ACHIEVE SPECIFIED UL LABEL. 8. THE CONTRACTOR SHALL COORDINATE THE VARIOUS HARDWARE COMPONENTS FOR EACH DOOR AND MAKE

NECESSARY MODIFICATIONS TO PROVIDE FOR A FULLY FUNCTIONING DOOR OPERATION. 9. PROVIDE DRILL IN DOOR SILENCERS AT ALL FRAMES.

10. MANUFACTURER SUBSTITUTIONS WILL NOT BE CONSIDERED FOR LATCH SETS AND CLOSERS.

11. PROVIDE LATCH GUARDS AT ALL EXTERIOR DOORS EXCEPT MAIN ENTRY.

12. PROVIDE SEALANT AT JUNCTION OF ALL FRAMES AND PARTITIONS. 13. WIDTH OF HOLLOW METAL FRAMES ARE ACTUAL

PARTITION THICKNESS PLUS 1 INCH (SEE PARTITION TYPES ON SHEET A9-0) EXCEPT FOR CMU PARTITIONS. PARTITION TYPES ARE KEYED ON FLOOR PLANS. 14. AT GYPSUM BOARD PARTITIONS PROVIDE 20 GAUGE

DOUBLE METAL STUDS AT ALL DOOR OR BORROWED LITE JAMBS.

15. PAINT ALL HOLLOW METAL DOORS UNLESS NOTED OTHERWISE. 16. MAXIMUM DOOR OPERATING PRESSURES ARE 5 LBS.

FOR INTERIOR DOORS AND 8 LBS. FOR EXTERIOR DOORS. 17. ALL RATED DOORS SHALL BE SELF CLOSING AND SELF-LATCHING.

Project	No.
191	30

Sheet Title

and Frame Types, Door and Frame Details A10.0

Door Schedule, Door


1215 Houbolt Rd, Joliet, IL 60431

Respiratory Therapy

Client / Project Name Joliet Junior College

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Key Plan


MEP/AV

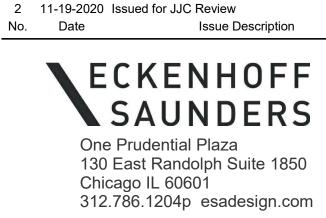
Structural


Affiliated Engineers, Inc. (AEI)

		•	INISH MATERIAL			
MARK	DESCRIPTION	MANUFACTURER	STYLE	COLOR	SIZE	
BASE					4"	
RB-1 CEILING	RESILIENT BASE	JOHNSONITE	TRADITIONAL COVE BASE	BLACK 40	4	
ACT-1	ACOUSTICAL CEILING TILE	USG	ASTRO CLIMAPLUS FLB EDGE 8227	WHITE	24"X24"X5/8"	SHADOWL
PT-6	PAINT - CEILING	SHERWIN WILLIAMS	FLAT	SNOWBOUND SW7004		
FLOOR			Г			
CPT-1	CARPET TILE	INTERFACE	OLD STREET	BLACK GRID 105745	50CM X 50CM	ASHLAR IN GC TO INS
CPT-2	CARPET TILE	INTERFACE	CUBIC	HEIGHT 6393	50CM X 50CM	MATCH EX OWNER P
RS-1	RUBBER SHEET	NORA	NORAPLAN SENTICA 1701	OCEAN MIST	3MM	INSTALL C
RT-1	VINYL COMPOSITION TILE	ARMSTRONG	IMPERIAL TEXTURE EXCELON	LAVENDAR SHADOW 51934	12"X12"	QUARTER
RT-2	VINYL COMPOSITION TILE	ARMSTRONG	IMPERIAL TEXTURE EXCELON	BLUE/GREY 51930	12"X12"	QUARTER
GLAZING				1		
G-1	GLAZING	-	VISION GLAZING	LOW-IRON	1/4" THK.	
G-2	GLAZING	-	ETCHED GLAZING		1/4" THK.	
G-3 MILLWOI	GLAZING	-	TRANSPARENT ONE-WAY MIRROR	GREY	1/4" THK.	
PL-1	PLASTIC LAMINATE	WILSONART	38 FINE VELVET TEXTURE FINISH	MONTICELLO MAPLE 7925		
PL-1 PL-2	PLASTIC LAMINATE	PIONITE	SUEDE	ICE FISHIN		
SS-1	SOLID SURFACE	LG HAUSYS	HI-MACS	GLITZ GP313		
WD-1	WOOD VENEER	-	-	-		MATCH EX
WG-3	MILLWORK	FRY REGLET	MILLWORK 1/4" POST OUTSIDE CORNER MWPOSC75	CLEAR ANODIZED ALUMINUM	3/4"	
WG-7	MILLWORK	FRY REGLET	DRYWALL "Z" REVEAL - DRMZ-100-100	WHITE	1" x 1"	
NG-8	MILLWORK	FRY REGLET	MILLWORK REVEAL "L" ANGLE - MWRL100	WHITE	1"	
WG-9	MILLWORK	FRY REGLET	MILLWORK REVEAL "F" - MWRF10050	WHITE	1"	
	ANEOUS					
EXIST	EXISTING FINISH TO REMAIN	N				
ML-1	MARKER SHELF	KOROSEAL	QUANTUM ALUMINUM TRAY	SILVER QUANTUM		MECHANIC ELEVATIO
TB-1	TACKABLE SURFACE	CARNEGIE	STRIE	6423W 811		
UPH-1		ARC COM	EBB-X AC-33304X	SURF #5		
FRANSIT	TRANSITION STRIP	SCHLUTER	RENO-U	AEU80		VCT TO CA
TS-1 TS-2	STAIR NOSING	NORA	STAIR NOSING T 5044 E/F	0702		MITER ALL
WALL		NORA		0102		
PT-1	FIELD PAINT	SHERWIN WILLIAMS	EGGSHELL	SNOWBOUND SW7004		TYPICAL T
PT-2	ACCENT PAINT	ICI	EGGSHELL	AMBER COAST 50YR 23/365		
PT-3	ACCENT PAINT	BENJAMIN MOORE	EGGSHELL	KENSIGNTON BLUE 840		
PT-4	ACCENT PAINT	BENJAMIN MOORE	EGGSHELL	WETHERSFIELD MOSS HC-100		
PT-5	PAINT - HM DOORS AND FRAMES	SHERWIN WILLIAMS	SHER-CRYL HPA ACRYLIC B66T354 BASE	ARCHITECTURAL BROWN - MATCH EXISTING		
WC-1	WHITE BOARD	3M POST-IT	SUPER STICKY DRY ERASE SURFACE	WHITE		APPLIED D ENTIRE W PROVIDE I CONTINUC EDGE.
WC-2	ACCENT WALL MATERIAL	MODULAR ARTS	MINERAL COMPOSITE PANELS - DUNE	WHITE	32" X 32"	SHOP FINI ILLUMINAT CLEAR CC
	ROTECTION					
WG-1	CORNER GUARD	INPRO	160 SURFACE MOUNT CORNER GUARD			
WG-2			1400 WALL GUARD	FEATHER 0238		
WG-4 WG-5	CORNER GUARD WALL GUARD	INPRO INPRO	160 SURFACE MOUNT CORNER GUARD 1400 WALL GUARD	BRITTANY BLUE 0135 BRITTANY BLUE 0135		
NG-5 NG-6	RIGID SHEET WALL	INPRO	PALLADIUM	FEATHER 0238	SEE	
vv U-U	PROTECTION				ELEVATIONS	
	/ TREATMENT			-	-	·
WT-1	WINDOW SHADES	LUTRON SHADING BY	BASKETWEAVE 90 - 3%	CHARCOAL/GRAY		OR EQUAL

*ALL FINISHES LISTED ARE BASIS OF DESIGN. PLEASE REFER TO THE PROJECT MANUAL FOR SUBSTITUTION PROCEDURES.

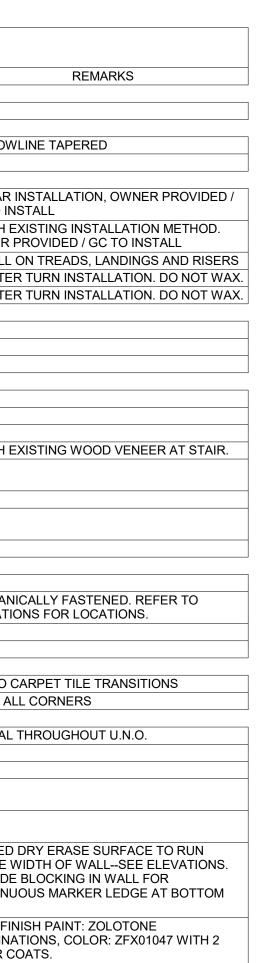

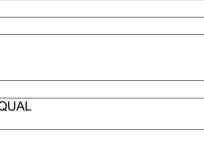

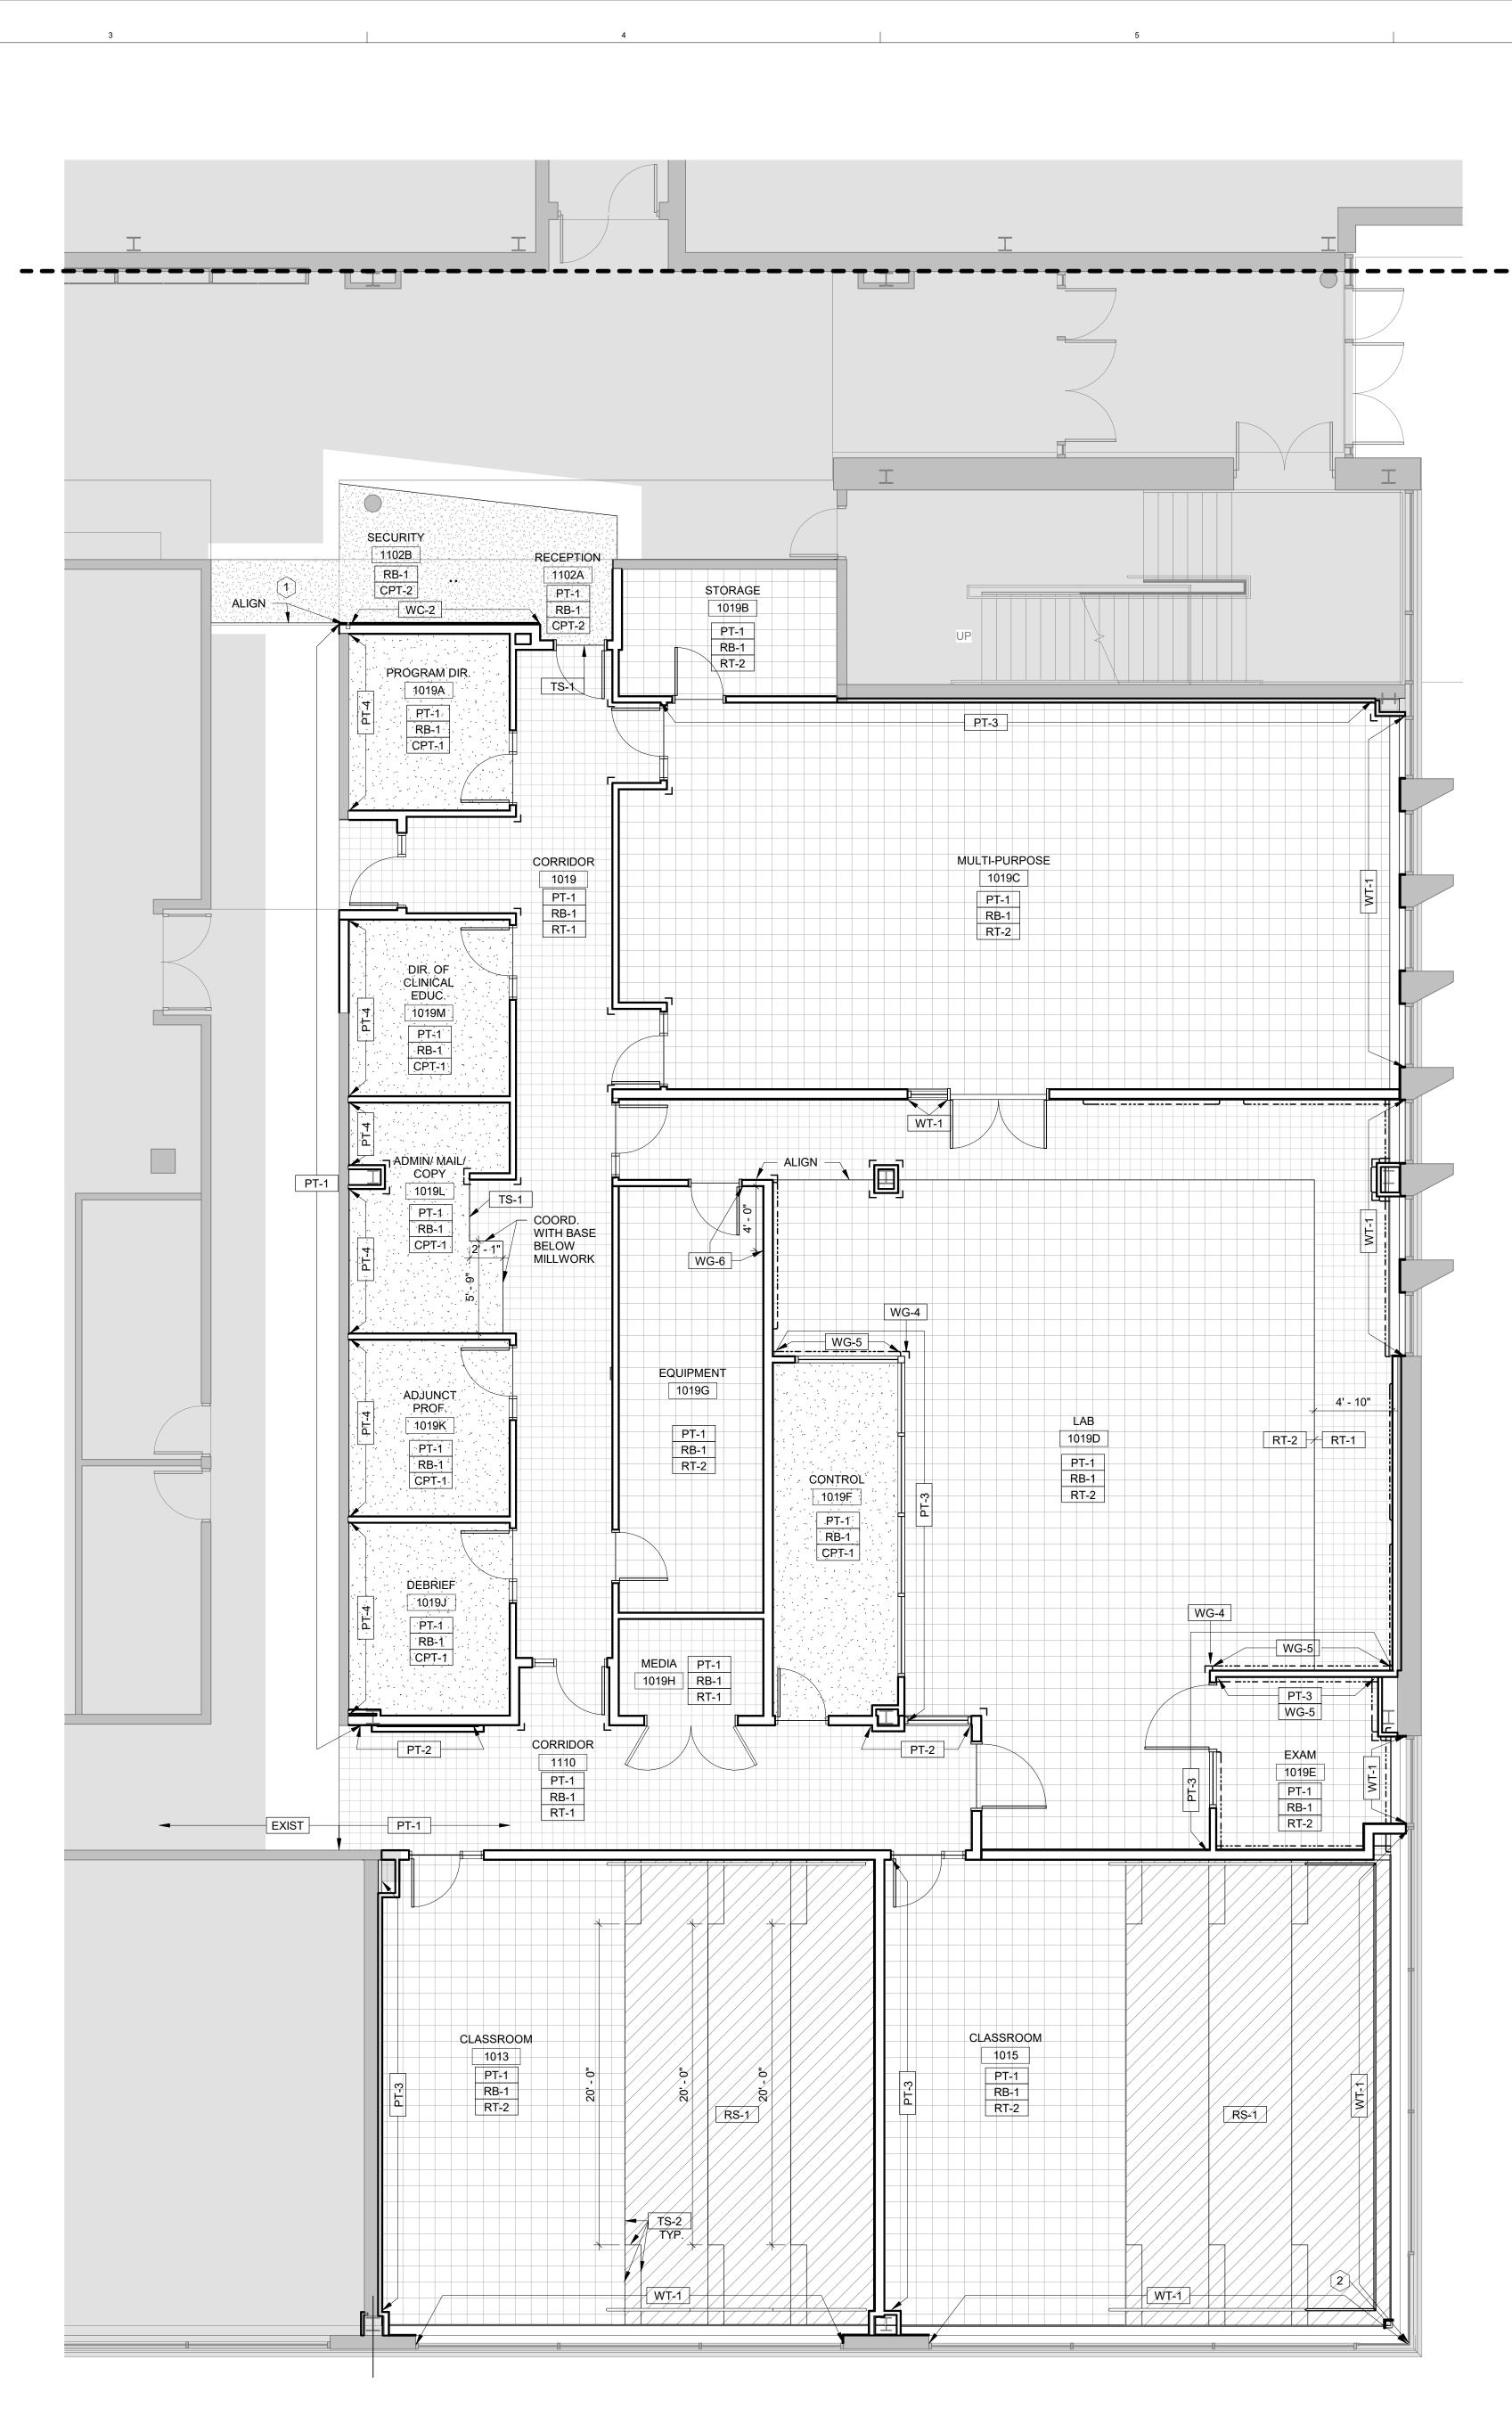

FINISH	LEGEND
XX-0 XX-0 XX-0	- WALL TAG - BASE TAG - FLOOR TAG
	BUMPER GUARD WALL PROTECTION
	CARPET TILE
	RT-1
	RT-2
	RS-1
Г	CORNER GUARD

FINISH NOTES

FINISHES.

1. ALL INTERIOR WALLS TO BE PAINTED PT-1, U.N.O.

FLOOR PATTERN

DIRECTION INDICATOR

2. ALL WALLS TO RECEIVE RB-1, U.N.O.

3. ALL DRYWALL CEILINGS OR SOFFITS TO BE PAINTED IN AN EGGSHELL FINISH ON THE VERTICAL SURFACE AND A FLAT FINISH ON THE UNDERSIDE OF THE CEILING/SOFFIT.

4. ALL BUMPER GUARDS TO BE WG-2 U.N.O. INSTALL WHERE INDICATED ON THE FINISH PLAN. 5. ALL CORNER GUARDS TO BE WG-1, U.N.O. CORNER

GUARDS TO BE INSTALLED FROM TOP OF WALL BASE TO CEILING IN ALL ENCLOSED ROOMS AND CORRIDORS. 6. ALL FLOORING TRANSITIONS TO OCCUR AT THE

CENTERLINE OF DOOR U.N.O. 7. CENTER VCT AND CARPET TILES IN ROOM, TYP. 8. SEE ELEVATIONS AND DETAILS FOR MILLWORK

9. ALL NEW AND EXISTING HOLLOW METAL DOOR FRAMES TO BE PAINTED PT-5.

10. COVER PLATES AND DEVICES FOR ELECTRICAL AND DATA OUTLETS TO BE WHITE. UPGRADE EXISTING OUTLETS AND DEVICES TO MATCH.

12. REFER TO ELEVATIONS FOR LOCATIONS OF WHITEBOARD MATERIAL.

13. PROVIDE WINDOW TREATMENTS WT-1 FOR ALL EXTERIOR WINDOWS IN SCOPE OF WORK.

14. PROVIDE FLOOR SEAMING DIAGRAM.

15. PAINT ALL ELECTRICAL PANELS IN THE SCOPE OF WORK TO MATCH THE ADJACENT WALLS. 16. NEW MILLWORK TO RECEIVE RB-1 AT THE TOEKICK.

17. FLOOR FINISHES TO EXTEND UNDER MILLWORK AND COUNTERS AT KNEE AND EQUIPMENT SPACES.

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1 REMOVE EXISITING VCT AND INSTALL CPT-2 [1 2 2PAINT COLUMN PT-1

Project No. 19130

A11.0

Sheet Title Finish Plan and Material Schedule

1215 Houbolt Rd, Joliet, IL 60431

Respiratory Therapy

Joliet Junior College

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3 11-30-2020 Issued for Bid

2 11-19-2020 Issued for JJC Review




Key Plan

MEP/AV Affiliated Engineers, Inc. (AEI) Structural Helen Torres & Associates, PLLC

EQUIPMENT SCHEDULE

EQUIPMENT		O = OWNER / C = CONTRACTOR		
NO.	DESCRIPTION	FURNISH	INSTALL	SPECIAL REQUIREMENTS / REMARKS
1	COMPUTER AND MONITOR(S)	0	0	
2	DESK PHONE	0	0	
3	PRINTER	0	0	
4	FLOOR COPIER / PRINTER	0	0	
5	MICROSOFT HUB	0	C	
6	SOAP DISPENSER	0	C	
7	MANUAL PAPER TOWEL DISPENSER	0	C	
8	HAND SANITIZER DISPENSER	0	C	
9	PRIVACY CURTAIN AND TRACK	С	С	
10	BP CUFF AND MOUNT	0	С	
11	MONITOR ON ARTICULATING ARM	0	C	
12	PATIENT BED	0	0	
13	SHARPS CONTAINER (WALL MOUNTED)	0	С	
14	RESPIRATOR	0	0	
15	SHELVING UNIT 24" X 60" FIXED	0	0	
16	KANBAN HIGH DENSITY STORAGE UNIT	0	0	
17	OXYGEN CONCENTRATOR	0	0	
18	OXYGEN TANK CARTS	0	0	
19	OXYGEN TANK	0	0	

FURNITURE SHOWN DASHED FOR CONTEXT BY OTHERS

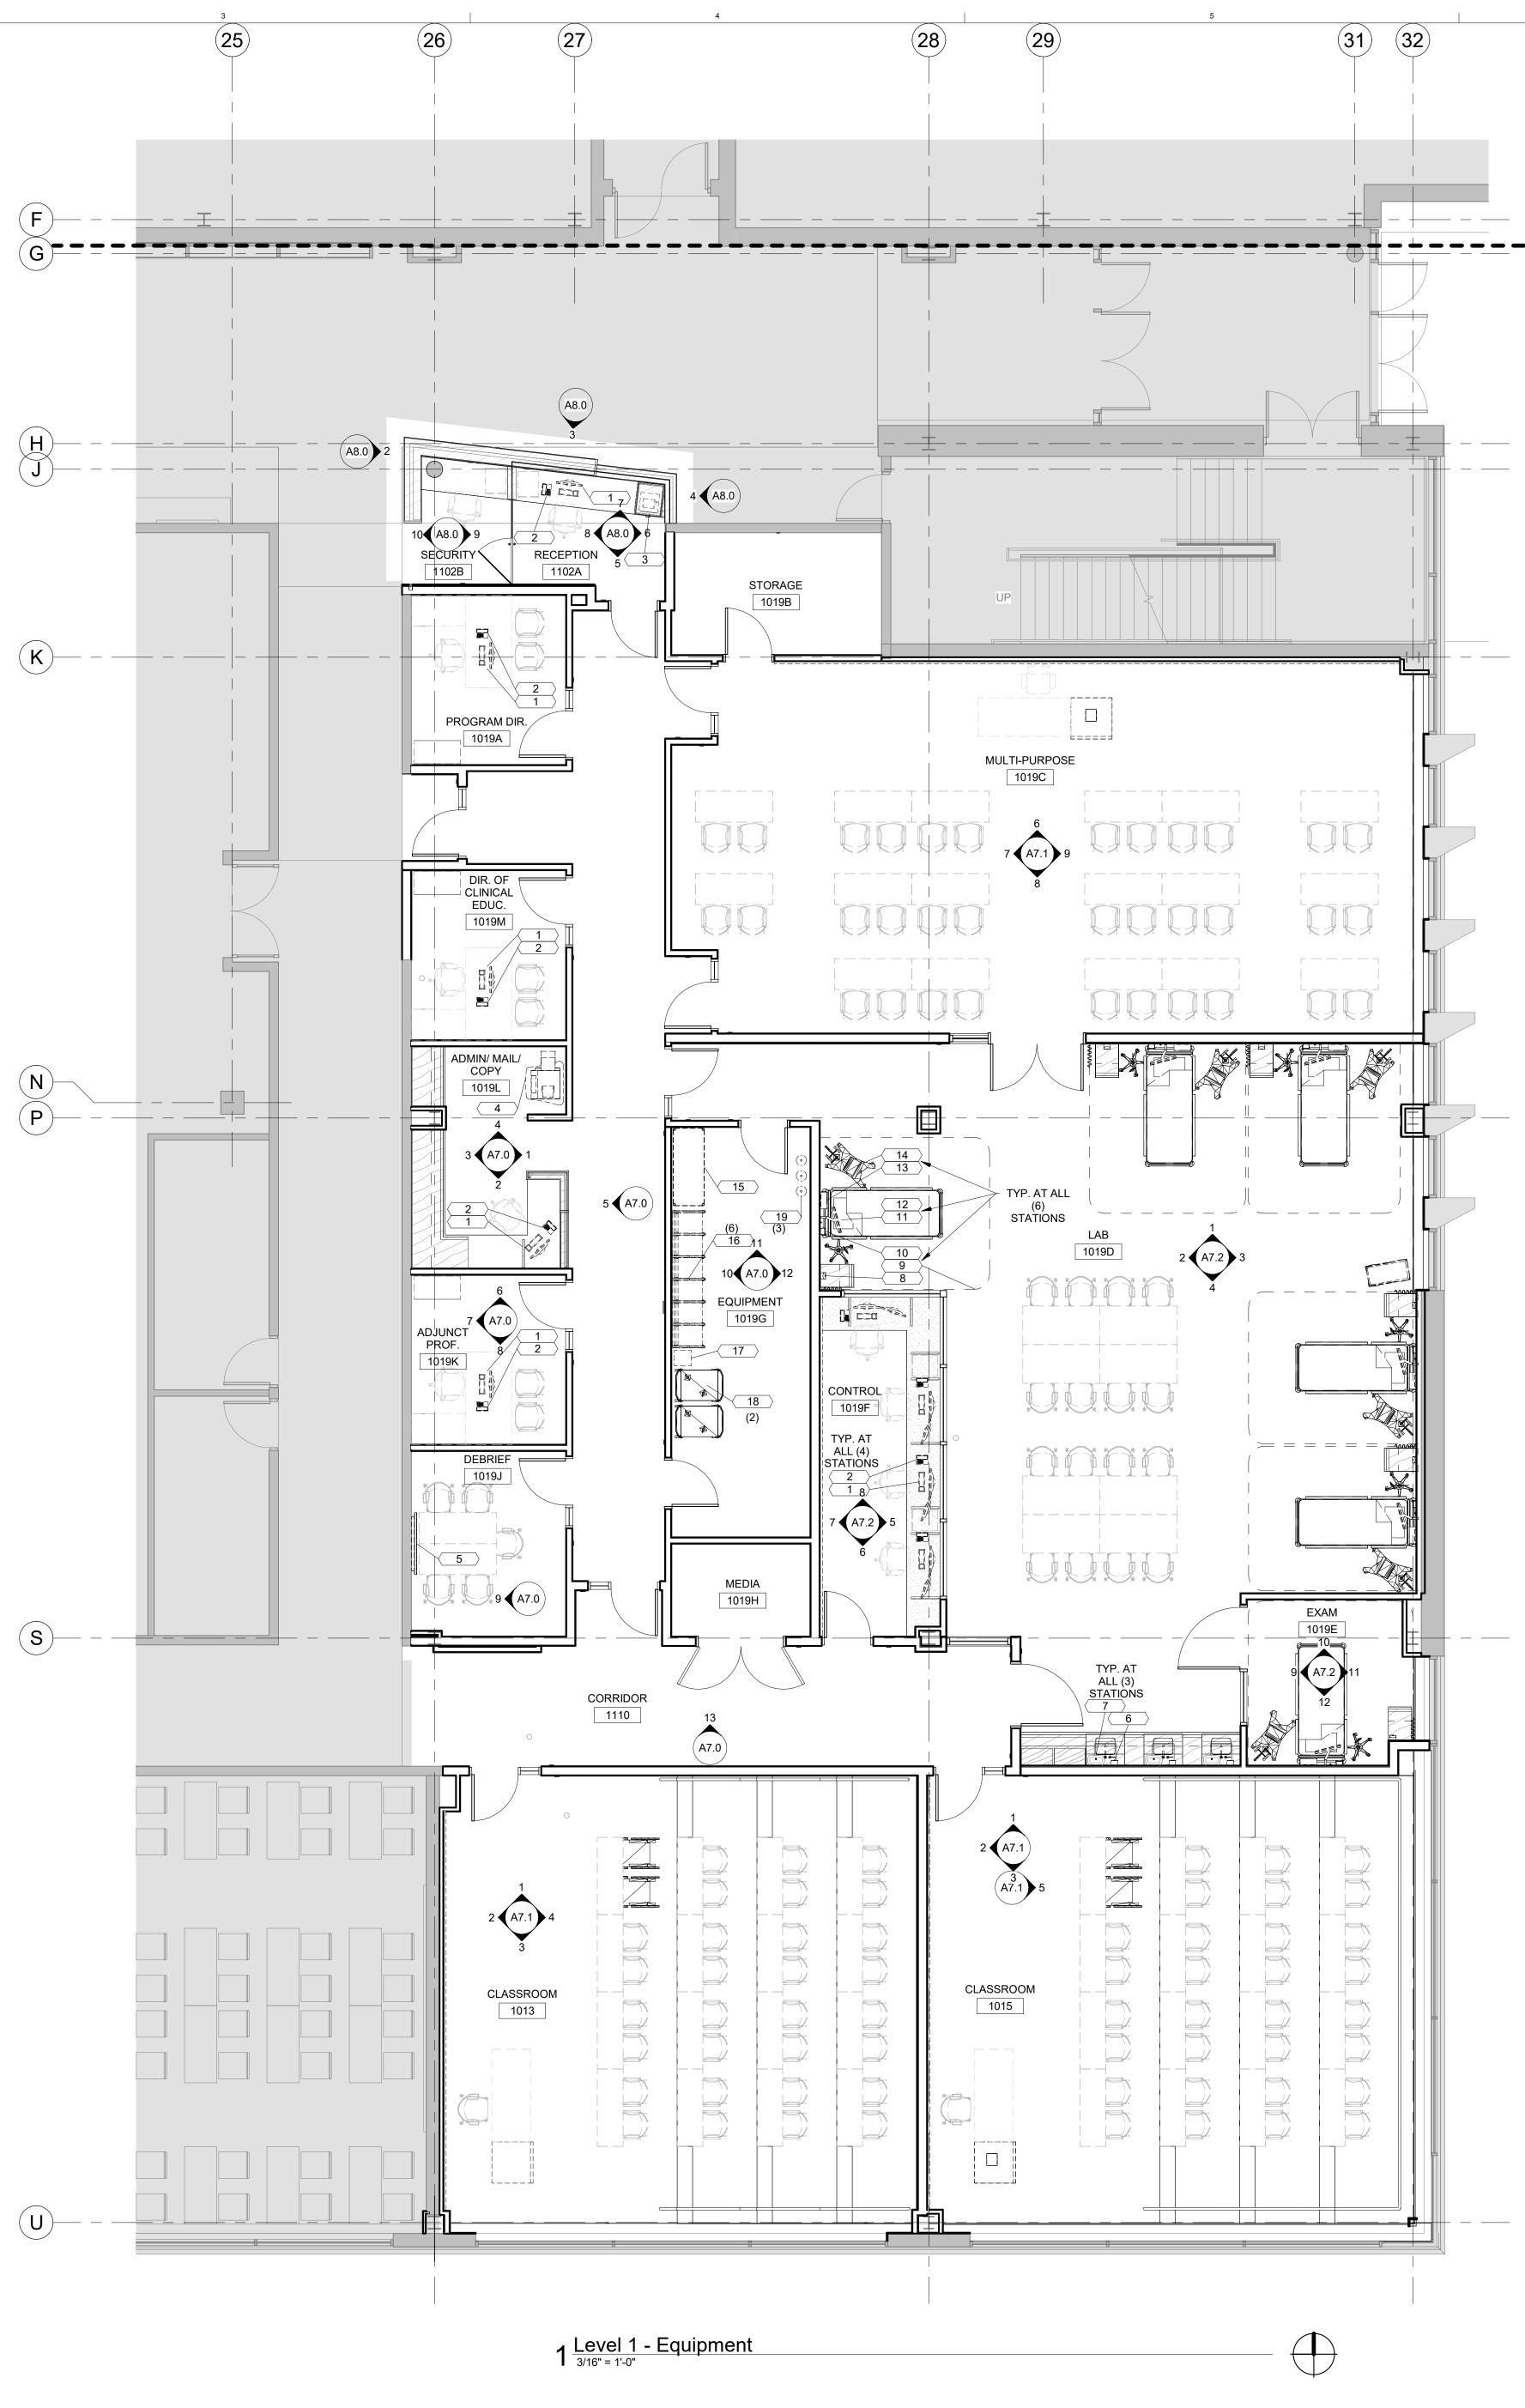

Pr	oject	No
1	91	30

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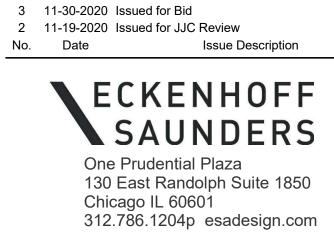
Equipment Plan and Schedule

1215 Houbolt Rd, Joliet, IL 60431 Sheet Title

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Key Plan

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