

DATE: December 12, 2018

Joliet Junior College 1215 Houbolt Road Joliet, IL 60431

TO: Prospective Respondents

SUBJECT: Addendum No. 1

PROJECT NAME: Food Services Operation

JJC PROJECT NO.: R18017

This Addendum forms a part of the Bidding and Contract Documents and modifies the original bidding document as posted on the JJC website. Acknowledge receipt of this addendum as specified at the end of this addendum. FAILURE TO DO SO MAY SUBJECT BIDDER TO DISQUALIFICATION.

Additional Information:

Attachment A, as mentioned within the RFP document, is attached to this addendum.

End of Addendum #1



DATE: December 12, 2018

Joliet Junior College 1215 Houbolt Road Joliet, IL 60431

TO: Prospective Respondents

SUBJECT: Addendum No. 1

PROJECT NAME: Food Services Operation

JJC PROJECT NO.: R18017

Please acknowledge receipt of these addenda by including this page with your proposal. Include your company name, printed name, title, and signature in your acknowledgement below. Failure to do so could result in disqualification of your bid.


Issued by:

Janice Reedus Director of Business & Auxiliary Services Joliet Junior College 815.280.6643

I acknowledge receipt of Addendum #1.

Company Name
Printed Name
Title
Signature

tem	<u></u>	Fauinment Catagory	Fauinment Demarks
No I	Qty 1	Equipment Category Remote Rack Refrigeration	Equipment Remarks
;	1 1	Walk—In Beverage Cooler Evaporator Coil, Beverage Cooler	8'-6" Exterior Height
-		Aluminum Trim Filter System, Icemaker	Custom
5	1	Ice Maker	
7 }	1 1	Bin, Ice Floor Trough	
10	1	Walk—In Cooler Evaporator Coil, Cooler	10'-0" Exterior Height
l 1	1	Walk-In Freezer	10'-0" Exterior Height
12 13	1 1	Evaporator Coil, Freezer Walk—In Cooler	10'-0" Exterior Height
14	1	Evaporator Coil, Cooler	
15 16		Shelving, Plastic, Louvered Shelving, Wire	
17 18		Shelving, Wire Pot Rack, Ceiling Mount	Mobile Custom
19	1	Work Table with Sinks	Custom
20 21		Over Shelf Brute Container	Custom Mobile
22	1	Cutter/Mixer, Vertical & Veg. Prep. Stand, Equipment	Mobile
24	1	Slicer, Food	Mobile
25 26	1 1	Stand, Equipment w/ Utensil Rack Mixer	Mobile
27	1	Work Table with Sinks	Custom
28 29	1	Over Shelf Double Over Shelf	Custom Custom
30 31	2	Table, Work Work Table	Mobile Custom
32	1	Filter System, Coffee Maker	
33 34	3	Coffee Maker, Insulated Server Sink, Hand, Wall Mount	By Vendor
34.1	1	Sink, Hand, Wall Mount	
35 36	-	Wastebasket Faucet, Service Sink	
37 38	1	Hood Control System Exhaust Hood	
39		Fire Protection System	
10 11	1 2	Utility Distribution System Filter System, Steamer	
12	1	Oven—Steamer, Combination	
43 44	1 1	Tilt Skillet Work Table	Custom
45 46	-	Floor Trough Filter System, Steamer	
47	1	Steamer, Convection	
18 19	1 1	Griddle, Gas Range with Convection Oven	
50 51	2	Fryer, Deep Fat, Gas w/Filter	
52	1	Exhaust Hood Oven—Steamer, Combination	
53 54	1 1	Work Table with Sink Over Shelf	Custom
55		Broiler, Gas	
56 57	-	Spare Number Rack, Utility	
58 59	1	Refrigerator, Roll—Thru Cabinet, Heated, Roll—Thru	
60 60	1	Cabinet, Heated, Roll—Thru	
61 62	Lot 1	Stainless Steel Trim Sink, Hand, Wall Mount	Custom
63	1	Wastebasket	Cuptors
64 70	Lot 1	Stainless Steel Corner Guard Refrigerator, Reach—In	Custom
71		Sink, Scullery, 1 Compartment Fire Protection System	
74	1	Low Height Refrigerator	
75 76	 	Griddle, Gas Stainless Steel Splash Guard	Custom
77 78	1	Drop—In, Cold Pan Griddle, Gas	
33		Shelf, Microwave	
44	1 Lot	Toaster, Conveyor Slim Jim Waste Container	
149	1	Soiled Dishtable	Custom
50 51	1	Glass Rack Shelf Disposer, Garbage	Custom
52 53	-	Spare Number Spare Number	
54	_	Spare Number	
55 56	1	Warewasher Vent Duct	Custom
157	1	Vent Duct	Custom
158 159	1	Clean Dishtable Shelf, Wall Mount	Custom
160 161	1	Sink, Scullery, 3 Compartments Shelf W/ Pot Rack, Wall Mount	Custom
162	2	Shelving, Plastic, Louvered	
163 164	1 1	Spray System, Portable Sink, Mop w/ Mop Hanger	
165	1	Faucet, Service Sink	
166		Shelving, Wire Mop Bucket Wringer	

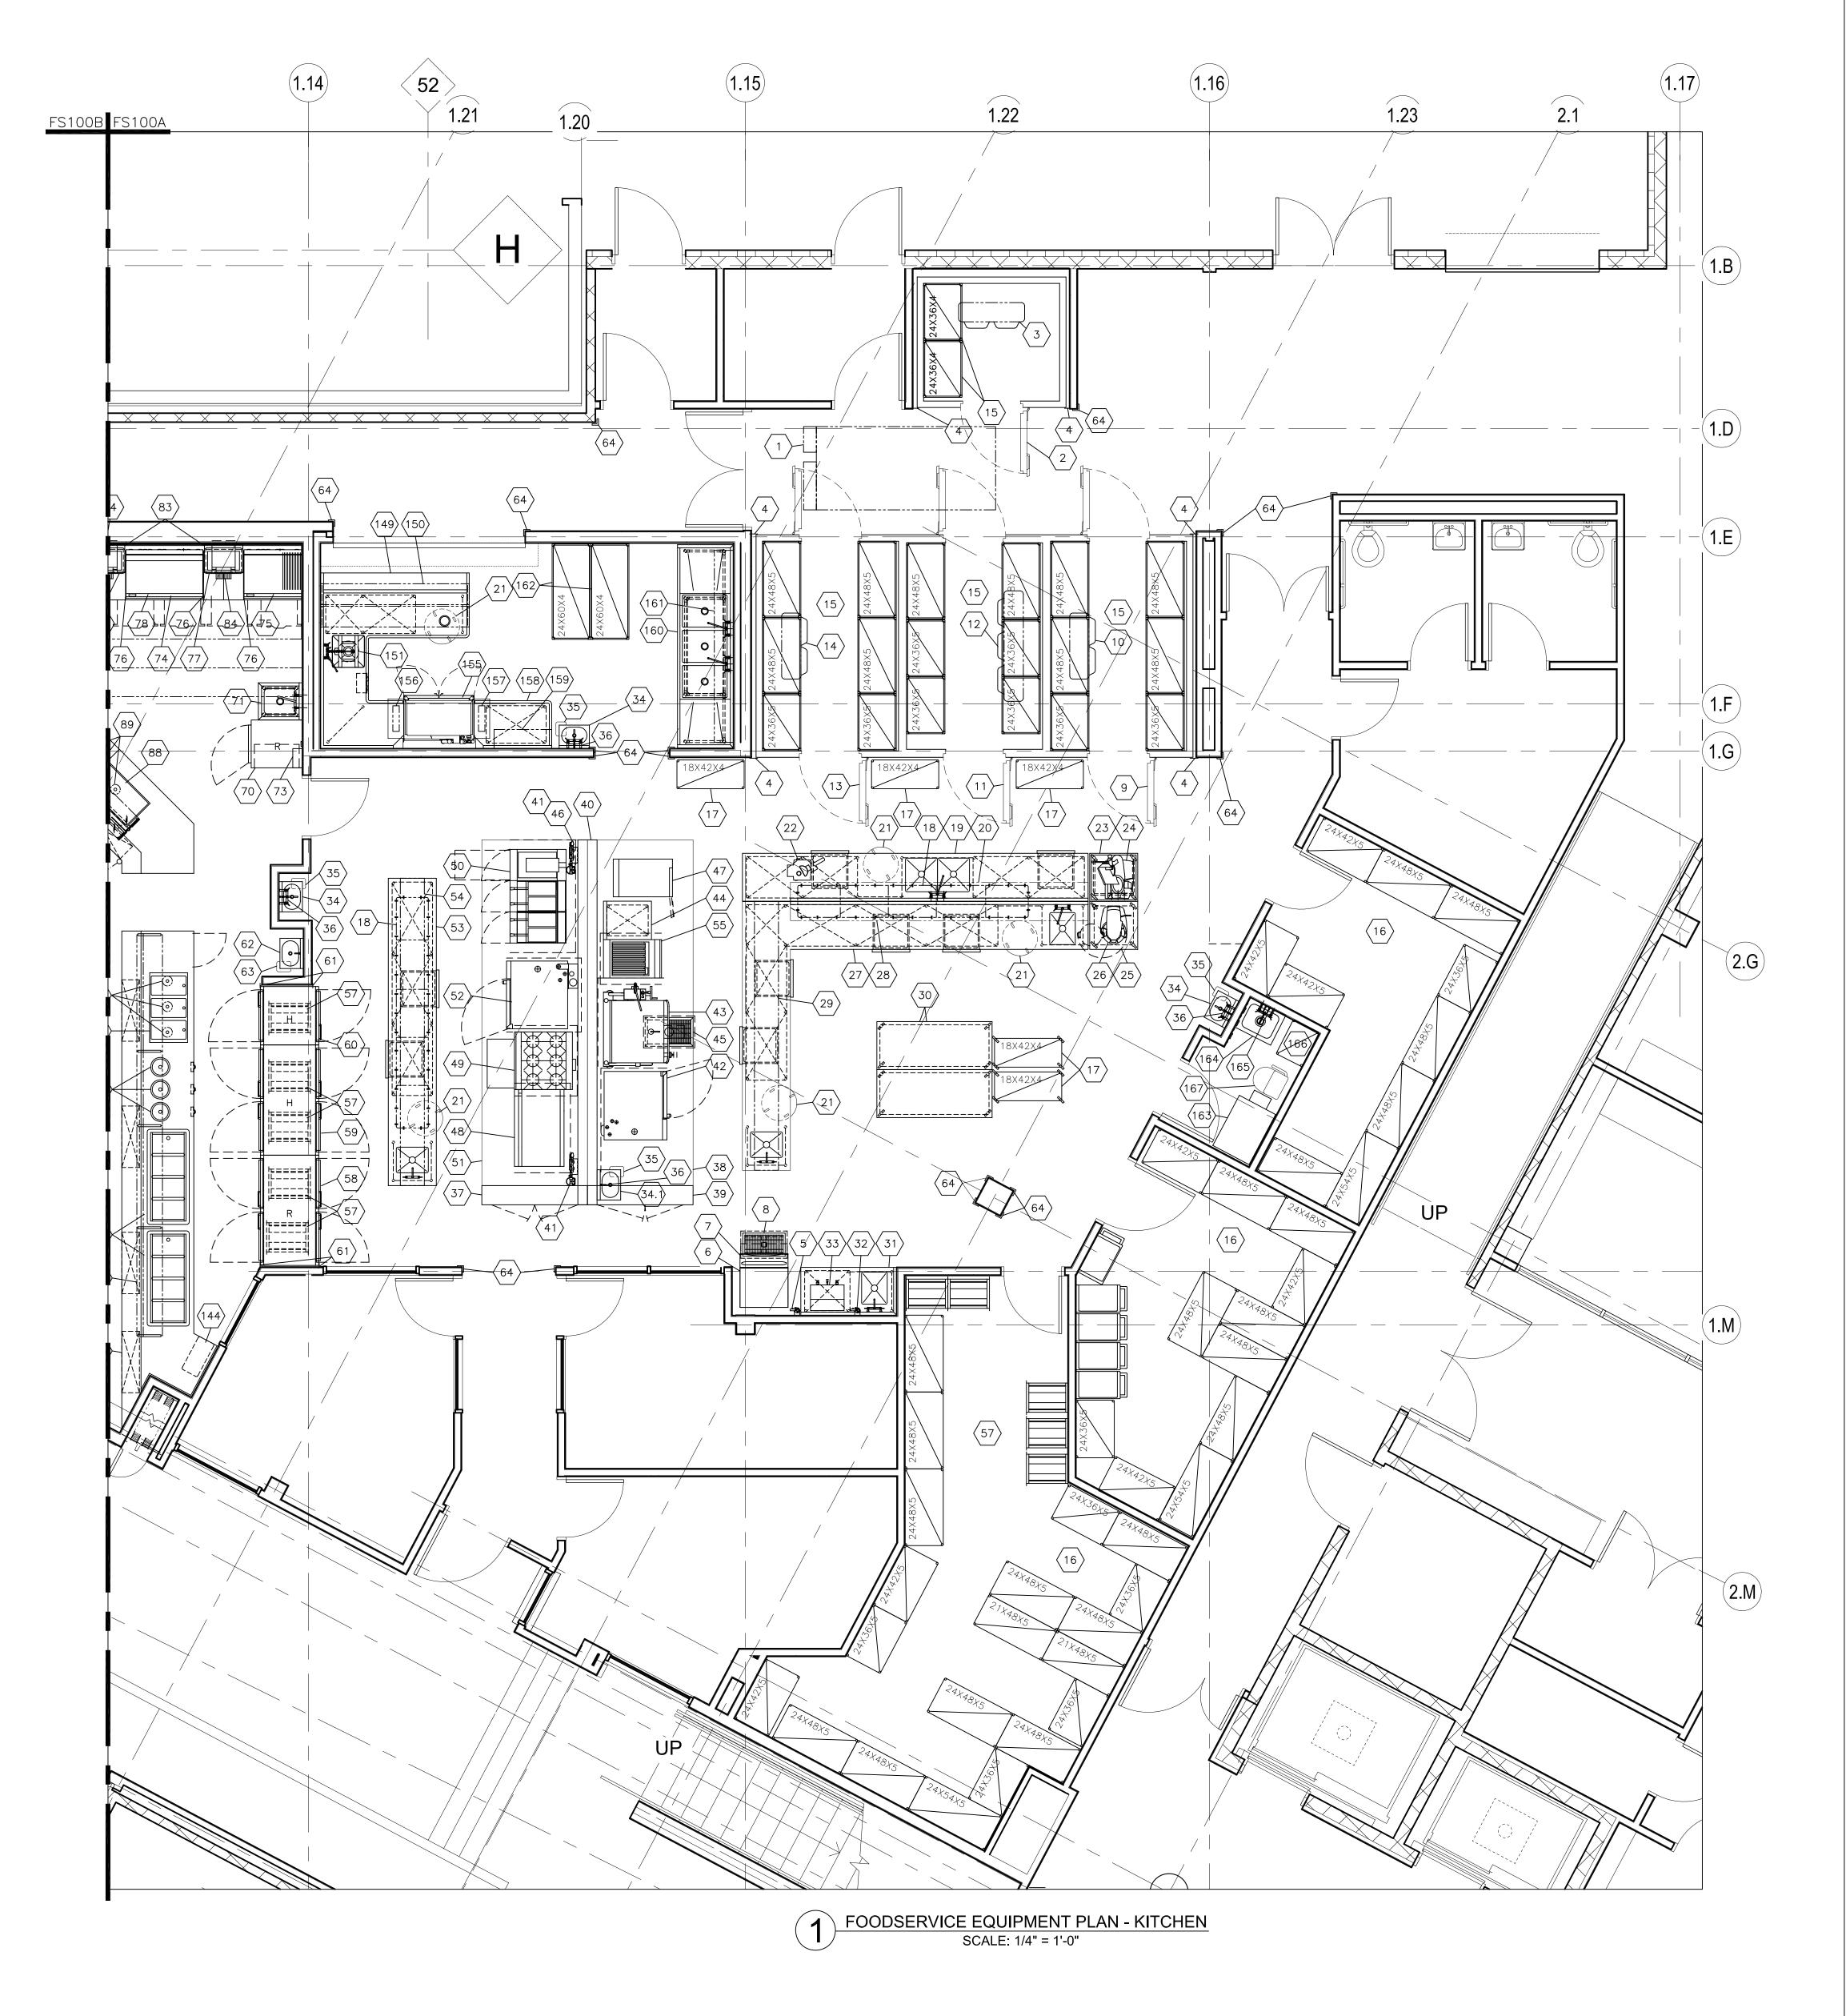

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FOR JOLIET JR. COLLEGE

FOODSERVICE EQUIPMENT DIVISION

2500 S. HARLEM AVE., NORTH RIVERSIDE, IL 60546

TEL.: (708) 883-8000

FOODSERVICE EQUIPMENT PLAN

DRAWN BY:
E. DERKACH


APPROVED BY:
P. RIVERA

SUBMITTED BY:
P. RIVERA

SCALE: 1/4"=1'-0"

SHEET:

DRAWING NO 10-0101

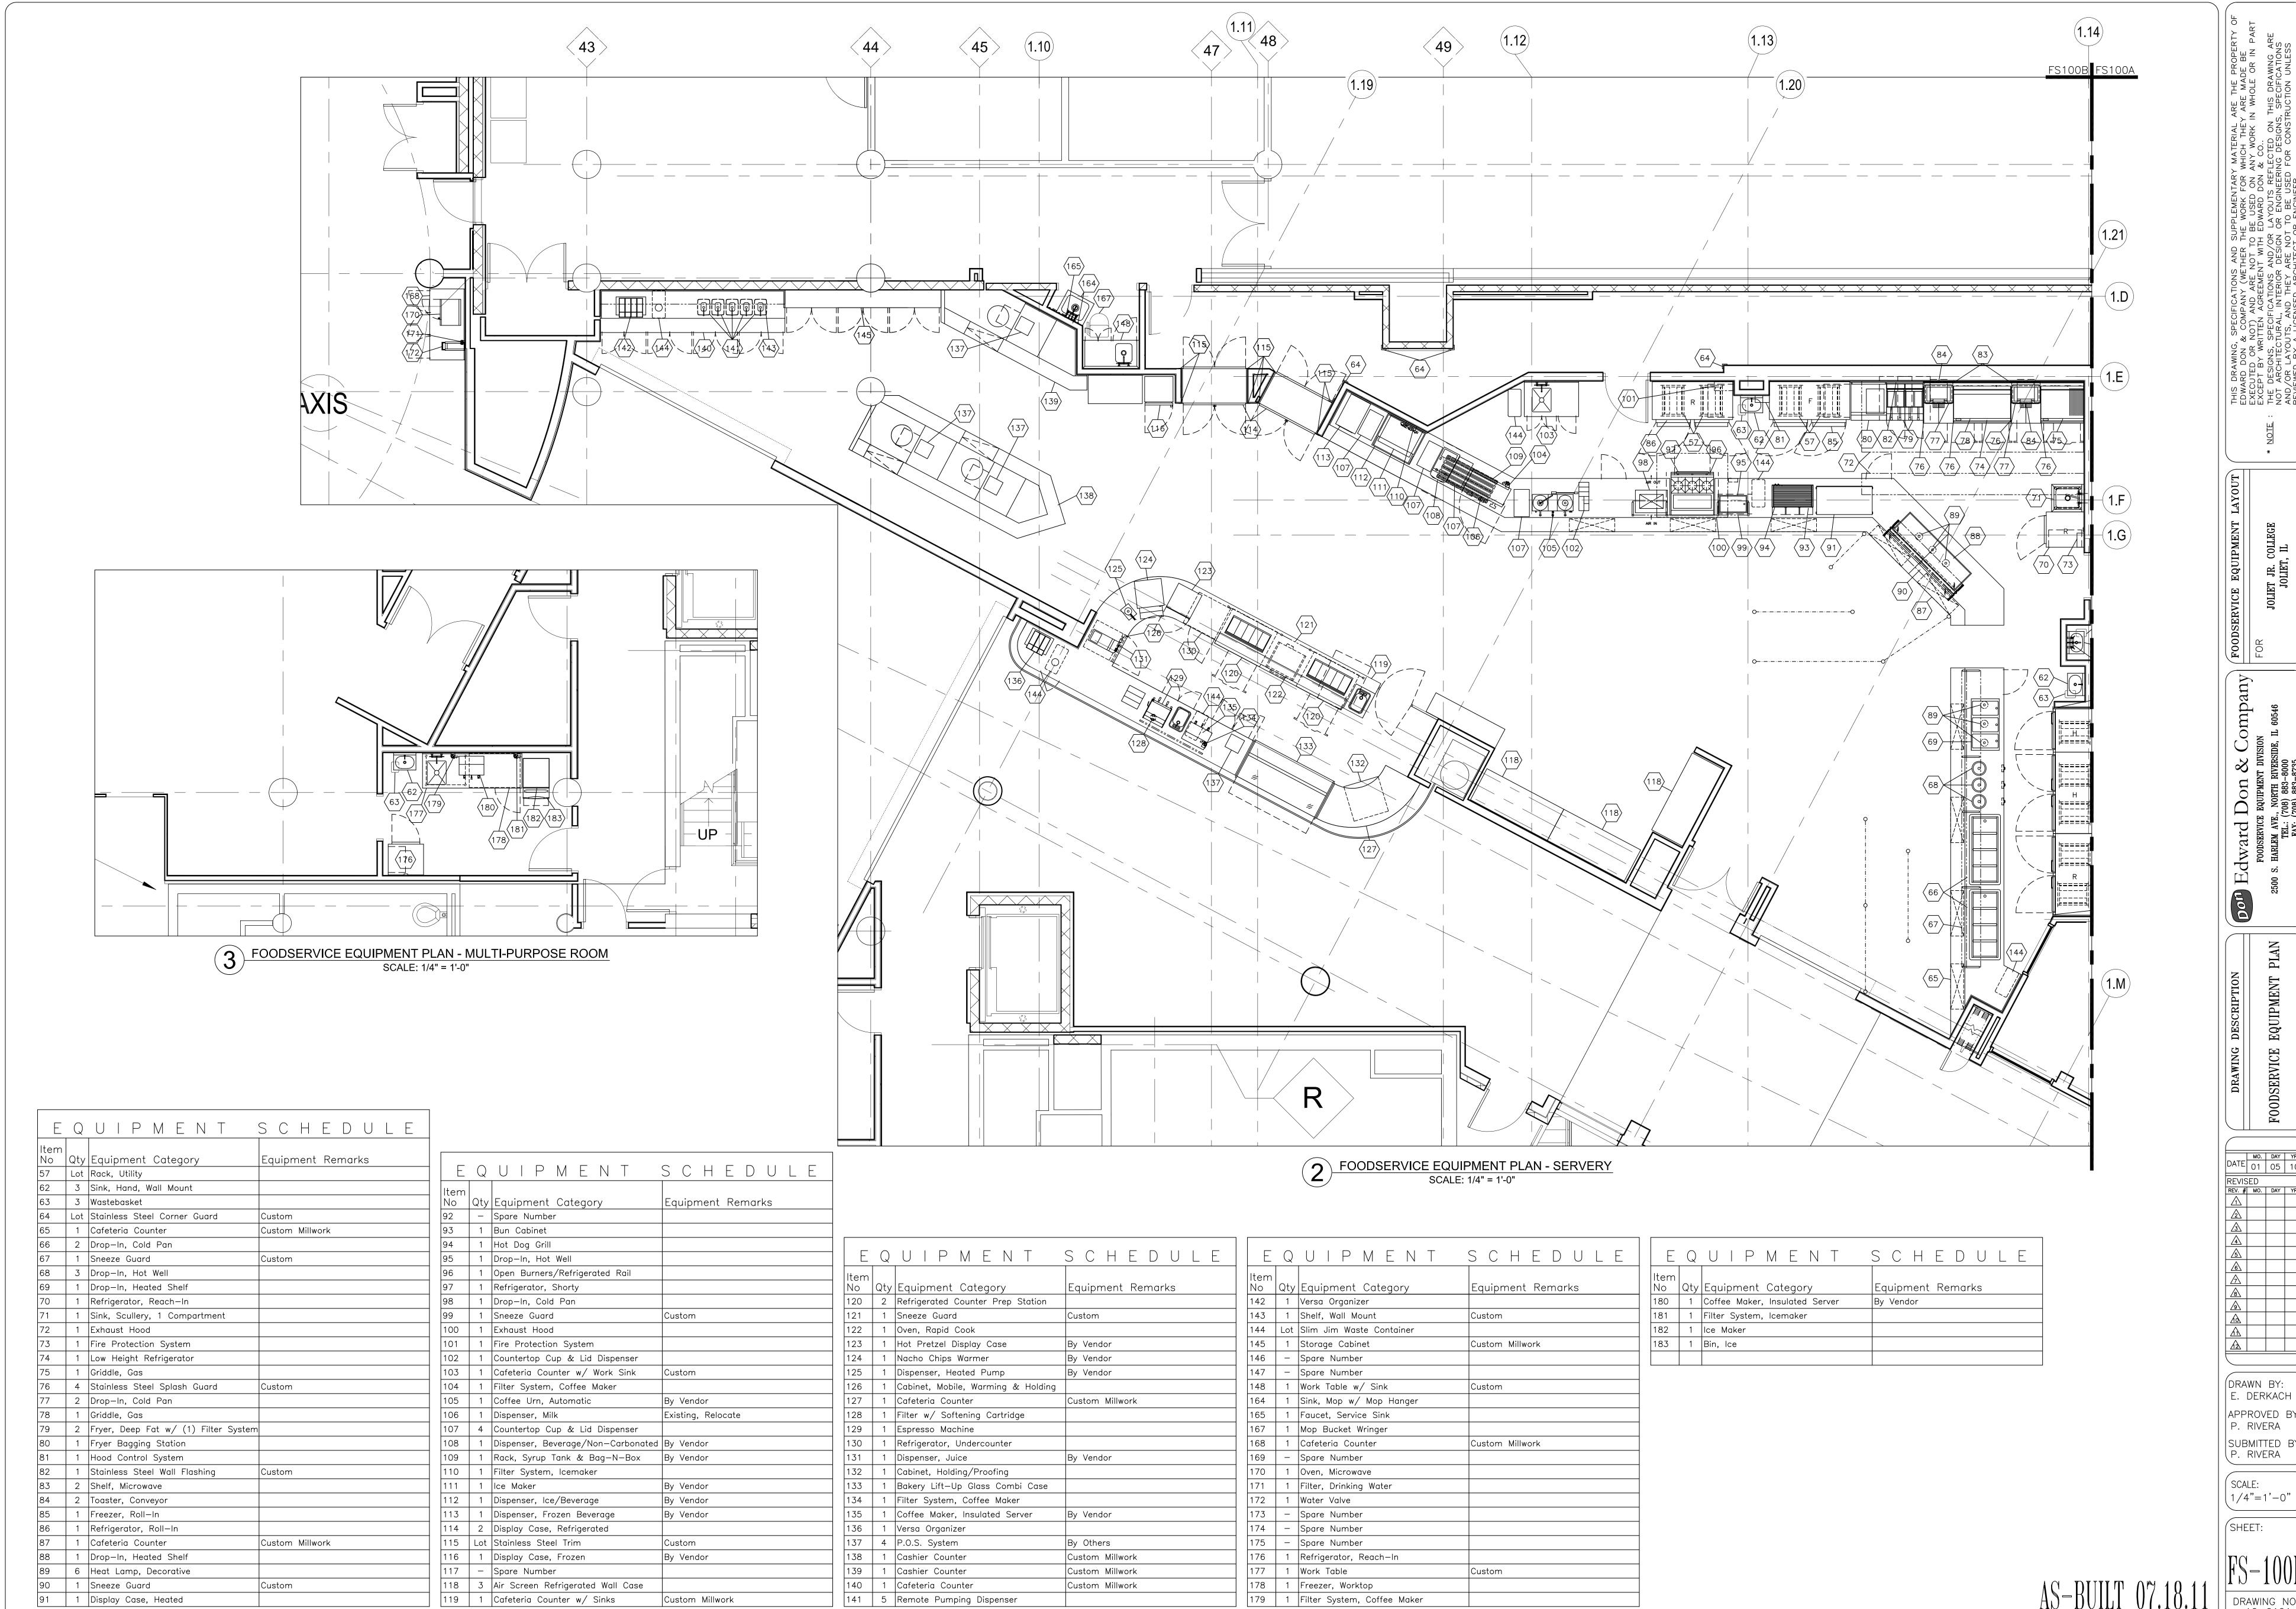

E. DERKACH APPROVED BY: SUBMITTED BY: P. RIVERA

GENERAL ELECTRICAL ABBREVIATIONS: AFF ABOVE FINISHED FLOOR KW KILOWATT HP HORSEPOWER EC ELECTRICAL CONTRACTOR

	ELECTRICAL LEGEND							
SYM.	ABB.	DEFINITION						
	J-BOX SO DO DCO SW POC	ELECTRICAL JUNCTION BOX SINGLE OUTLET DUPLEX OUTLET DUPLEX CONVENIENCE OUTLET SWITCH POINT OF CONNECTION ELECTRICAL CONDUIT STUB-UP COOLER/FREEZER ALARM PANEL VAPOR PROOF WALK-IN DOOR LIGHT PROVIDED/INSTALLED BY FSEC. EC TO CONNECT. ADDITIONAL VAPOR PROOF LIGHT PROVIDED/MOUNTED BY FSEC. EC TO WIRE.						

ELECTRICAL ROUGH-IN SCHEDULE

115 1

120/208 3 X

120

120

120

120

120

115

120 | 1 |

120 | 1 |

208/240 1 X

120 | 1 |

115 1

115 | 1 |

115

115

208

120

208

120

120

120

6" Two Common Point of Connection

X 48" E.C. to Supply NEMA 5-20R Duplex Receptacle

48" E.C. to Verify Requirements with Vendor

X 18" Unit Supplied w/ NEMA 5-15P Cord & Plug

Direct Connection — From Item 40

E.C. TO E.C. to Supply Open Conduit Hood Electrical LOCATE E.C. to Verify Requirements w/ HVAC Contractor

72" E.C. to Wire from JB to Equipment Mounted JB

E.C. TO E.C. to Supply Open Conduit Hood Electrical LOCATE E.C. to Verify Requirements w/ HVAC Contractor

X ABOVE Unit Supplied w/ NEMA 5-15P Cord & Plug

X 18" Unit Supplied w/ NEMA 5-15P Cord & Plug

Direct Connection — From Item 65

Direct Connection — From Item 65

X 88" Unit Supplied w/ NEMA 5-15P Cord & Plug

X 18" Unit Supplied w/ NEMA 5-15P Cord & Plug

X 60" Unit Supplied w/ NEMA 6-15P Cord & Plug

18" E.C. to Wire from JB to Equipment Mounted JB

120" E.C. to Wire from JB to Equipment Mounted JB

18" E.C. to Wire from JB to Equipment Mounted JB

ABOVE E.C. to Wire from JB to Equipment Mounted JB

ABOVE E.C. to Wire from JB to Equipment Mounted JB

6" One Common Point of Connection — to Circuit Breaker

Unit Supplied w/ NEMA 5-15P Cord & Plug - From Item 40

Unit Supplied w/ NEMA 5-15P Cord & Plug - From Item 40

Unit Supplied w/ NEMA 5-15P Cord & Plug - From Item 40

Unit Supplied w/ NEMA 5-15P Cord & Plug - From Item 65

Montaty/Equipment Category

20.0

8.0

2.1

8.0

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8.0

20.0

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2.0

50.0

1.4

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1.5

5.5

3.0

2.4

8.8

46.0 | 12.0 |

10.7 | 2.2

8.4 1.0

4.2 0.5

1.0

0.375

12.5 | 3.0

6.3 | 1.5

0.4

0.6

19.5 | 6.9

Remote Rack Refrigeration

1 | Ice Maker

|Walk-In Cooler

|Walk-In Freezer

Walk-In Cooler

1 | Slicer, Food

Work Table

3 | Faucet, Electric

1 | Faucet, Electric

Exhaust Hood

Tilt Skillet

Work Table

1 |Heat Lamp

1 Exhaust Hood

1 | Faucet, Electric

1 |Sneeze Guard

3 | Drop-In, Hot Well

1 Drop-In, Heated Shelf

1 Refrigerator, Reach-In

1 Low Height Refrigerator

6 Heat Lamp, Decorative

1 | Warewasher w/ Booster

Disposer, Garbage

2 Drop-In, Cold Pan

2 Toaster, Conveyor

FPS | 2 | Remote Cable Pull Box

1 Cafeteria Counter 2 Drop-In, Cold Pan

4 Work Table with Sink

1 |Refrigerator, Roll—Thru

2 Filter

1 Mixer

Evaporator Coil, Cooler

Evaporator Coil, Freezer

Evaporator Coil, Cooler

Work Table with Sinks

6 Work Table with Sinks

Utility Distribution System

Steamer, Convection

Oven—Steamer, Combination

1 Range with Convection Oven 2 Fryer, Deep Fat, Gas w/Filter

1 Oven—Steamer, Combination

1 Oven-Steamer, Combination

1 | Cabinet, Heated, Roll—Thru

1 | Cabinet, Heated, Roll—Thru

Cutter/Mixer, Vertical & Veg. Prep.


|Coffee Maker, Server - by Vendor

1 Walk-In Beverage Cooler

1 Evaporator Coil, Beverage Cooler

- E.C. TO PROVIDE POWER TO & INTERCONNECT BETWEEN EVAP COIL, TIME CONTROL & CONDENSING UNIT WHERE REQUIRED. DRAIN LINE FROM FREEZER COIL TO BE WRAPPED WITH HEAT TAPE AND INSULATED BY E.C. - E.C. TO TIE IN DOOR STRIP HEATER WHERE REQUIRED.


72" E.C. to Wire from JB to Equipment Mounted JB 48" E.C. Supply Open Conduit for Fire Protection System WALK-IN NOTES:

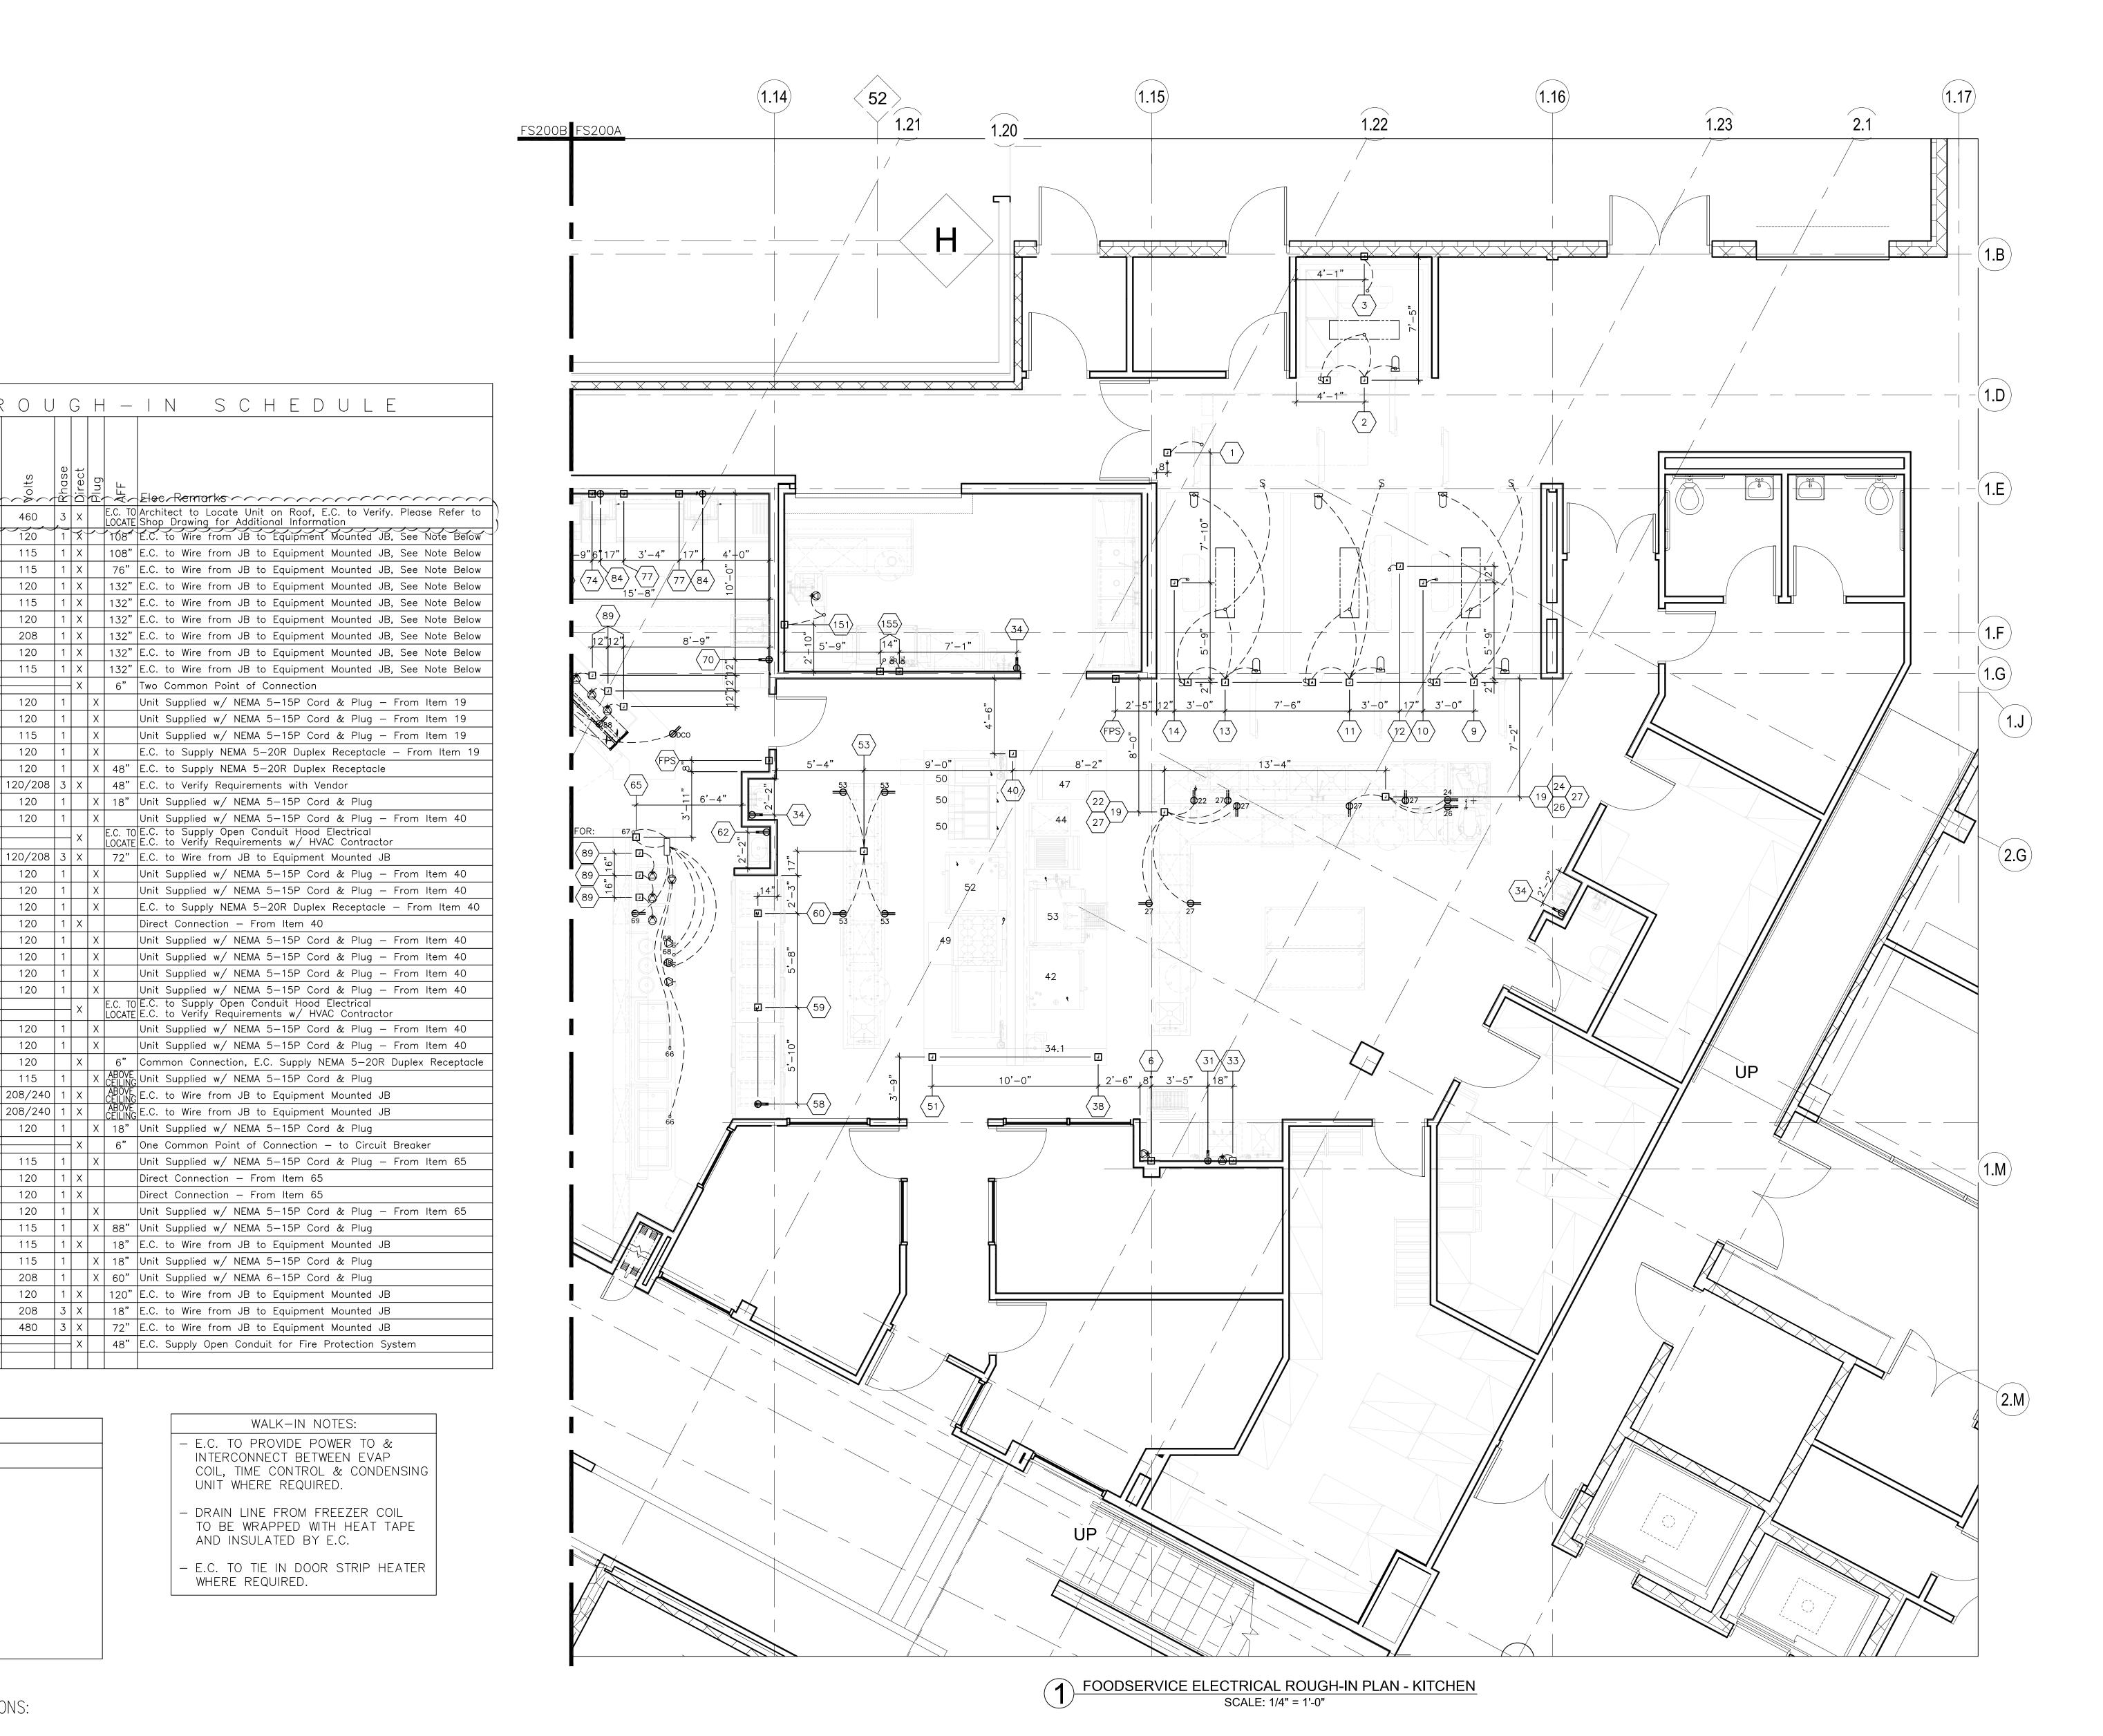

DRAWN BY: E. DERKACH

APPROVED BY P. RIVERA SUBMITTED BY P. RIVERA

SCALE: 1/4"=1'-0"

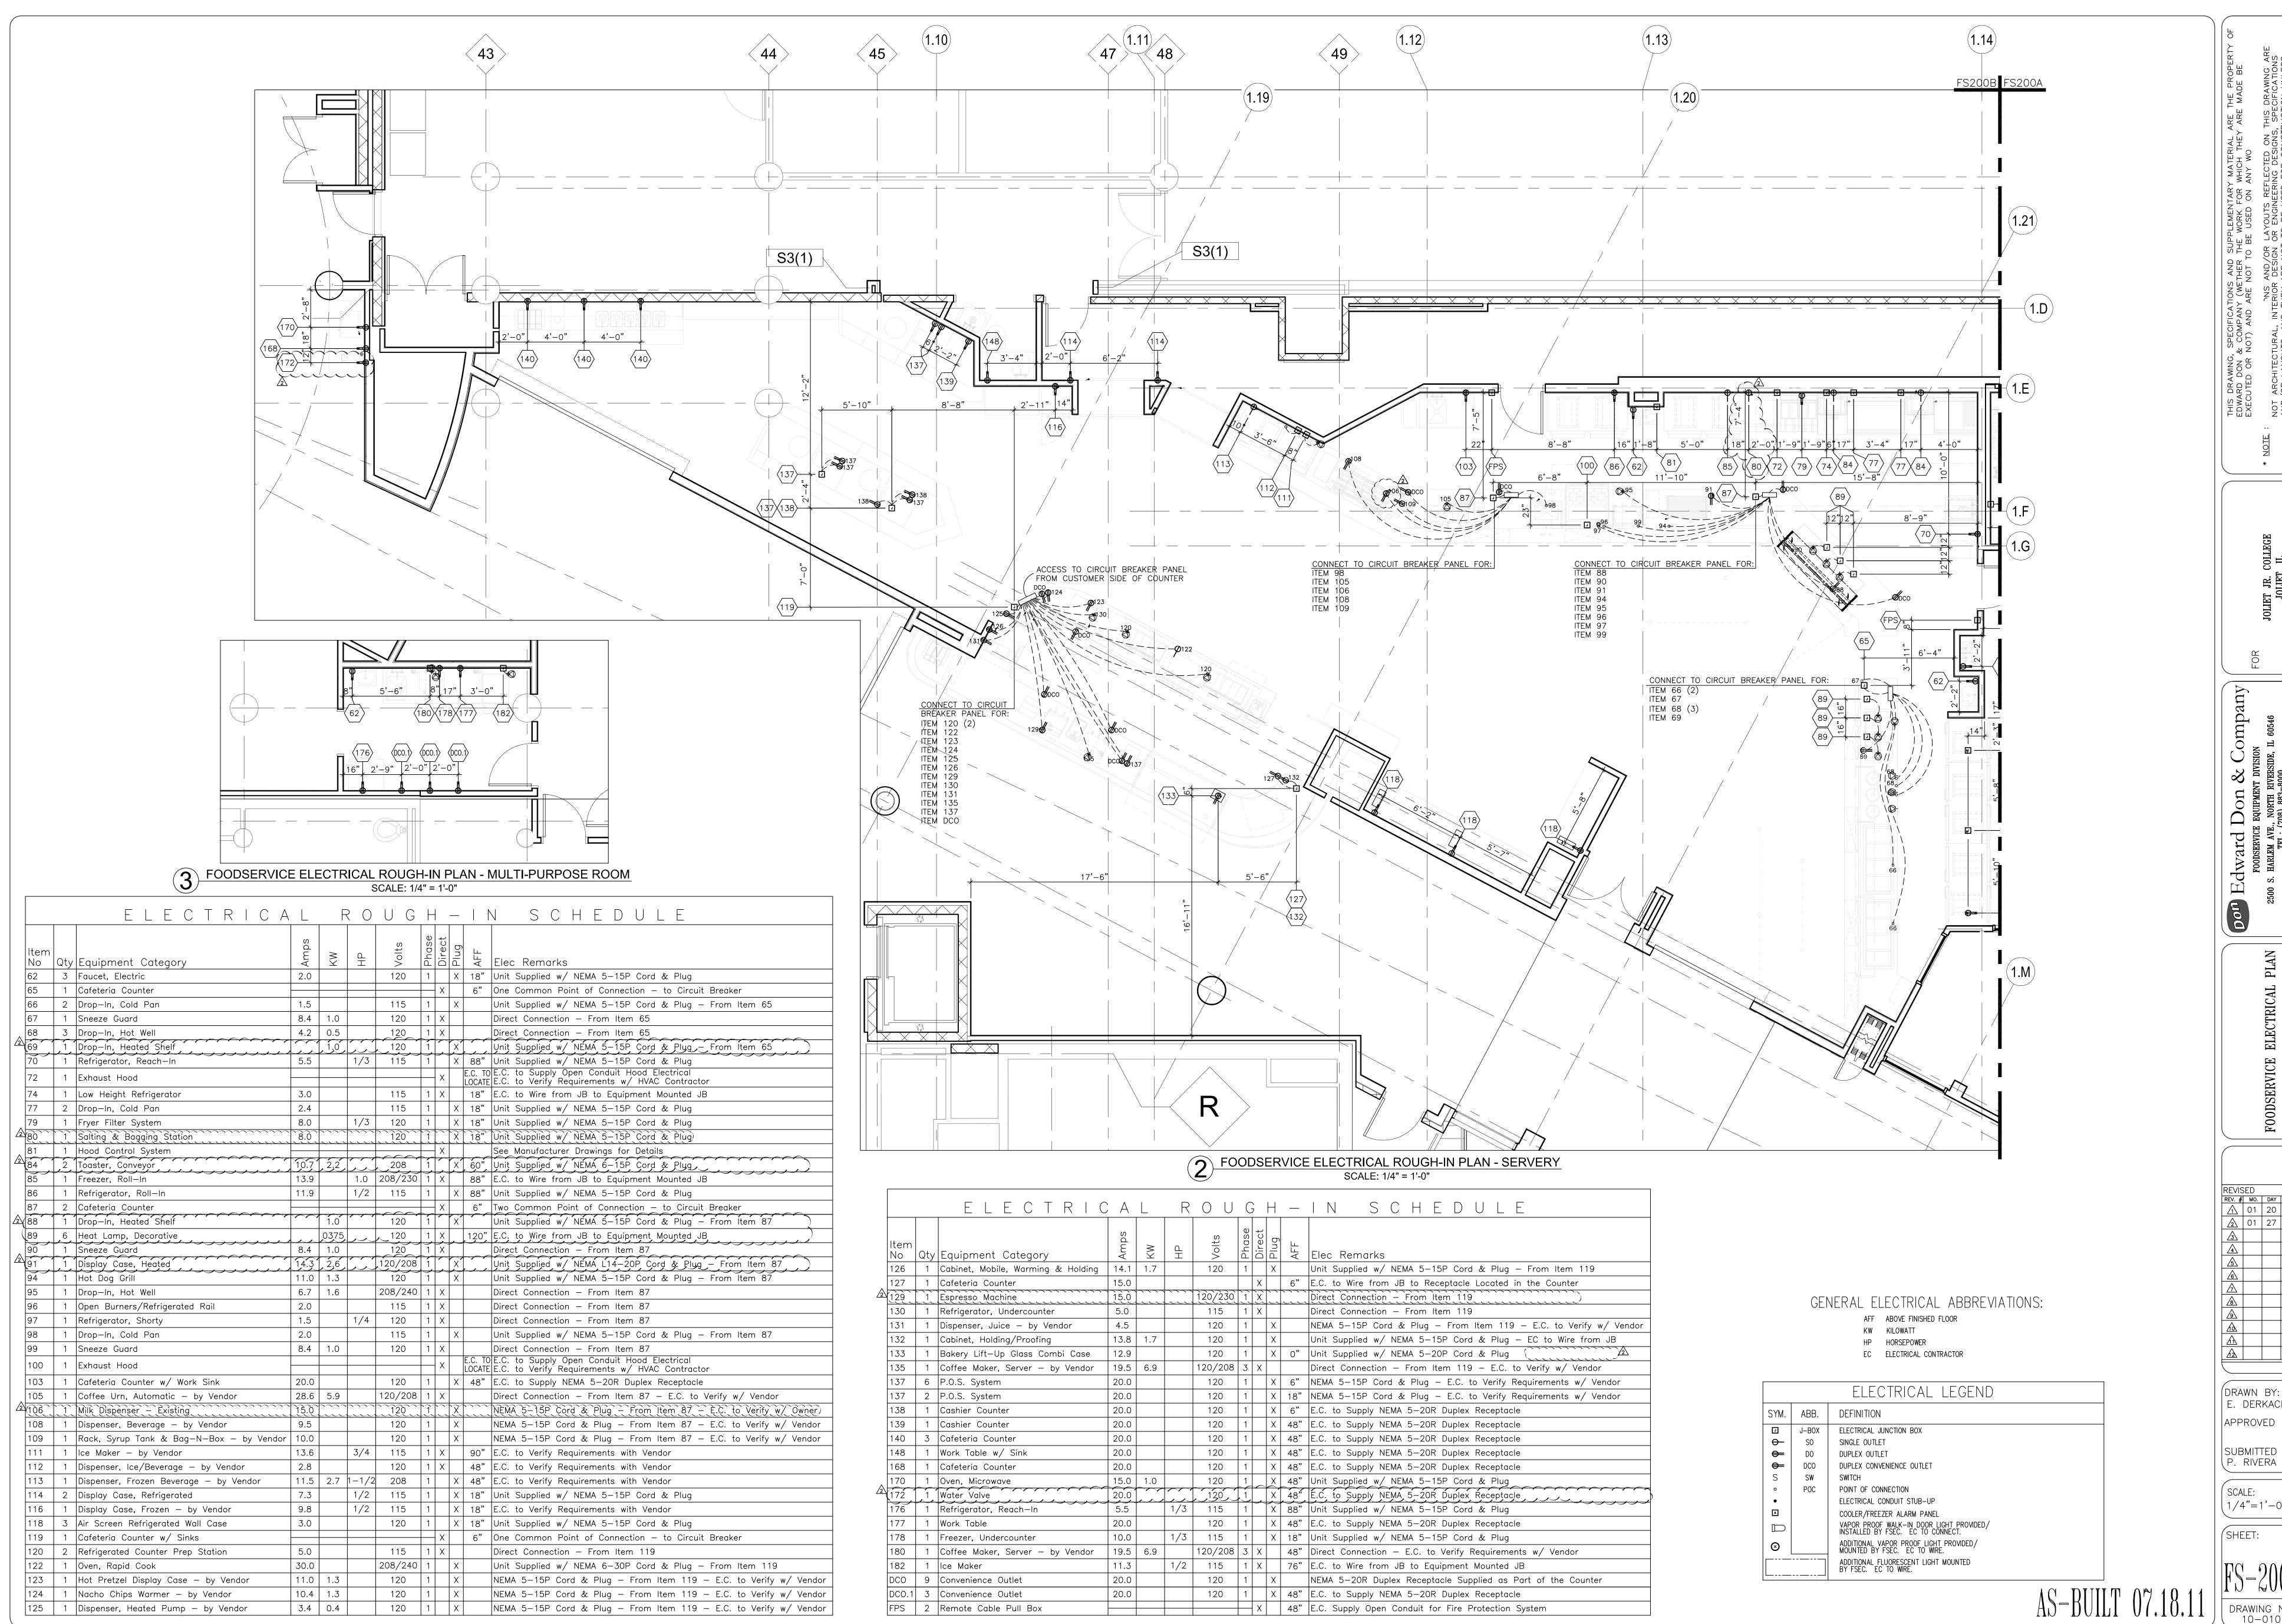

REVISED
REV. # MO. DAY YR.

DRAWN BY: E. DERKACH APPROVED BY:

SUBMITTED BY:

1/4"=1'-0"

	JIILLI.
18_RIIIT 07 18 11	FS-3
// N = K /	

5'-1" 18" 18" 18" 18" 12 12 12 12 12 12 12 1
71 to 3'-2" 3'-10" 5'-11" 43" 151) 1.F)
1.G
13", 2'-9" 16", 8'-0", 8", 19", FS, 4'-3", 8", in
50 6 47 50 6 47 6 50 6 47 6 50 6 6 6 6 6 6 6 6 6 6 6 6 6 6 6 6 6
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43
UP
66 FD-3 40 A 8 4 10" A 8
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UP TO THE RESIDENCE OF THE PARTY OF THE PART
FOODSERVICE PLUMBING ROUGH-IN PLAN - KITCHEN SCALE: 1/4" = 1'-0"

		P L U M E	3 1 1	V G	i f		U (G H	_	IN SCHED) U L E
Item No		Equipment Category Evaporator Coil, Beverage Cooler	Cold Water Size (in)		Direct Drain Size (in)	Indirect Drain Size (in)	Gas Size (in)	_	AFF (in)	Tee Off or Run To P.C. to Run Drain to Floor Sink	Plumbing Remarks ("FD-3")P.C. to Install "P" Trap in Drain Lin
5	1	Filter System, Icemaker	3/8			'			60	F.C. to Rull Didli to Floor Sills	1 PD-3 P.C. to ilistali P Trap III Dialii Lili
6	1	Ice Maker	3/8							Tee Off Item 5 — Filter System	2.5
						3/4				P.C. to Run Drain to Floor Sink	
7	1	Bin, Ice				1				P.C. to Run Drain to Floor Sink	
8		Floor Trough			3				-4		\triangle
10	1	Evaporator Coil, Cooler				1				P.C. to Run Drain to Floor Sink	("FD-3" P.C. to Install "P" Trap in Drain Lin
12 14	1	Evaporator Coil, Freezer Evaporator Coil, Cooler				1				P.C. to Run Drain to Floor Sink P.C. to Run Drain to Floor Sink	"FD-3" P.C. to Install "P" Trap in Drain Lin
19	1	Work Table with Sinks	1/2	1/2		'			6	F.C. to Rull Drull to Floor Sills	P.C. to Manifold Two Bowl Drains
	'	WOLK TODIC WITH SHIKS	1/2	1/2		1-1/2				P.C. to Run Drain to Floor Sink	1.0. to Maimora Two Bown Brains
27	2	Work Table with Sink	1/2	1/2		<u> </u>			6		FD-3 A
						1-1/2				P.C. to Run Drain to Floor Sink	
31	1	Work Table with Sink	1/2	1/2					18		
						1-1/2				P.C. to Run Drain to Floor Sink	
32	1	Filter System, Coffee Maker	3/8							Tee Off Item 31 - Work Table	
33 34	1	Coffee Maker, Server — by Vendor	3/8	+					22	lee Off Item 32 – Filter System	P.C. to Verify Requirements w/ Vendor
<u> </u>	3	Sink, Hand, Wall Mount	1/2	1/2	1-1/2				22		
34.1	1		1/2	1/2	1 1/2				20	Tee Off Item 40 - UDS	
	<u> </u>	and, mana, man meant	1, -	'/ -	1-1/2					Run Thru Item 40 - UDS	
40	1	Utility Distribution System	1-1/4	3/4	·		2		72		
41	2	Filter System, Steamer	3/8							Tee Off Item 40 — UDS	
42	1	Oven—Steamer, Combination	3/4	3/4			3/4	240		Tee Off Item 40 — UDS	6.0" W.C. Required at Equipment
						2				P.C. to Run Drain to Floor Sink	FS-1 /A
43		Tilt Skillet	1/2	1/2			3/4	200		Tee Off Item 40 - UDS	3.5" W.C. Required at Equipment
45 46	1	Floor Trough Filter System, Steamer	3/4		3				-4	Tee Off Item 40 - UDS	
40 47	1	Steamer, Convection	1/4				3/4	220		Tee Off Item 40 - UDS	4.0" W.C. Required at Equipment
''	<u>'</u>	eteamer, convection	1/4				0/	220		Tee Off Item 40 - UDS	The met required at Equipment
			,			1-1/2				P.C. to Run Drain to Floor Sink	
48	1	Griddle, Gas					3/4	108		Tee Off Item 40 - UDS	5.0" W.C. Required at Equipment
49	1	Range with Convection Oven					3/4			Tee Off Item 40 — UDS	6.0" W.C. Required at Equipment
50	2	Fryer, Deep Fat, Gas w/Filter					<u> </u>	150 EA	\	Tee Off Item 40 - UDS	3.5" W.C. Required at Equipment
52	1	Oven—Steamer, Combination	3/4				3/4	81		Tee Off Item 40 - UDS	6.0" W.C. Required at Equipment
			3/4			2	3/4	120		P.C. to Run Drain to Floor Sink Tee Off Item 40 — UDS	6.0" W.C. Required at Equipment
			3/ +			2	3/ +	120		P.C. to Run Drain to Floor Sink	(FS-1)
53	1	 Work Table with Sink	1/2	1/2					6	The terms of the present terms	
			,	<u> </u>		1-1/2				P.C. to Run Drain to Floor Sink	(FD-3 A
55	1	Broiler, Gas					3/4	72		Tee Off Item 40 - UDS	5.0" W.C. Required at Equipment
62	1	Sink, Hand, Wall Mount	1/2	1/2					22		
					1-1/2	,			20		
66		Drop-In, Cold Pan				3/4				P.C. to Run Drain to Floor Sink	FD-3 1
68 71		Drop-In, Hot Well	1/2	1/2		1/2			18	P.C. to Run Drain to Floor Sink	(FD-3)
7 1	'	Sink, Scullery, 1 Compartment	1/2	1/2		1-1/2			10	P.C. to Run Drain to Floor Sink	+
75	1	Griddle, Gas				1 1/2	3/4	55	30	T.O. to Itali Brain to Floor Sink	4.0" W.C. Required at Equipment
77	1	Drop-In, Cold Pan				3/4	-/ -			P.C. to Run Drain to Floor Sink	(FD-3 A
78	1	Griddle, Gas					3/4	120	30		4.0" W.C. Required at Equipment
149	1	Soiled Dishtable	1/2	1/2					18		
151	1	Disposer, Garbage	1/2							Tee Off Item 149 — Dishtable	
4.5				-, ,	2				12		4.4005 11.1
155	1	Warewasher		3/4		1-1/2			18	P.C. to Run Drain to Floor Sink	140°F Hot Water Supply Required
160	1	Sink, Scullery, 3 Compartments	1/2	1/2		1-1/2			18	r.c. to kun prain to Floor Sink	Two Separate Connections Reg'd
. 50	'	onne, soundry, so compartments	1/2	'/ -		1-1/2			10	P.C. to Run Drain to Floor Sink	P.C. to Manifold Three Bowl Drains
164	1	Sink, Mop w/ Mop Hanger	1/2	1/2		†			18	2.2 33 1.1331 31111	
	<u> </u>	. , , ,		† ´ ¯	2		1		7	1	1

PLUMBING LEGEND

FS 8" X 8" X 6" DEEP FLUSH MOUNTED FLOOR SINK WITH 3/4 GRATE BY PC. SINK TO BE S/S OR HIGH TEMP TEMPERATURE LISTED PVC MATERIAL.

SYM. ABB. DEFINITION

● CW COLD WATER

● HW HOT WATER

O DW DIRECT WASTE ○ HD HUB DRAIN

SL PVC SLEEVE OR CONDUIT

 POC POINT OF CONNECTION © SS STEAM SUPPLY

© CR CONDENSATE RETURN

AFF ABOVE FINISHED FLOOR

PC PLUMBING CONTRACTOR

MBTUH THOUSAND BRITISH THERMAL UNITS PER HOUR

G GAS


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Company

DRAWN BY: E. DERKACH

APPROVED BY: P. RIVERA SUBMITTED BY: P. RIVERA

SCALE: 1/4"=1'-0" SHEET:

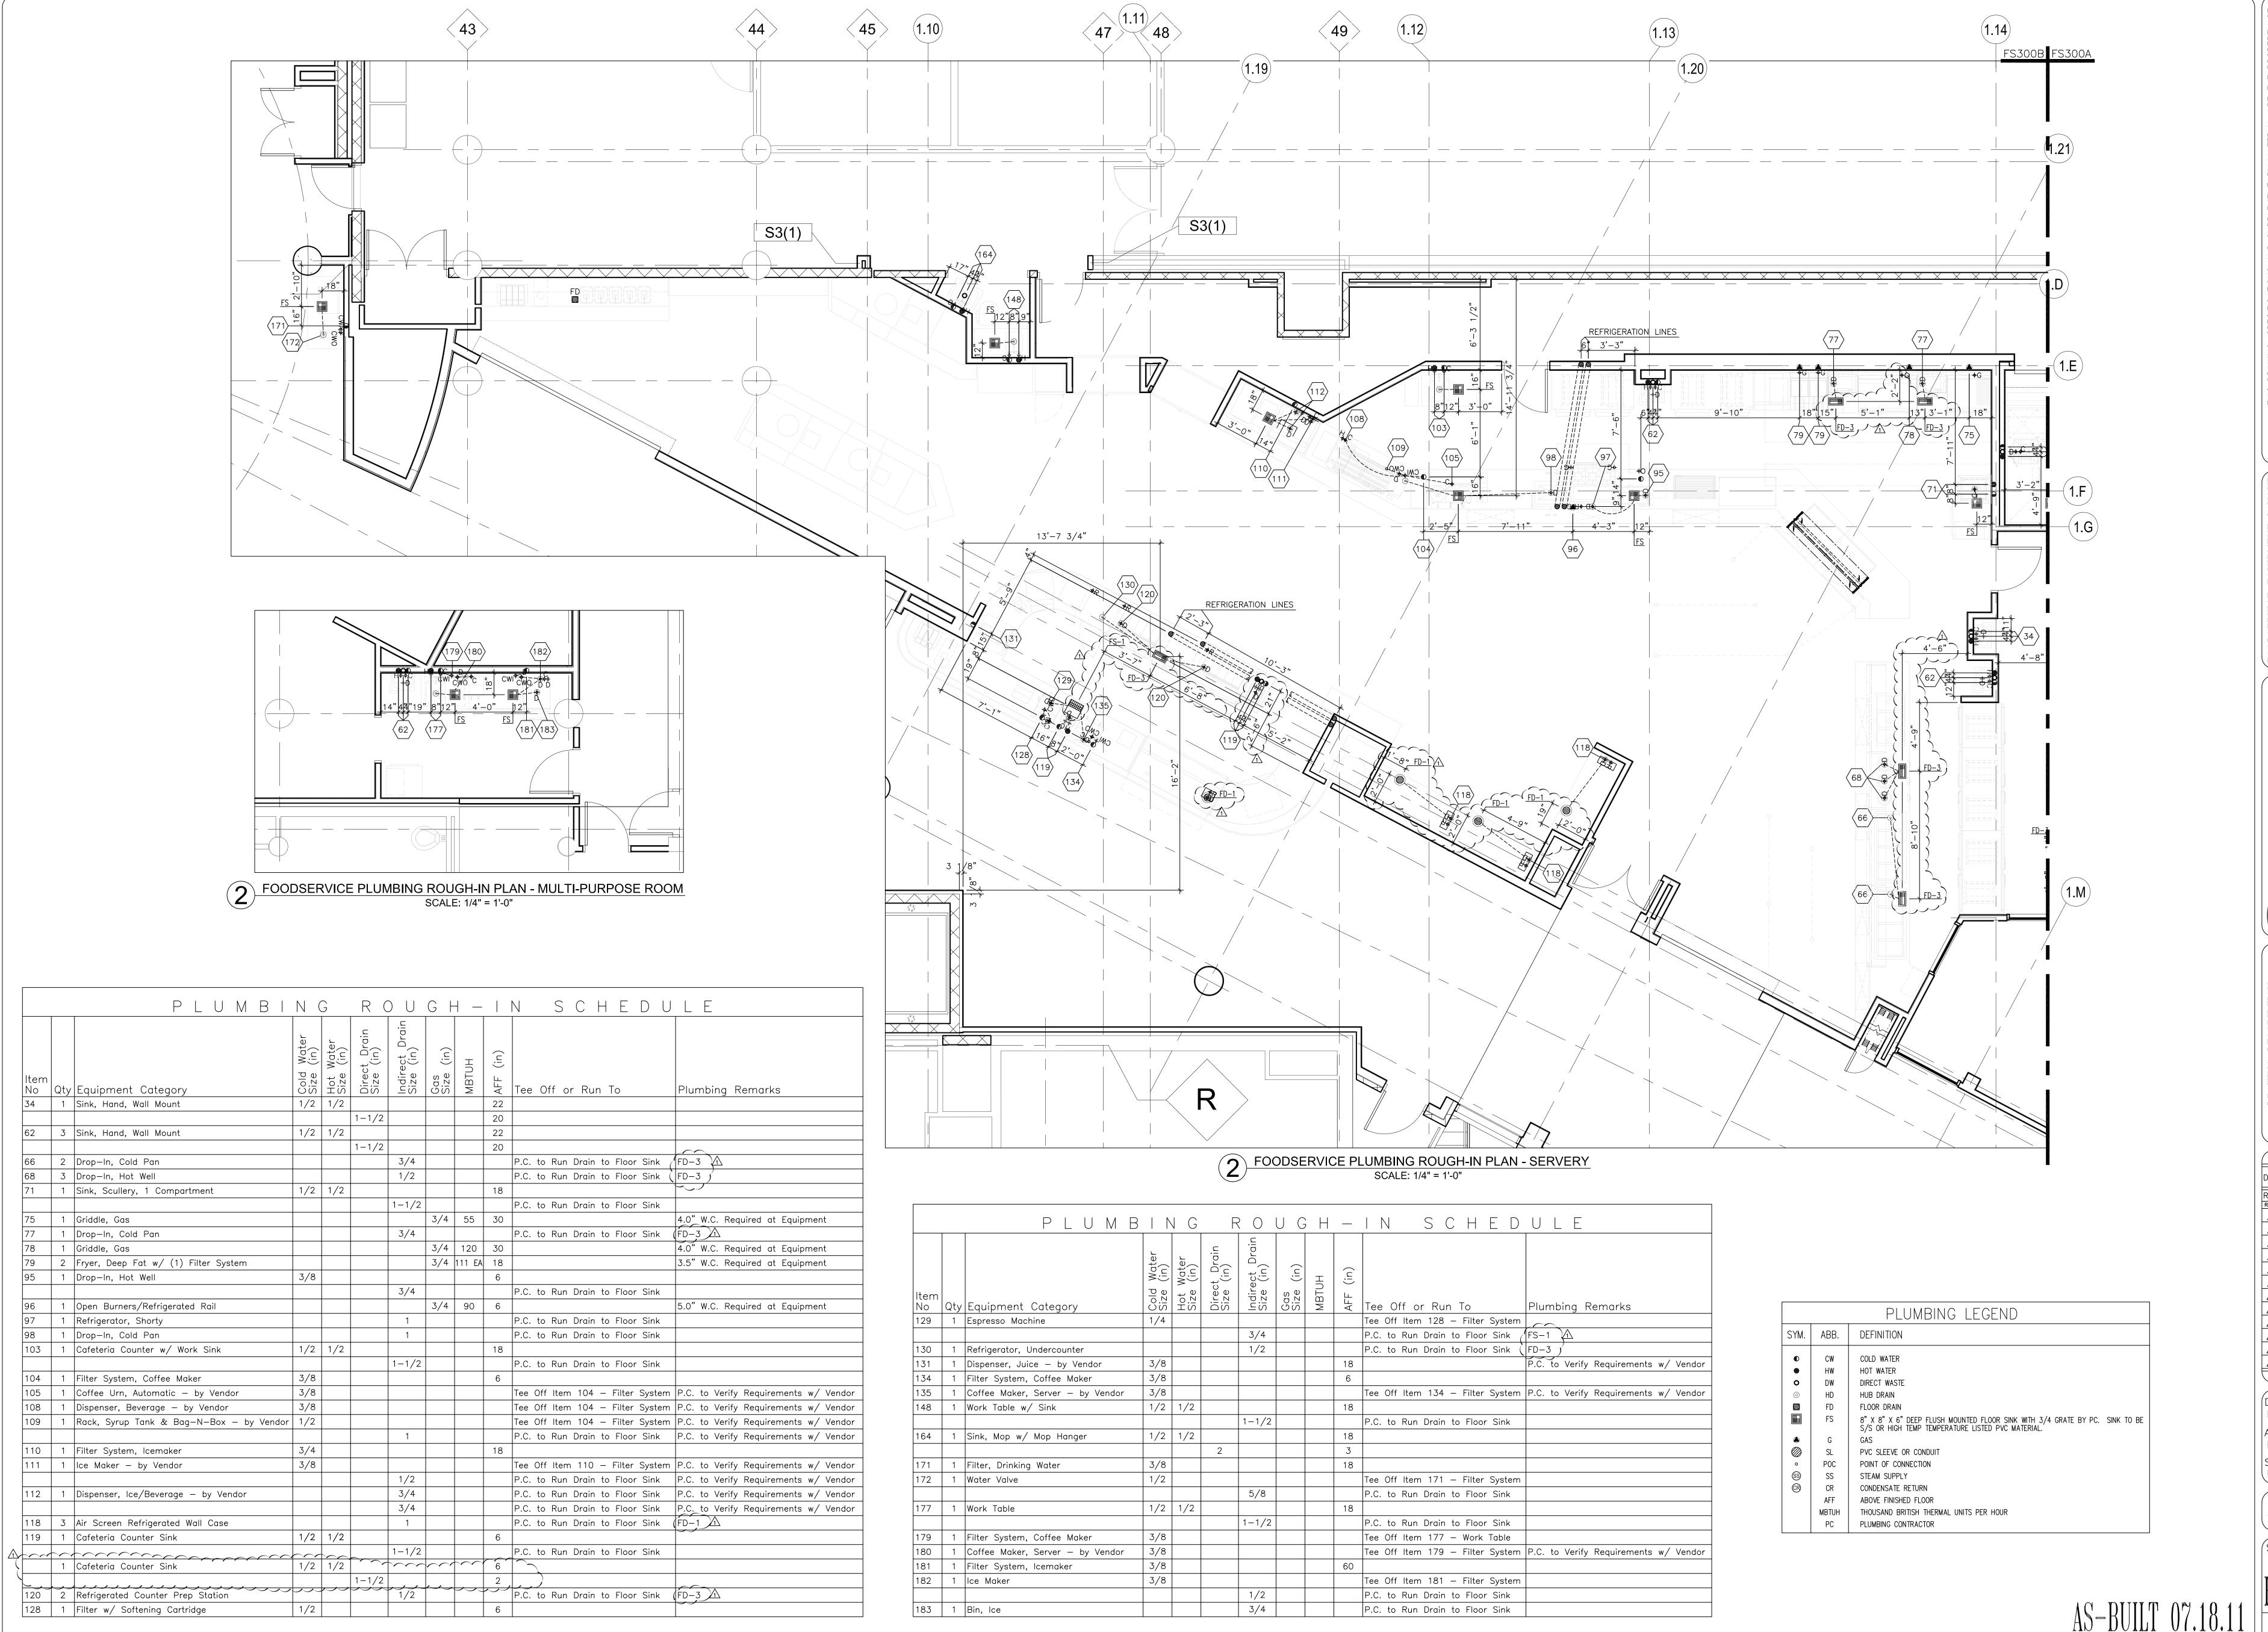

DATE O1

REV. # MO.

A 01

Company

DRAWN BY:
E. DERKACH
APPROVED BY:
P. RIVERA
SUBMITTED BY:
P. RIVERA


P. RIVERA

SCALE:
1/4"=1'-0"

1/4"=1'-0 SHEET:

FS-300B

 $\frac{1}{3} = \frac{1}{3} = \frac{1}$

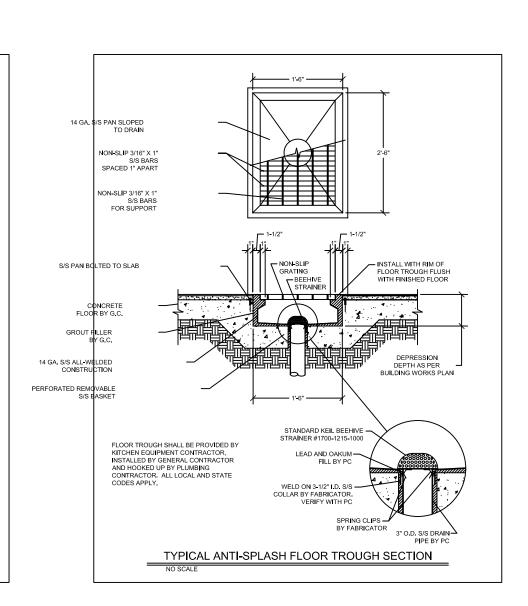

VENTILATION DATA

EXHAUST 400 CFM @ 1550 FPM THRU 4" X 6" DUCT TOTAL SQUARE AREA EQUAL 24 SQUARE INCHES. STATIC PRESSURE AT THE HOOD INCLUDING FILTERS IS WATER

DUCT 2 EXHAUST 400 CFM @ 1550 FPM THRU 4" X 6" DUCT
TOTAL SQUARE AREA EQUAL 24 SQUARE INCHES. STATIC
PRESSURE AT THE HOOD INCLUDING FILTERS IS WATER

VENTILATION CONTRACTOR TO FURNISH AND INSTALL ALL NECESSARY DUCT-WORK, TRANSITIONS, BLOWER FANS, DAMPERS, ETC.. VENTILATION CONTRACTOR TO BALANCE ABOVE CFM REQUIREMENTS WITH

WALL BACKING SCHEDULE

A = 5/8" PLYWOOD WALL BACKING, +/-30" -54" A.F.F.

B = 5/8" PLYWOOD WALL BACKING, +/-54" -90" A.F.F.

C = 5/8" PLYWOOD WALL BACKING, +/-24" -60" A.F.F.

BUILDING WORKS LEGEND


DEFINITION

SYMBOL

JOB CONDITIONS.

SUPPORT BACKING EXHAUST PLENUM COLLAR SUPPLY PLENUM COLLAR RECESSED FLOOR

OPENING IN WALL SUCTION AND LIQUID REFRIGERATION LINE RUNS

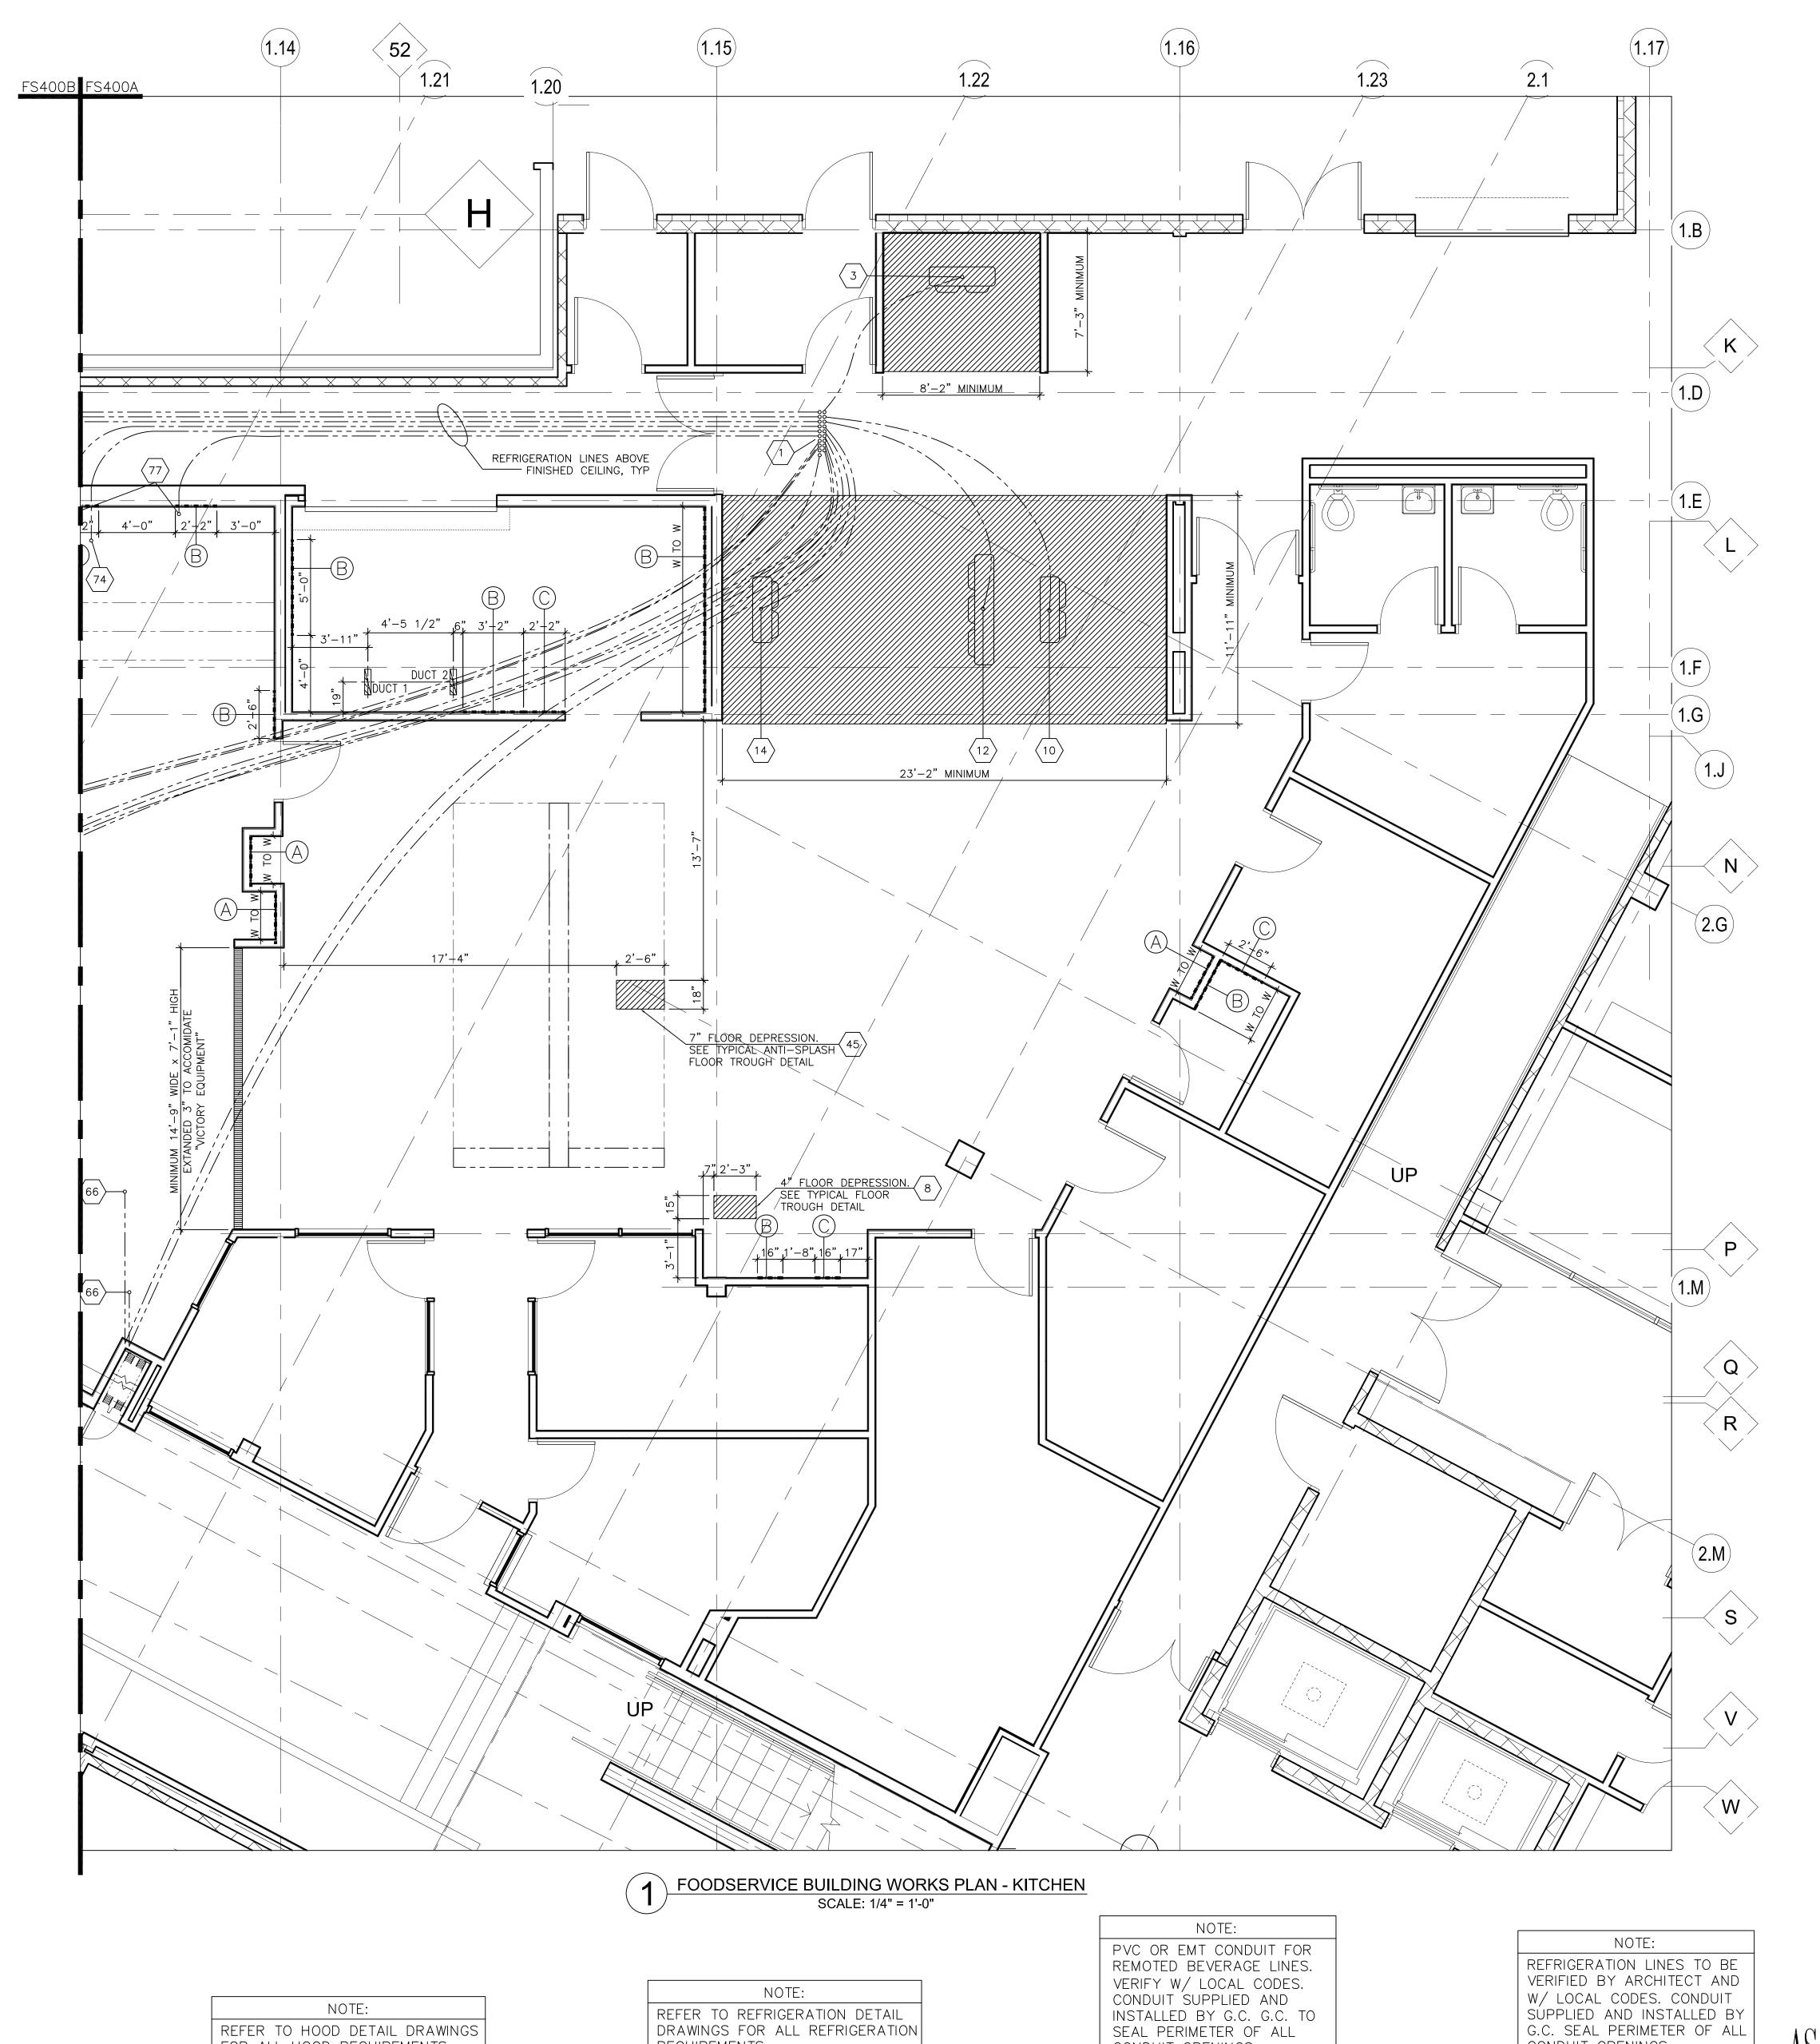

DRAWINGS FOR ALL REFRIGERATION

REQUIREMENTS.

CONDUIT OPENINGS.

REFER TO HOOD DETAIL DRAWINGS

FOR ALL HOOD REQUIREMENTS.

CONDUIT OPENINGS.

P. RIVERA SCALE: 1/4"=1'-0" SHEET:

DRAWN BY:


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APPROVED BY:

SUBMITTED BY:

P. RIVERA

DRAWING NO: 10-0101

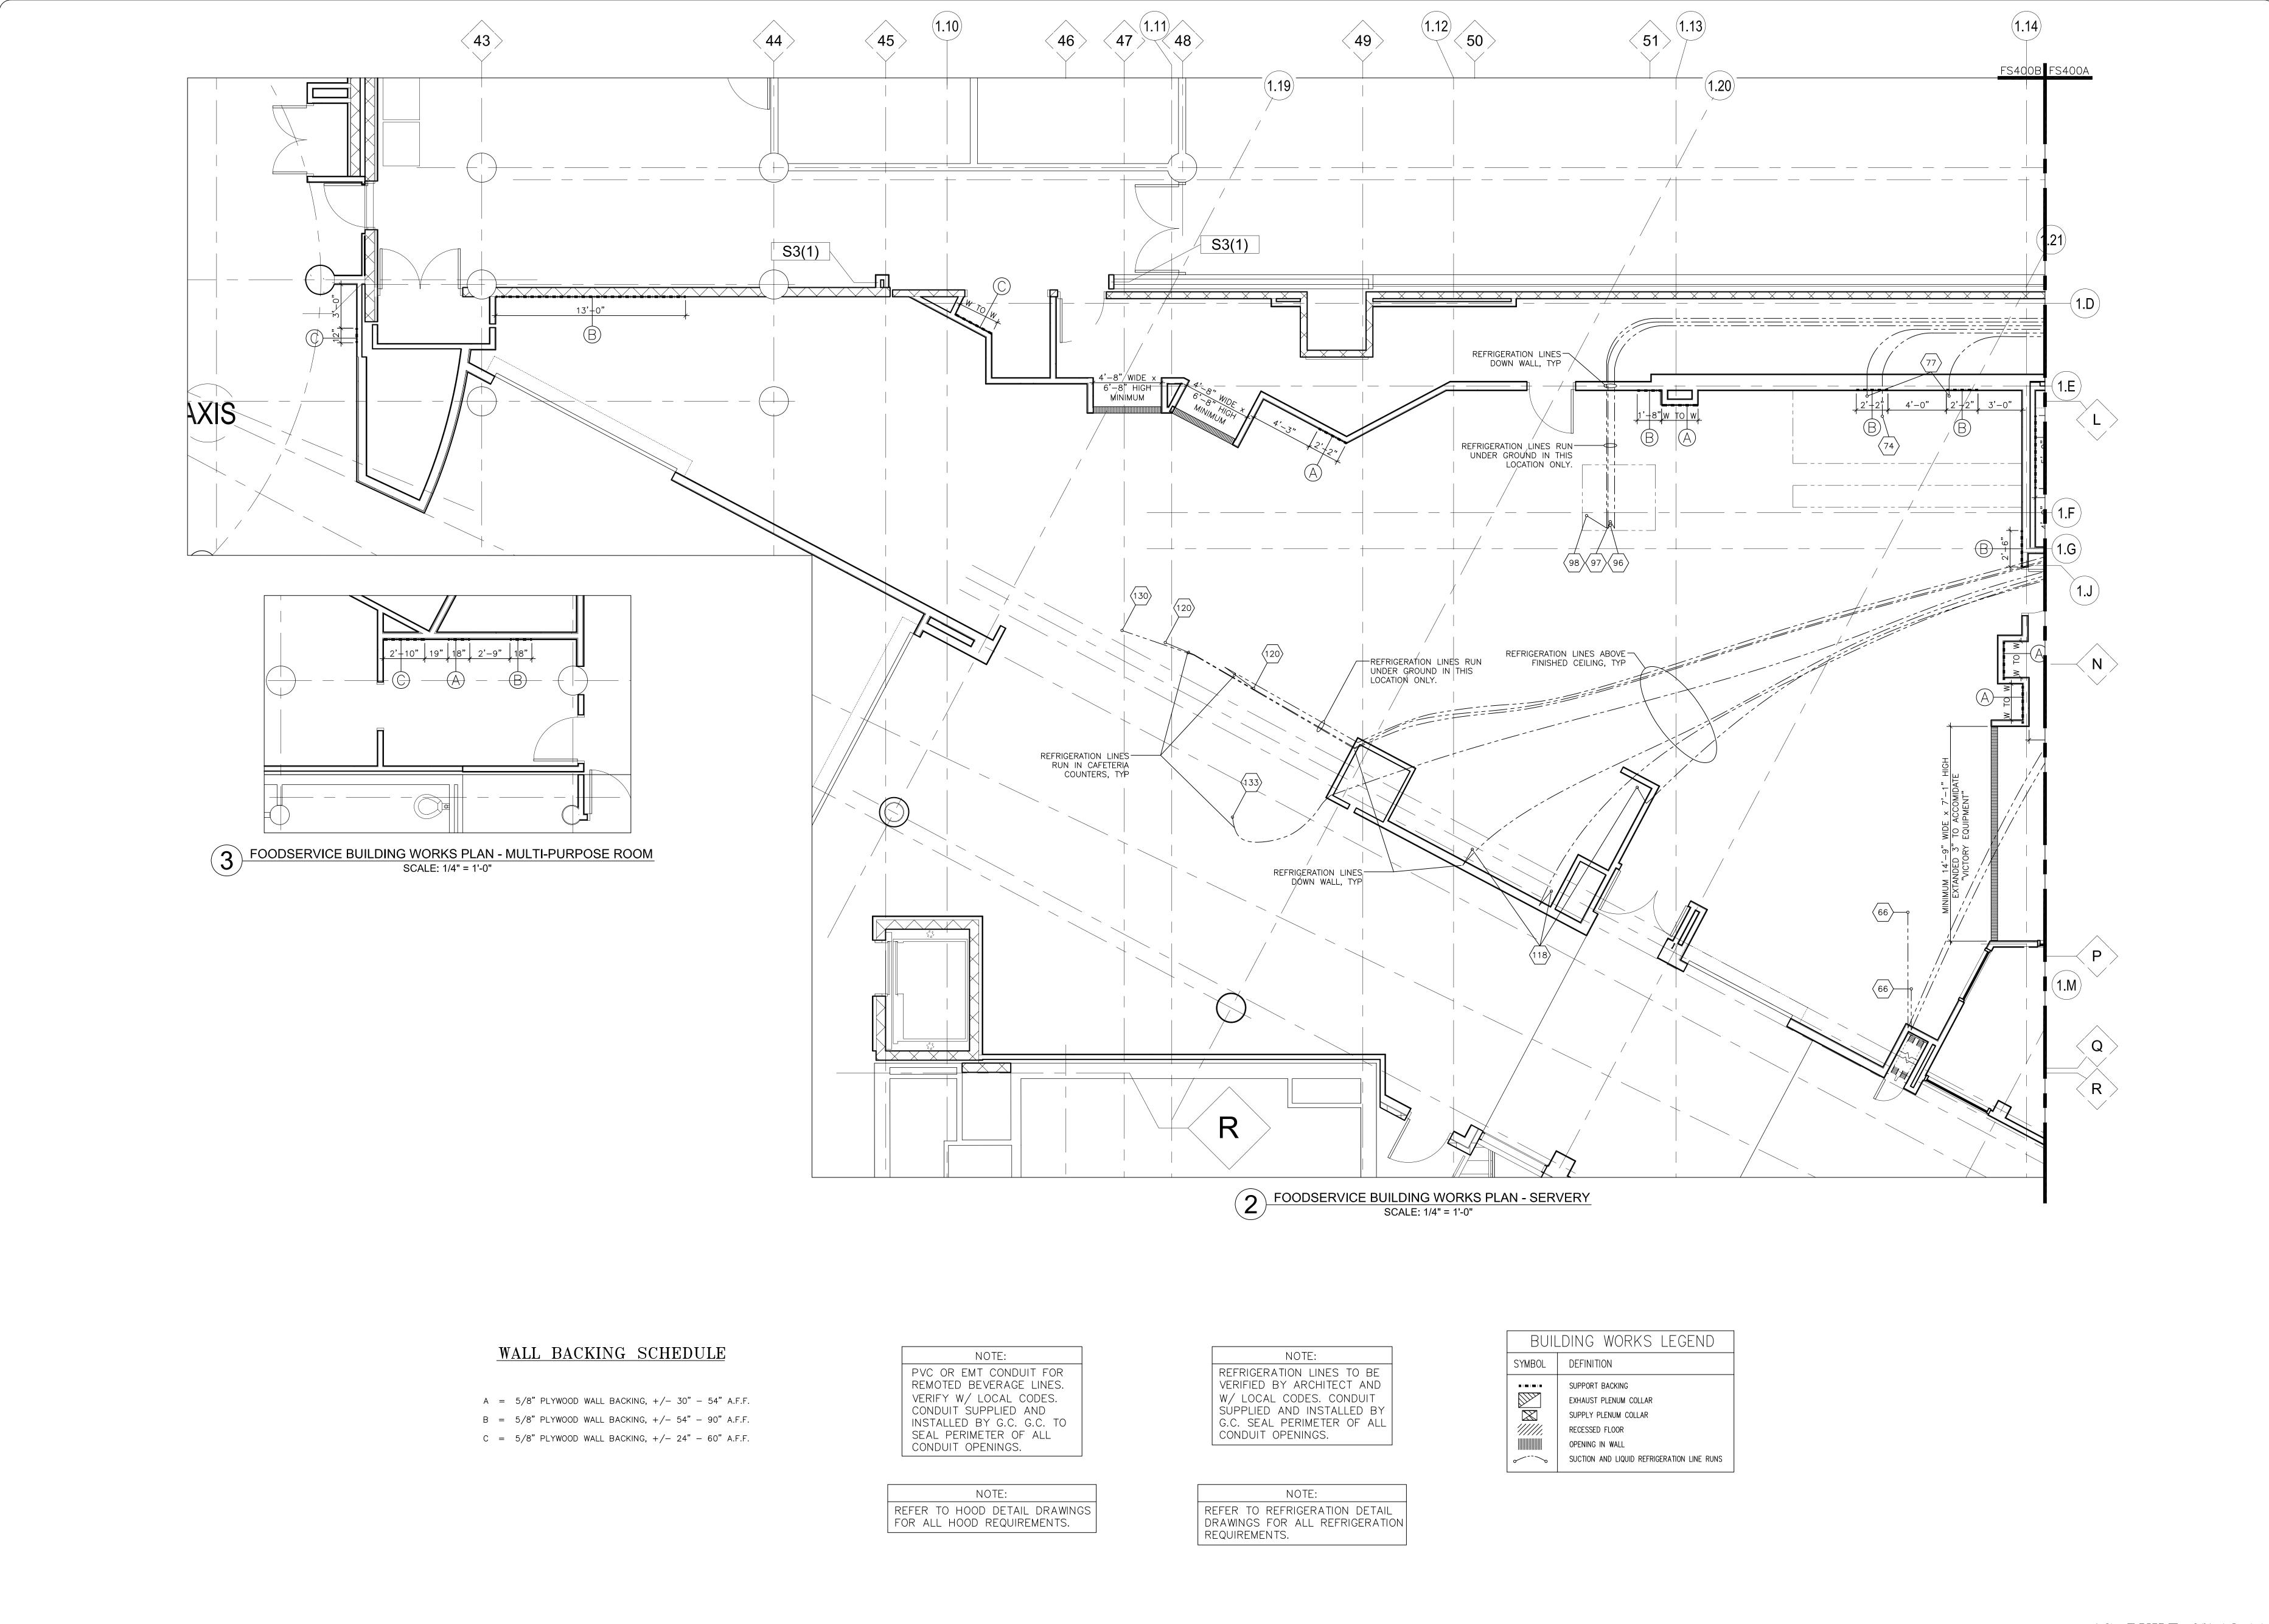

DRAWN BY:
E. DERKACH

APPROVED BY:
P. RIVERA

SUBMITTED BY:
P. RIVERA

SCALE:
1/4"=1'-0"

SHEET:

DRAWING N 10-0101

AS-BUILT 07.18.1

MELINK INTELLI-HOOD CONTROLS Call 513-965-7300 if any questions

SCOPE OF WORK TO BE COMPLETED. SPECIFYING ENGINEER OR GENERAL CONTRACTOR SHALL ASSIGN RESPONSIBILITIES.

- 1. INSTALL ALL TEMPERATURE AND OPTIC SENSORS IN THE HOODS IN ACCORDANCE WITH THE MELINK INSTALLATION PROCEDURE. SEE DETAIL 1.
- 2. INSTALL I/O PROCESSOR IN CABINET PROVIDED BY THE HOOD OEM OR IN ANOTHER LOCATION APPROVED BY MELINK. THE CABLE DISTANCE FROM THE I/O PROCESSOR TO ANY HOOD SHALL BE LESS THAN 200 FEET. SEE DETAILS 1, 2, 3.
- 3. INSTALL KEYPAD. THE CABLE DISTANCE FROM THE PROCESSOR TO THE KEYPAD SHALL BE LESS THAN 50 FEET. PULL AND CONNECT CABLE FROM KEYPAD TO I/O PROCESSOR. SEE DETAILS 1, 2,
- 4. INSTALL THE VFDS IN THE CABINET WITH THE I/O PROCESSOR OR IN ANOTHER DESIGNATED LOCATION. THE WIRING FROM THE VFD TO THE MOTOR SHALL BE LESS THAN 65 FT FOR 460V MOTORS AND LESS THAN 200 FT FOR 230V MOTORS. SEE DETAIL 3.
- 5. PULL AND CONNECT COMMUNICATION CABLE FROM I/O PROCESSOR TO VFDS. SEE DETAILS 2, 3.
- 6. CONNECT CABLES TO THE SENSORS AND PULL CABLES TO THE I/O PROCESSOR. THIS MUST BE DONE WHILE THE TOP OF THE HOOD IS ACCESSBILE, BEFORE CEILING SUPPORTS, PIPING, DUCTWORK, OR OTHER OBSTRUCTIONS BLOCK ACCESS TO THE TOP OF THE HOOD. SEE DETAILS 1, 2, 3.
- 7. INSTALL LOW VOLTAGE WIRING FROM I/O PROCESSOR TO MUA UNIT. SEE DETAIL 7.
- 8. NOT USED.
- 9. WIRE THE I/O PROCESSOR WITH AN INPUT OF 115V FROM A DEDICATED CIRCUIT. THIS CIRCUIT MUST LOSE POWER WHEN THE FIRE SUPPRESSION SYSTEM IS ACTIVATED. SEE DETAILS 4, 5.
- 10. WIRE I/O PROCESSOR LIGHTS OUTPUT TO THE HOOD LIGHTS. SEE DETAILS 4, 5.
- 11. WIRE THE VARIABLE FREQUENCY DRIVES (VFD) BY CONNECTING 3-PHASE INPUT POWER FROM THE CIRCUIT BREAKERS. THE OUTPUT WIRING FROM EACH VFD SHALL BE CONNECTED TO THE RESPECTIVE FAN MOTOR. THE OUTPUT WIRING FROM EACH VFD SHALL MUST BE RUN IN SEPARATE CONDUIT. SEE DETAILS 4, 6.
- 12. WIRE A DEDICATED 115V CIRCUIT TO THE MUA UNIT TO ENERGIZE THE MUA CONTROLS. DO NOT USE VFD OUTPUT TO ENERGIZE THIS CIRCUIT. SEE DETAIL 8.
- 13. MELINK CERTIFIED STARTUP CONTRACTOR SHALL MAKE CABLE CONNECTIONS AT THE I/O PROCESSOR AND VERIFY CONTROL WIRING, SYSTEM PROGRAMMING, VFD PROGRAMMING, AND FUNCTIONALITY PER SEQUENCE OF OPERATION.
- 14. MELINK CERTIFIED STARTUP CONTRACTOR IS NOT RESPONSIBLE FOR HIGH VOLTAGE ELECTRICAL WIRING, PROVIDING OR PULLING LOW VOLTAGE CONTROL CABLE, RUNNING OF MELINK SENSOR OR VFD CABLE LONGER THAN 50 FEET, ANY CONDUIT REQUIREMENTS, OR CEILING, FLOOR OR WALL PENETRATIONS.

APPROVALS:

THE MELINK INTELLI-HOOD OPERATOR IS UL AND CUL LISTED, AND CONFORMS WITH ALL APPLICABLE CODES AND STANDARDS INCLUDING NFPA 96, IMC, BOCA, SBCCI, ICBO, NSF, AND CE.

SEQUENCE OF OPERATION


MELINK INTELLI-HOOD CONTROLS Call 513-965-7300 if any questions

- PRESS THE LIGHTS BUTTON TO TURN ON THE HOOD LIGHTS.
- 2) PRESS THE FANS BUTTON TO TURN THE FANS ON IN THE AUTO MODE. THIS WILL ACCOMPLISH THE FOLLOWING:
 - a) I/O PROCESSOR WILL SEND A RUN COMMAND AND SPEED REFERENCE SIGNAL TO THE VARIABLE FREQUENCY DRIVES.
 - b) I/O PROCESSOR WILL SEND A 24VAC SIGNAL TO THE MUA UNIT TO ENERGIZE THE CONTROL CIRCUIT. IN THE EVENT THE MUA UNIT GOES INTO HEATING MODE, THE MUA UNIT WILL PROVIDE A DRY CLOSURE SIGNAL TO THE I/O PROCESSOR TO INCREASE THE MINIMUM AIR FLOW ACCROSS THE BURNER OR HEAT EXCHANGER.
 - c) THE INTELLI-HOOD SYSTEM WILL AUTOMATICALLY ADJUST EXHAUST AND SUPPLY AIR FLOWS BASED ON ACTUAL COOKING LOADS AS SENSED BY THE TEMPERATURE AND OPTIC SENSORS MOUNTED IN THE HOODS.
- 3) PRESS THE LIGHTS AND FANS BUTTONS AGAIN TO TURN OFF THE LIGHTS AND FANS RESPECTIVELY.
- 4) PRESS THE 100% BUTTON IN CASE OF EMERGENCY TO BYPASS THE SENSORS AND OPERATE THE FANS AT FULL SPEED FOR 10 MINUTES.
- 5) REMOVE POWER TO I/O PROCESSOR TO ACTIVATE FIRE MODE. THIS WILL ACCOMPLISH THE FOLLOWING:
 - a) I/O PROCESSOR WILL SEND A RUN COMMAND AND SPEED REFERENCE SIGNAL TO THE VARIABLE FREQUENCY DRIVES.
 - b) VARIABLE FREQUENCY DRIVES WILL OPERATE FANS AT FULL SPEED. SEE DETAIL 6.


DETAIL 1: SENSOR LOCATIONS


MELINK INTELLI-HOOD CONTROLS Call 513-965-7300 if any questions

TOP VIEW

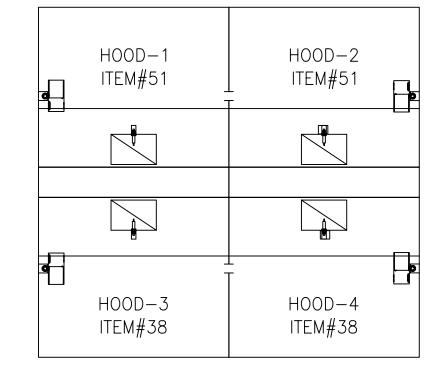



FRONT SECTION VIEW (TYP.)

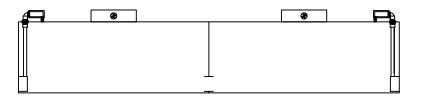


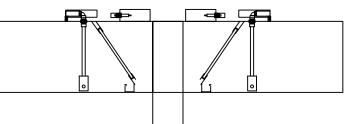

SIDE SECTION VIEW (TYP.)

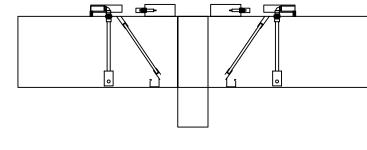

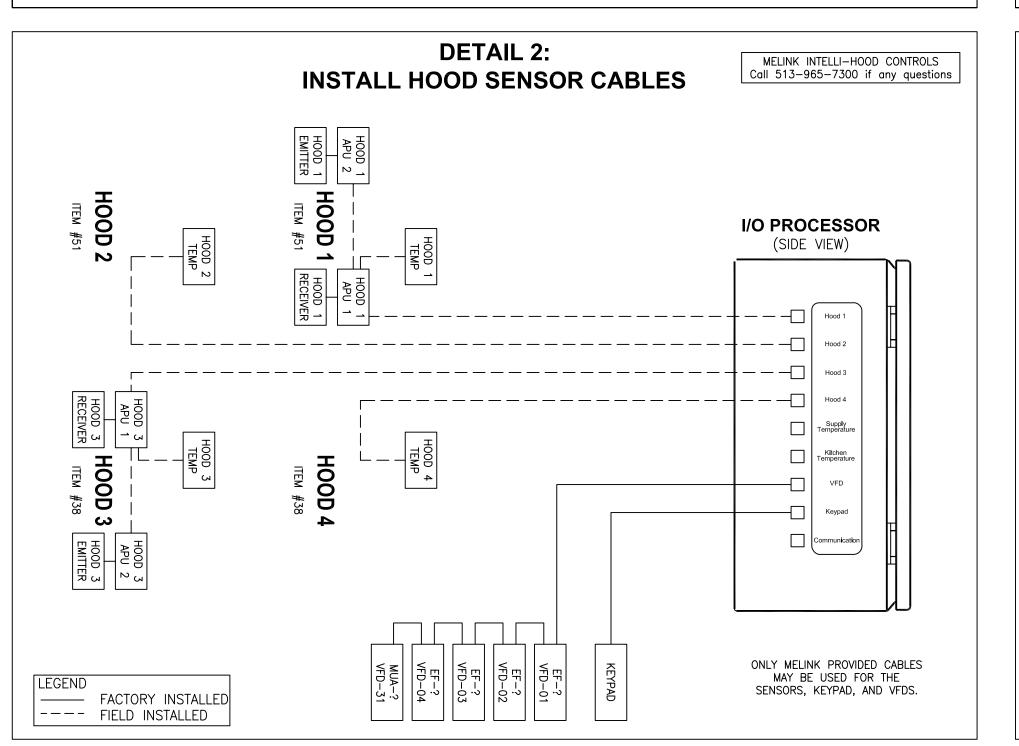

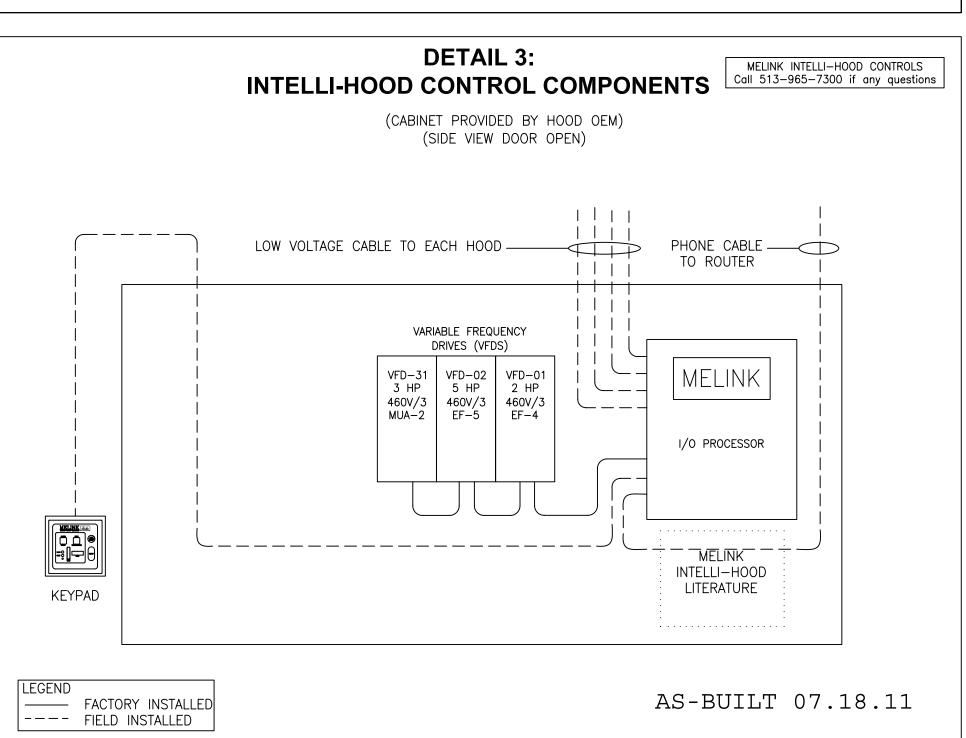


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OLLEGE 2) OF.

REVISIONS:



(IF APPLICABLE)

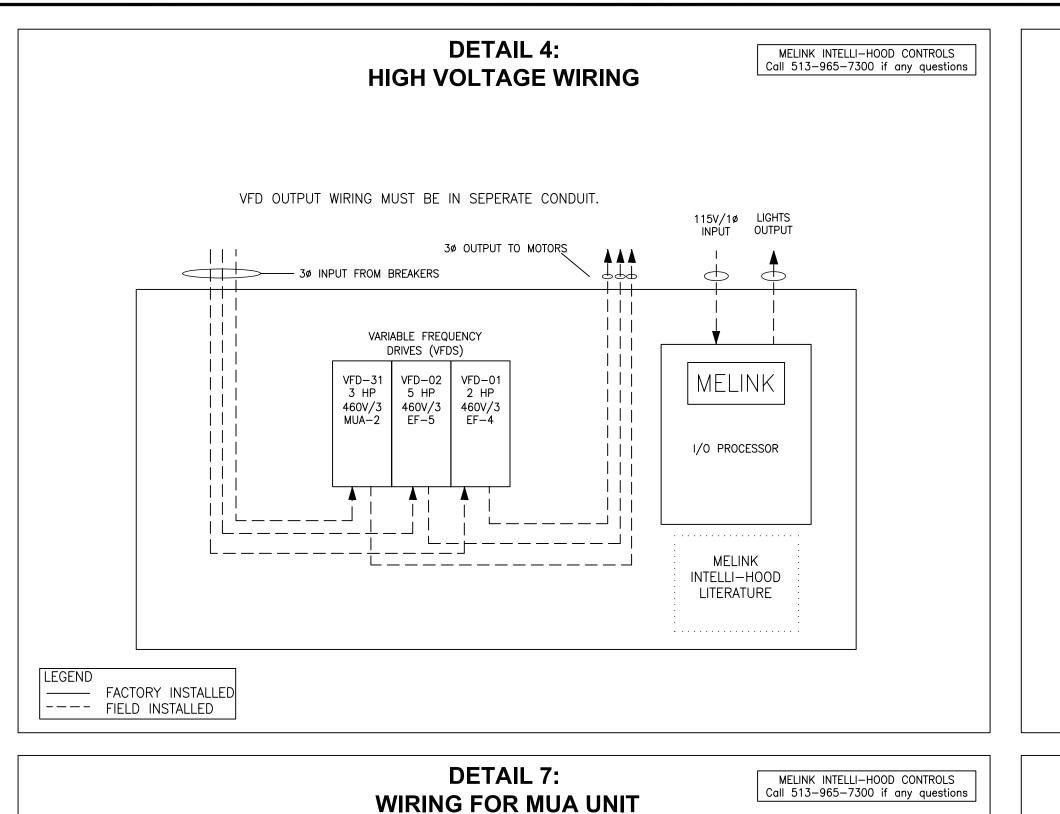AUXILIARY TERMINALS

AUXILIARY TERMINALS

TERMINALS IN THE MUA UNIT AS SHOWN.

WILL ENERGIZE THE MUA CONTROL CIRCUIT.

CONTRACTOR IF NOT PROVIDED BY MUA OEM.

(B) CONNECT DRAIN WIRE TO TERMINAL 22 IN I/O PROCESSOR.

AIRFLOW ACROSS THE BURNER OR HEAT EXCHANGER.

(E) MUA CONTROL RELAYS ARE THE RESPONSIBLITY OF THE MECHANICAL

SYSTEM 24VAC OUT12 O OUTPUT COM13 O

SHIELD 22

MUA UNIT MAKE/MODEL IF AVAILABLE

USE 18AWG SHIELDED, PLENUM-RATED CABLE (PROVIDED BY ELEC/MECH CONTRACTOR)

(A) CONNECT TERMINALS 12, 13, 32, 33 IN I/O PROCESSOR TO THE APPROPRIATE

© WHEN THE FANS ARE TURNED ON, THE I/O PROCESSOR (TERMINALS 12 AND

(D) DURING A CALL FOR HEAT, THE MUA UNIT WILL NEED A RELAY TO PROVIDE A

DRY CONTACT CLOSURE TO THE I/O PROCESSOR (TERMINALS 32 AND 33),

WHICH WILL INCREASE THE MINIMUM FAN SPEED AND MAINTAIN THE PROPER

13) WILL SEND 24VAC TO THE MUA UNIT TO ENERGIZE A RELAY. THIS RELAY

MUA TERMINALS

24VAC INPUT FOR MUA ON/OFF COMMON FOR MUA ON/OFF

MUA TERMINALS

I/O PROCESSOR


(FRONT VIEW DOOR OPEN)


MELINK Intelli-Hood [.||||||]


POWER INPUT 115/230 V

—— FACTORY INSTALLED

---- FIELD INSTALLED

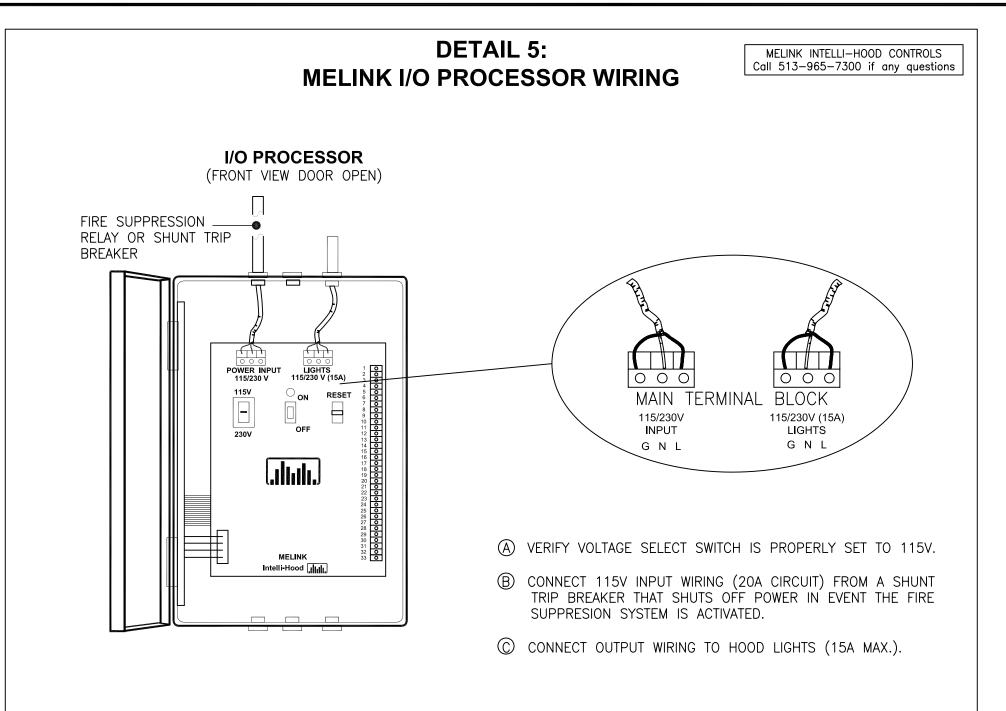


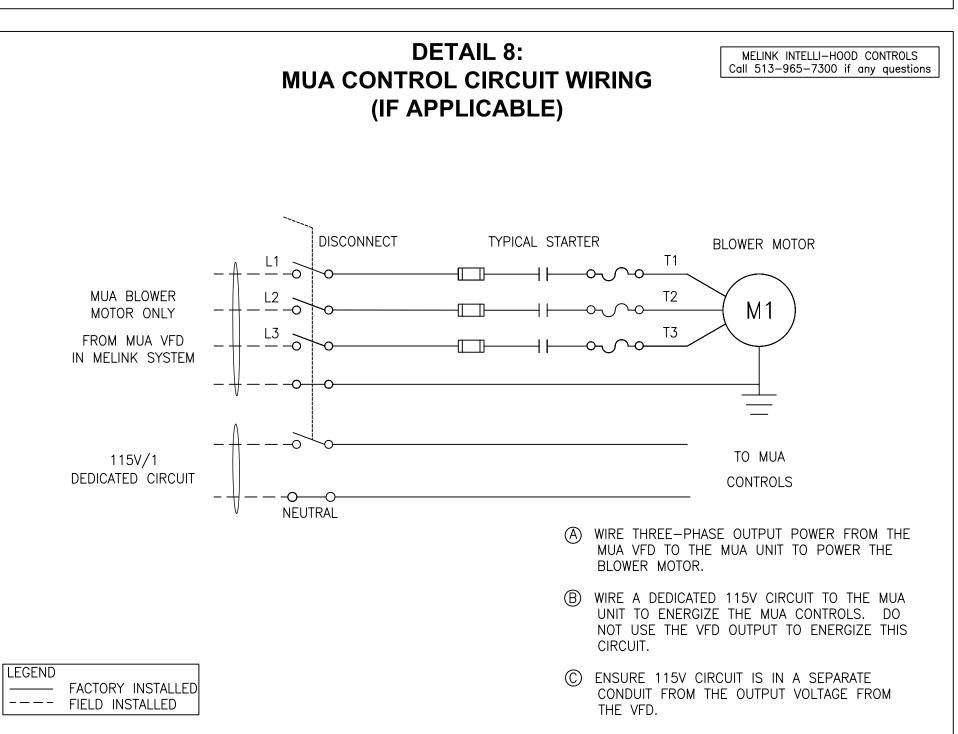


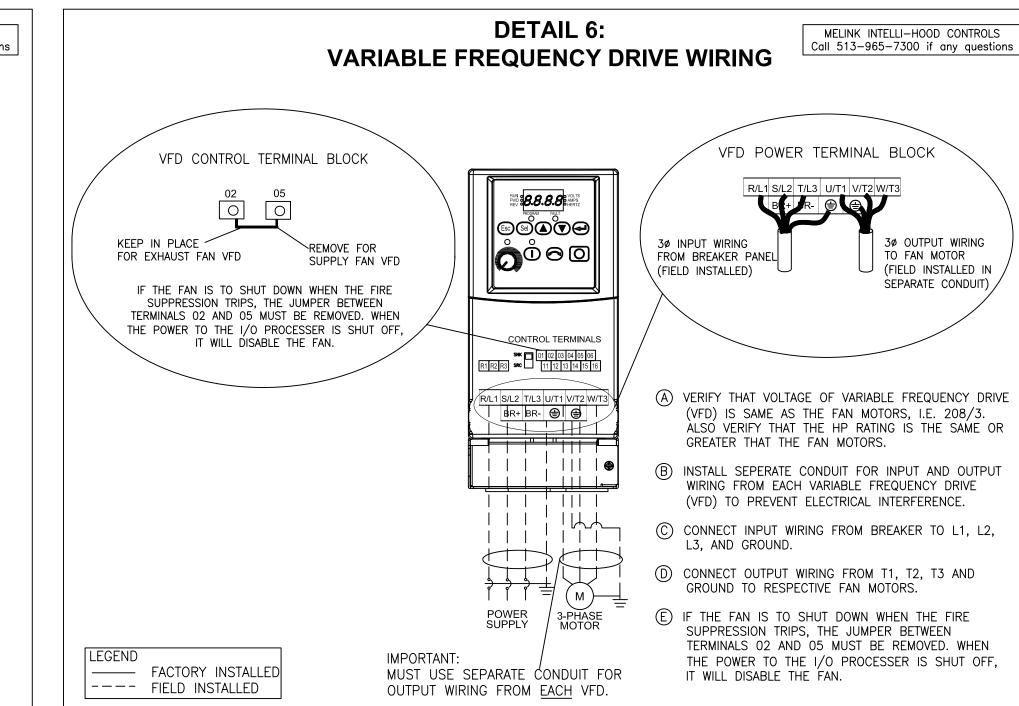

DETAIL 9:

NOT USED

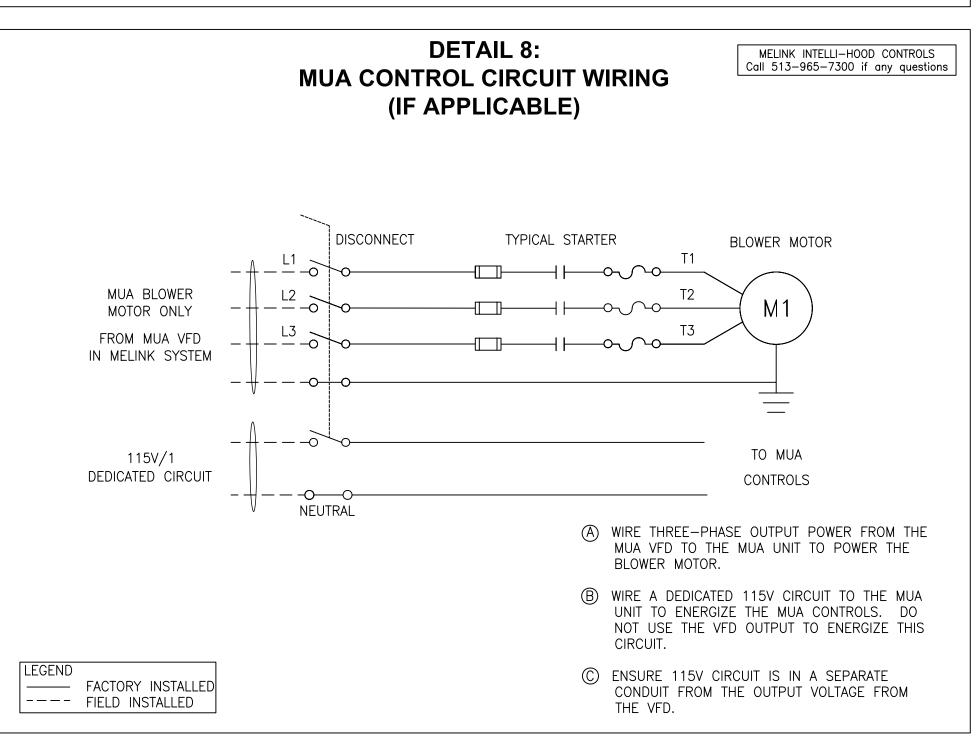

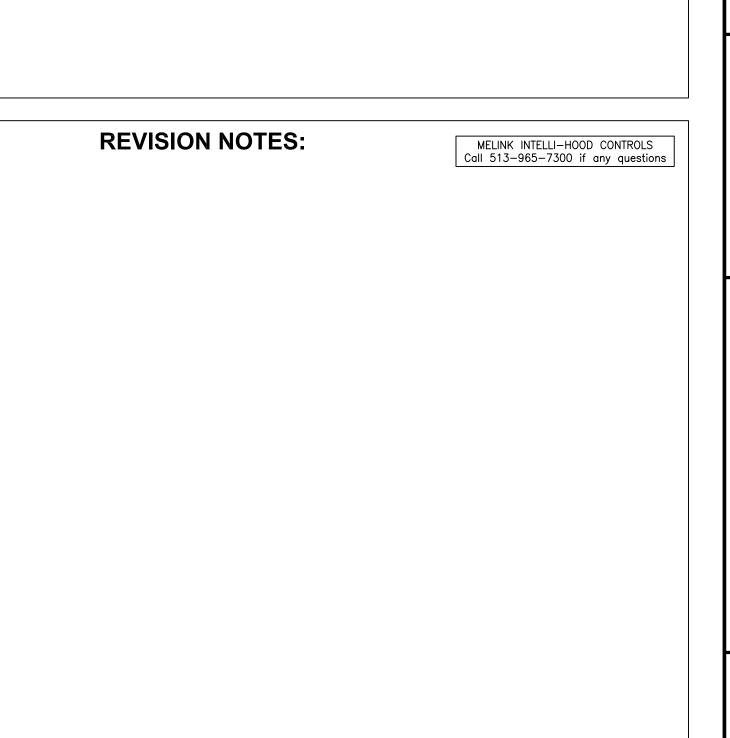

AS-BUILT 07.18.11


OLLEGE 2) IET JUNIOR JOLIET, I YSTEM 1 (1

MELINK INTELLI-HOOD CONTROLS

Call 513-527-7020 if any questions

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MELINK INTELLI-HOOD CONTROLS Call 513-965-7300 if any questions

SCOPE OF WORK TO BE COMPLETED SPECIFYING ENGINEER OR GENERAL CONTRACTOR SHALL ASSIGN RESPONSIBILITIES.

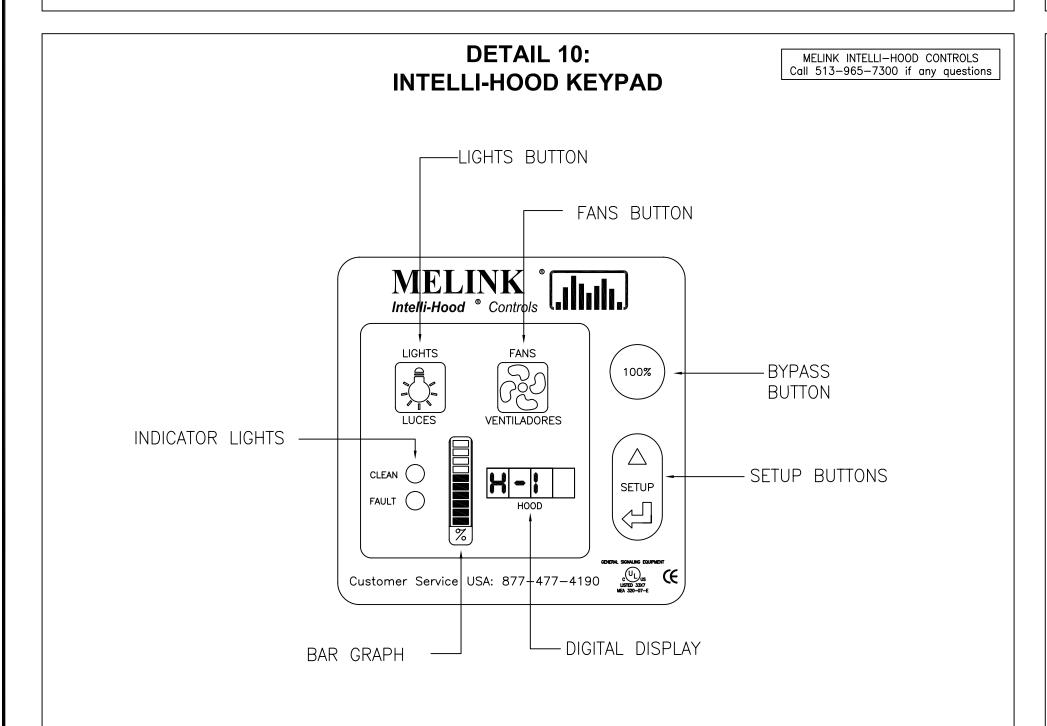- 1. INSTALL ALL TEMPERATURE AND OPTIC SENSORS IN THE HOODS IN ACCORDANCE WITH THE MELINK INSTALLATION PROCEDURE. SEE DETAIL 1.
- 2. INSTALL I/O PROCESSOR IN CABINET PROVIDED BY THE HOOD OEM OR IN ANOTHER LOCATION APPROVED BY MELINK. THE CABLE DISTANCE FROM THE I/O PROCESSOR TO ANY HOOD SHALL BE LESS THAN 200 FEET. SEE DETAILS 1, 2, 3.
- 3. INSTALL KEYPAD. THE CABLE DISTANCE FROM THE PROCESSOR TO THE KEYPAD SHALL BE LESS THAN 50 FEET. PULL AND CONNECT CABLE FROM KEYPAD TO I/O PROCESSOR. SEE DETAILS 1, 2,
- 4. INSTALL THE VFDS IN THE CABINET WITH THE I/O PROCESSOR OR IN ANOTHER DESIGNATED LOCATION. THE WIRING FROM THE VFD TO THE MOTOR SHALL BE LESS THAN 65 FT FOR 460V MOTORS AND LESS THAN 200 FT FOR 230V MOTORS. SEE DETAIL 3.
- 5. PULL AND CONNECT COMMUNICATION CABLE FROM I/O PROCESSOR TO VFDS. SEE DETAILS 2, 3.
- 6. CONNECT CABLES TO THE SENSORS AND PULL CABLES TO THE I/O PROCESSOR. THIS MUST BE DONE WHILE THE TOP OF THE HOOD IS ACCESSBILE, BEFORE CEILING SUPPORTS, PIPING, DUCTWORK, OR OTHER OBSTRUCTIONS BLOCK ACCESS TO THE TOP OF THE HOOD. SEE DETAILS 1, 2, 3.
- 7. INSTALL LOW VOLTAGE WIRING FROM I/O PROCESSOR TO MUA UNIT. SEE DETAIL 7.
- 8. NOT USED
- 9. WIRE THE I/O PROCESSOR WITH AN INPUT OF 115V FROM A DEDICATED CIRCUIT. THIS CIRCUIT MUST LOSE POWER WHEN THE FIRE SUPPRESSION SYSTEM IS ACTIVATED. SEE DETAILS 4, 5.
- 10. WIRE I/O PROCESSOR LIGHTS OUTPUT TO THE HOOD LIGHTS. SEE DETAILS 4, 5.
- 11. WIRE THE VARIABLE FREQUENCY DRIVES (VFD) BY CONNECTING 3-PHASE INPUT POWER FROM THE CIRCUIT BREAKERS. THE OUTPUT WIRING FROM EACH VFD SHALL BE CONNECTED TO THE RESPECTIVE FAN MOTOR. THE OUTPUT WIRING FROM EACH VFD SHALL MUST BE RUN IN SEPARATE CONDUIT. SEE DETAILS 4, 6.
- 12. WIRE A DEDICATED 115V CIRCUIT TO THE MUA UNIT TO ENERGIZE THE MUA CONTROLS. DO NOT USE VFD OUTPUT TO ENERGIZE THIS CIRCUIT. SEE DETAIL 8.
- 13. MELINK CERTIFIED STARTUP CONTRACTOR SHALL MAKE CABLE CONNECTIONS AT THE I/O PROCESSOR AND VERIFY CONTROL WIRING, SYSTEM PROGRAMMING, VFD PROGRAMMING, AND FUNCTIONALITY PER SEQUENCE OF OPERATION.
- 14. MELINK CERTIFIED STARTUP CONTRACTOR IS NOT RESPONSIBLE FOR HIGH VOLTAGE ELECTRICAL WIRING, PROVIDING OR PULLING LOW VOLTAGE CONTROL CABLE, RUNNING OF MELINK SENSOR OR VFD CABLE LONGER THAN 50 FEET, ANY CONDUIT REQUIREMENTS, OR CEILING, FLOOR OR WALL PENETRATIONS.

APPROVALS:

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SEQUENCE OF OPERATION


MELINK INTELLI-HOOD CONTROLS Call 513-965-7300 if any questions


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DETAIL 1: SENSOR LOCATIONS

MELINK INTELLI-HOOD CONTROLS Call 513-965-7300 if any questions


TOP VIEW




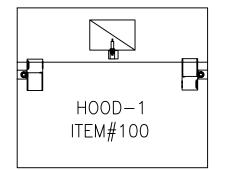

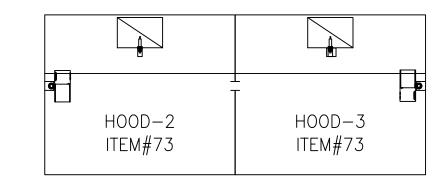
FRONT SECTION VIEW




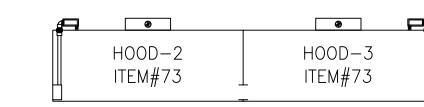


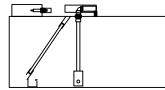

SIDE SECTION VIEW (TYP.)

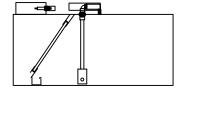

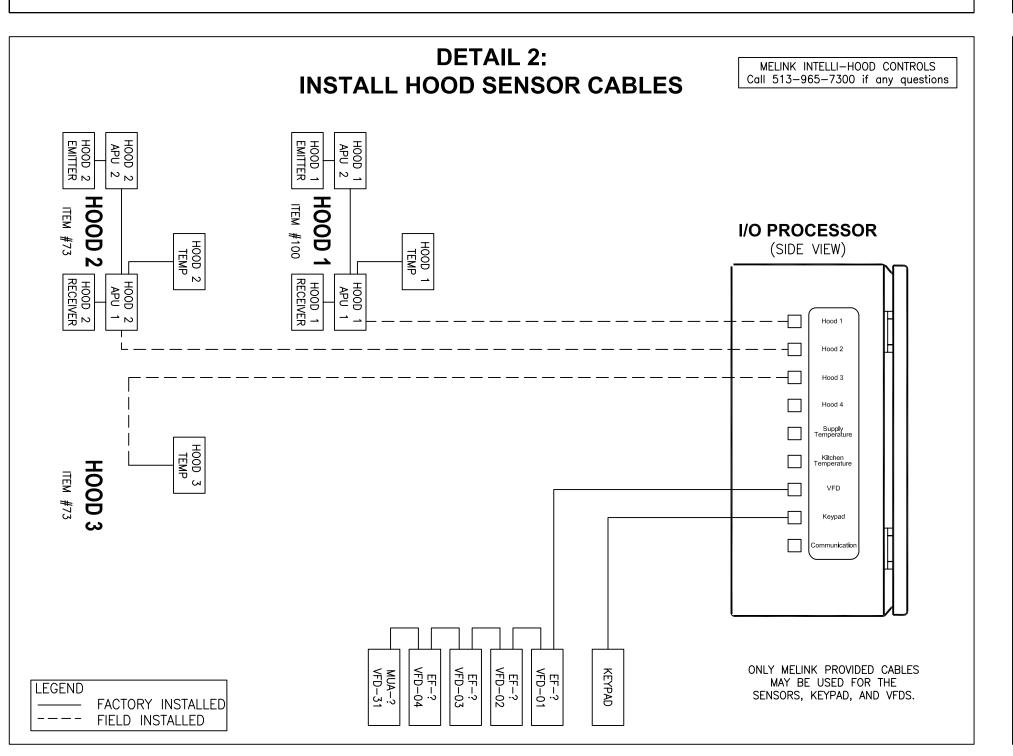

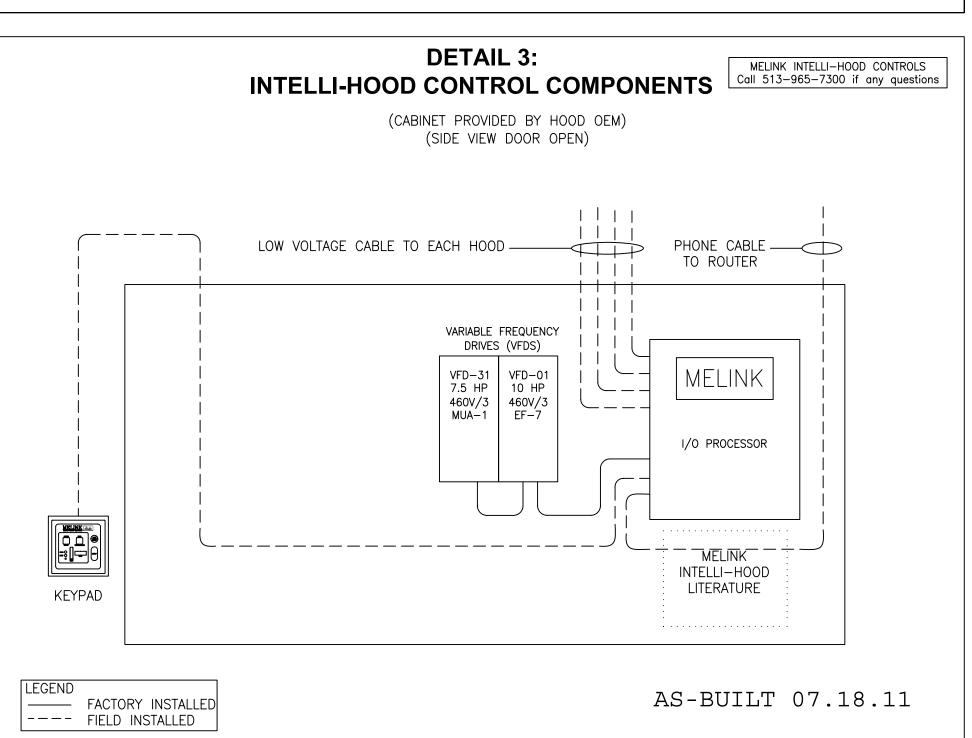



5140 RIVER VALLEY ROAD MILFORD, OH 45150 PHONE: (513) 965-7300 FAX: (513) 965-7353 www.melinkcorp.com intellihood@melinkcorp.com





OLLEGE 2) OF. OLIET JUNIOR JOLIET, I SYSTEM 2 (2


REVISIONS: MARK REV1 REV-2

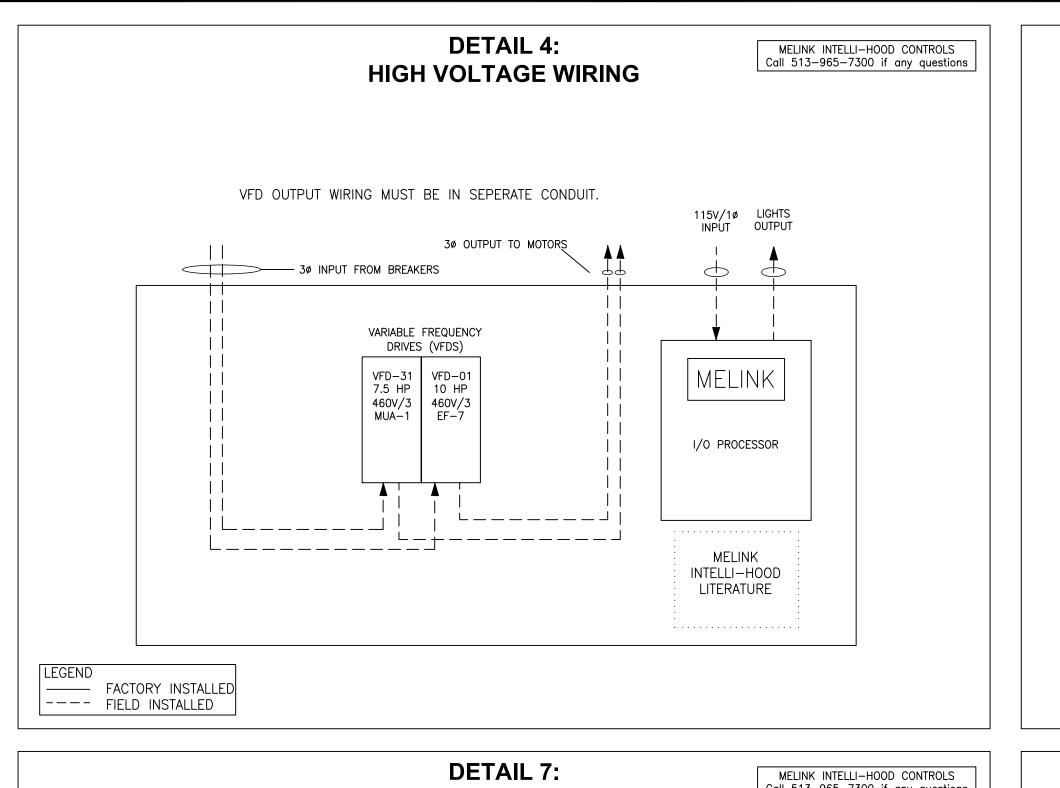

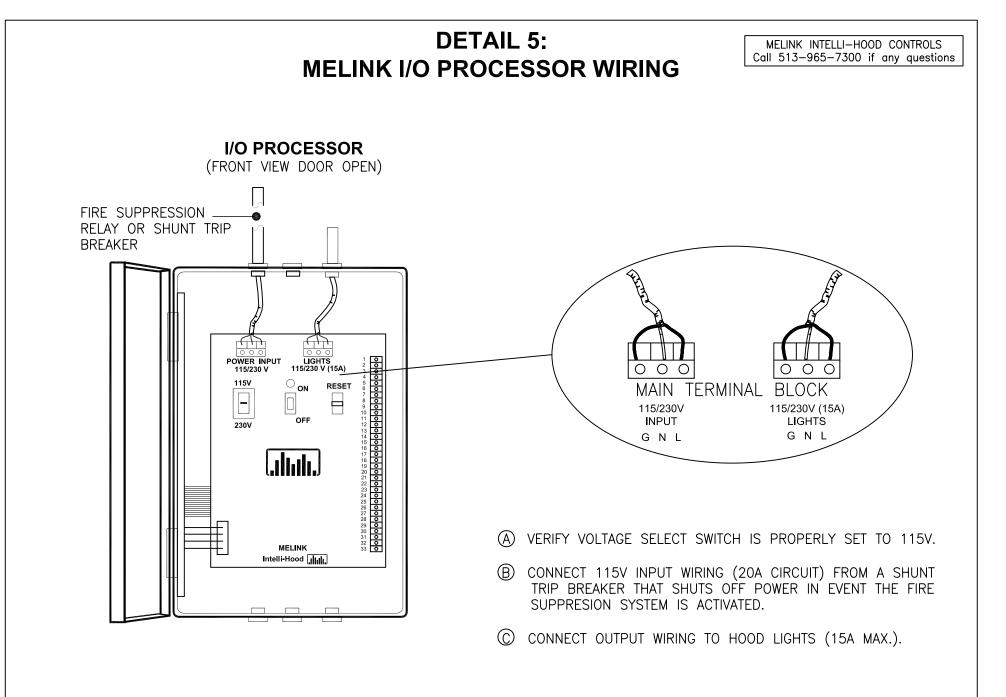

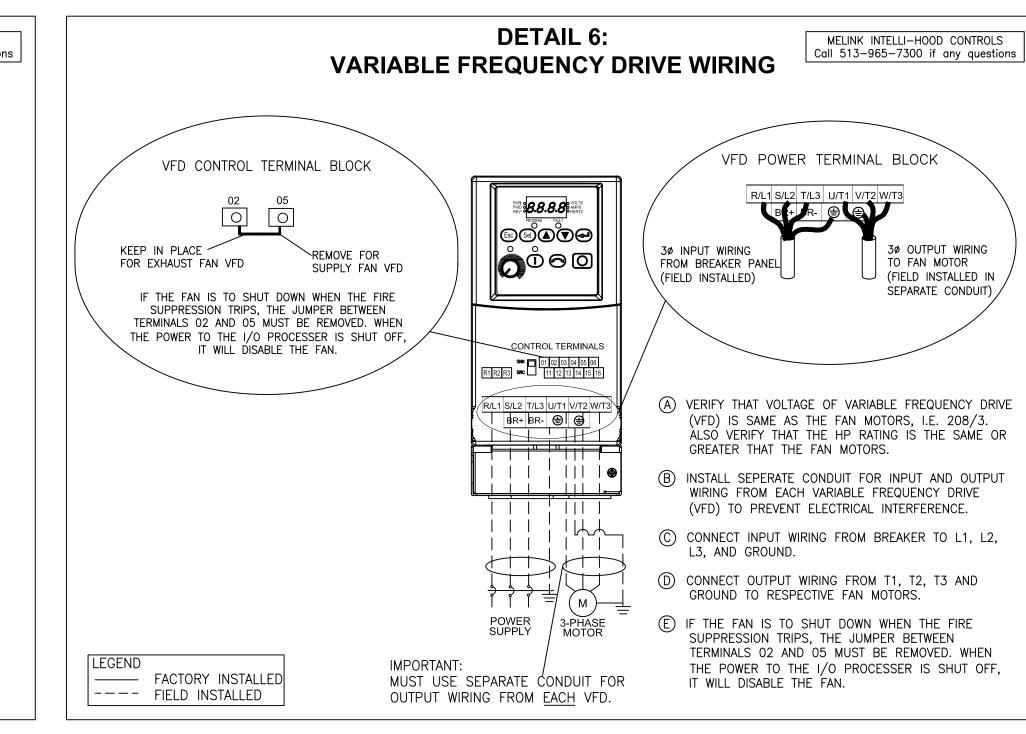

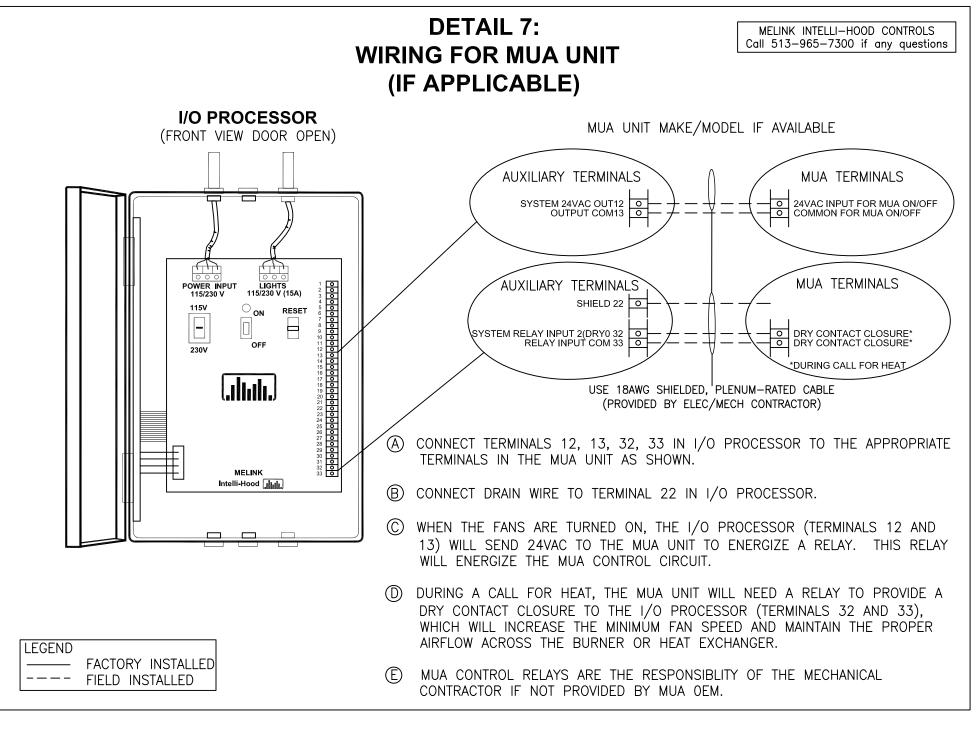


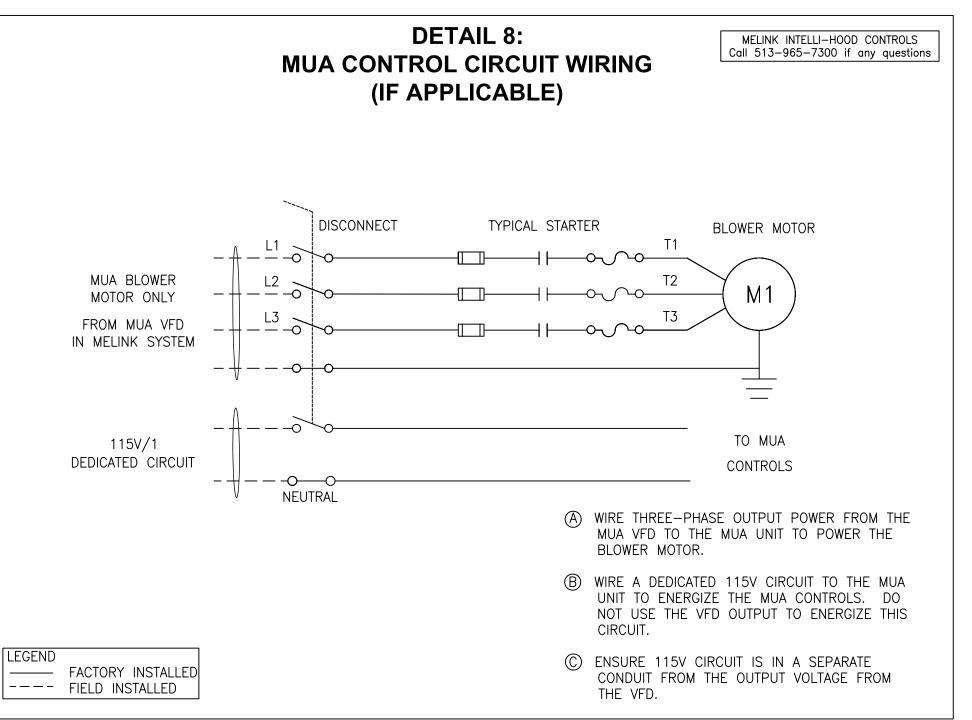



DETAIL 9:
NOT USED

Most Use Servaraic Conduit For it will disable the FAN.

Median intelli—Hood Controls
Coll 513—527—7020 if any questions

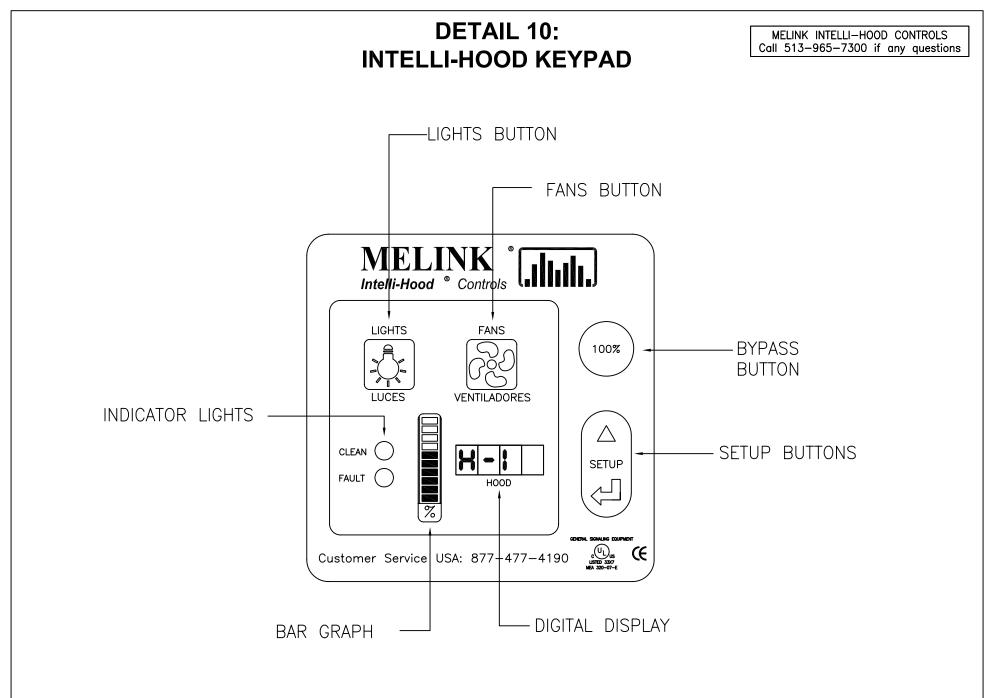

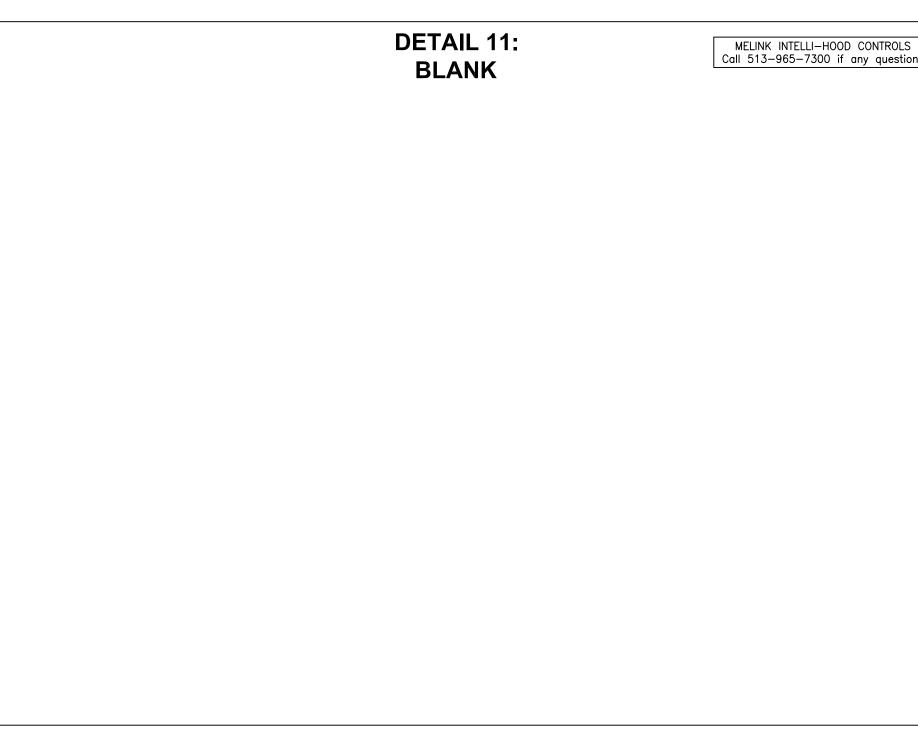

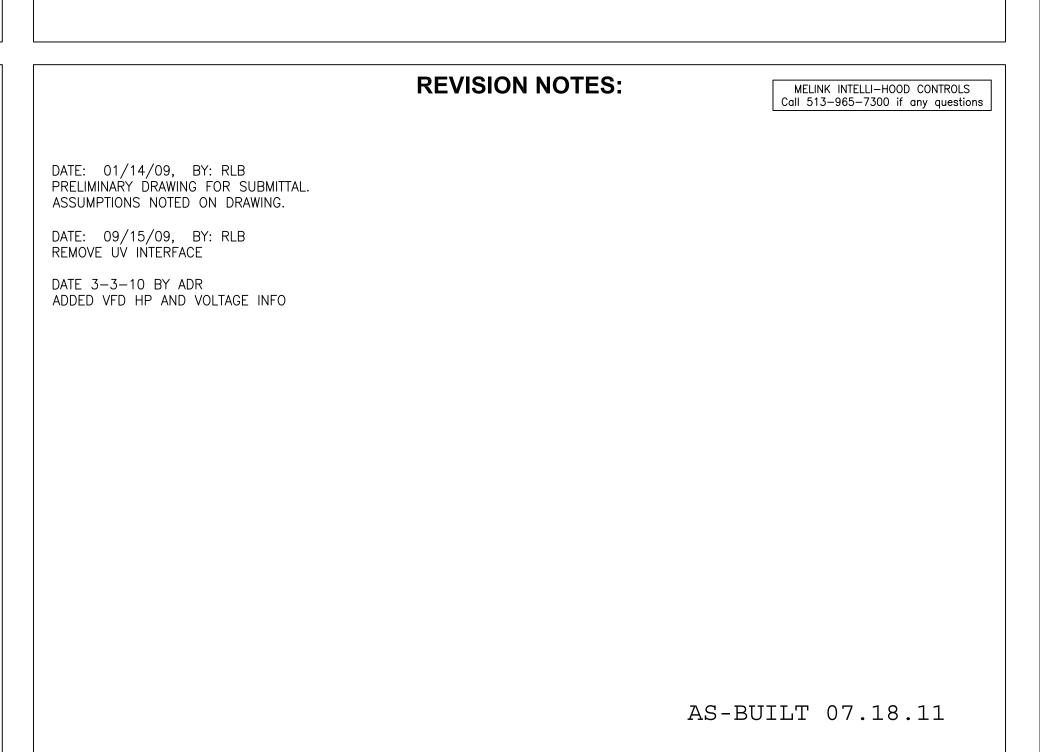


MA RE RE OF 2

OLLEGE


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5140 RIVER VALLEY ROAD MILFORD, OH 45150 PHONE: (513) 965-7300 FAX: (513) 965-7353 www.melinkcorp.com intellihood@melinkcorp.com





ITEM: 4 ALUMINUM TRIM ANGLES (6) TOTAL REQ'D.

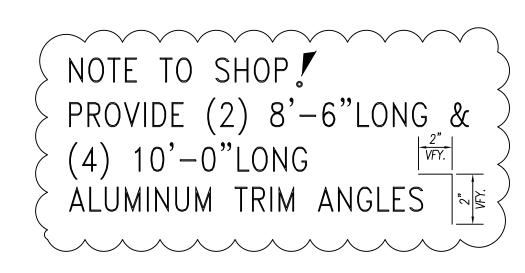


 $\frac{\text{PLAN VIEW}}{3/4" = 1'-0"}$

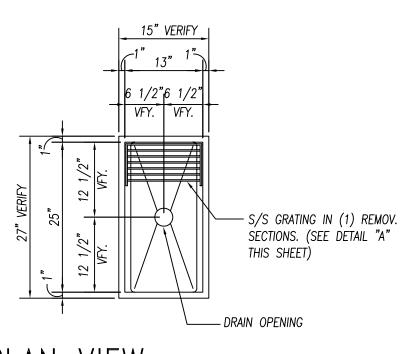ITEM:8 FLOOR TROUGH
(1) REQ'D.

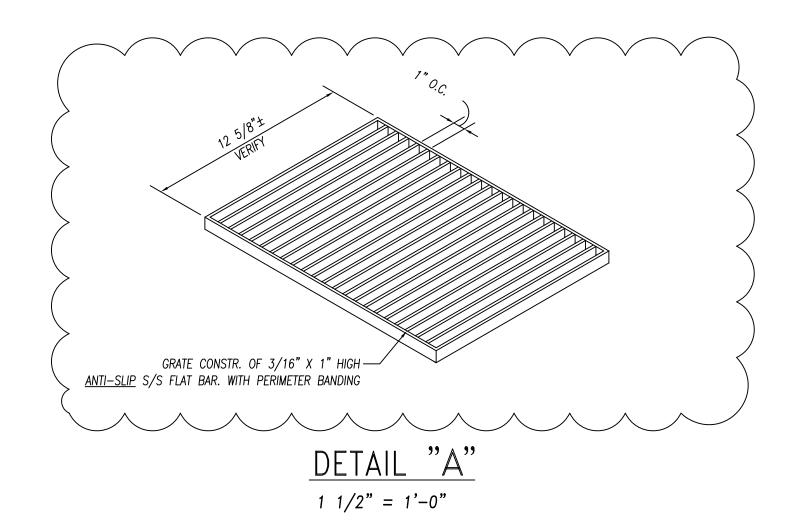


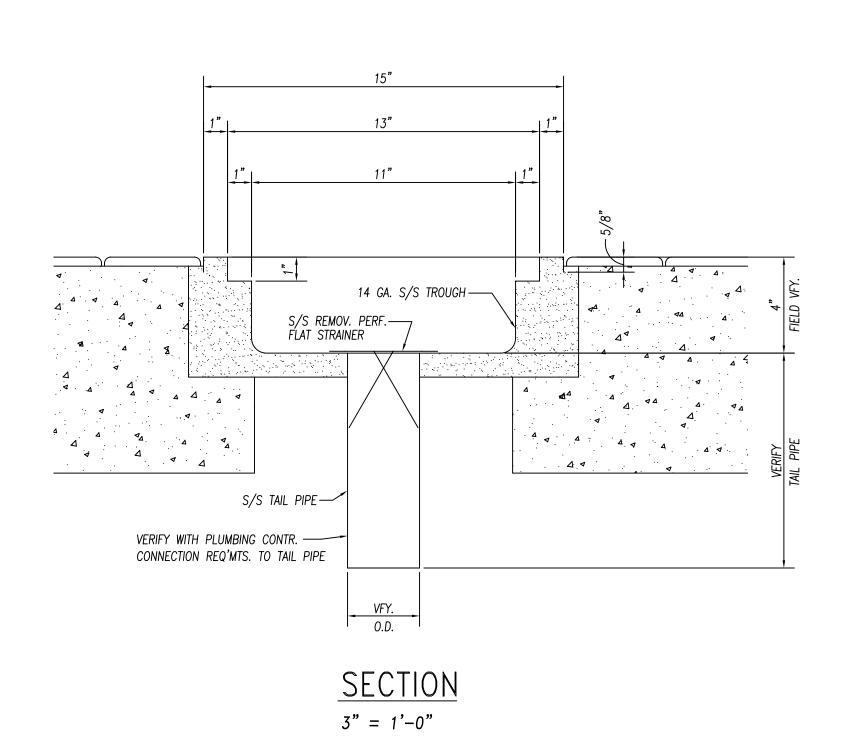


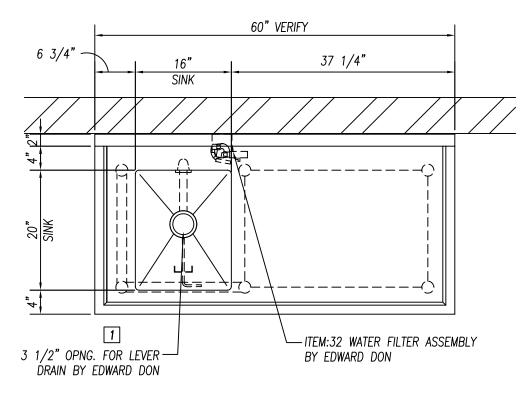

 $\frac{\text{PLAN VIEW}}{3/4" = 1'-0"}$

ITEM:31 WORKTABLE
(1) REQ'D.

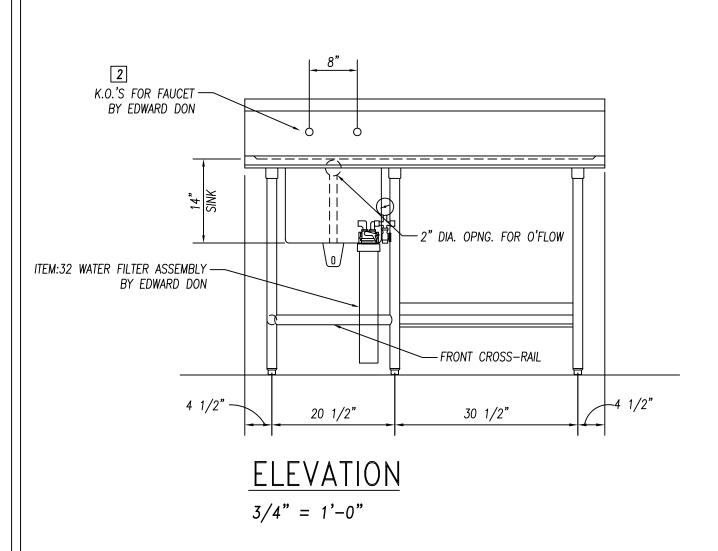

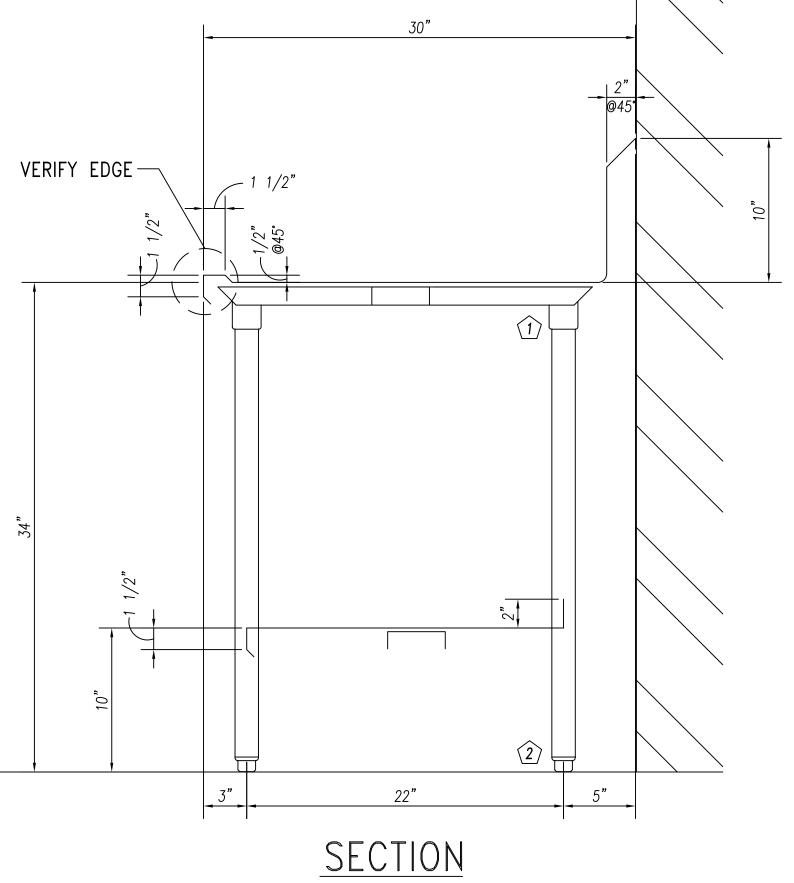

1 1/2" = 1'-0"

		PARTS	LIST				
ID.#	QTY.	DESCRIPTION	MFG. & MODEL NUMBER				
1	6	S/S GUSSETS	COMPONENT HARDWARE #A18-0206				
2	6	S/S BULLET FEET	COMPONENT HARDWARE #A10-0851				
		BUYOUT	LIST				
ID.#	QTY.	DESCRIPTION	MFG. & MODEL NUMBER				
1	1	LEVER DRAIN W/O'FLOW	T & S #B-3970-01				
2	1	SPLASH MTD. FAUCET	T & S #B-0231/B-0199-01 AERATOR				

GENERAL NOTES

14 GA. S/S

16 GA. S/S

18 GA. S/S

16 GA. S/S

2 REINFORCEMENT-UNEXPOSED 1 1/2" X 4" X 1 1/2" X 14 GA. GALV. CHANNEL

1 1/2" X 4" X 1 1/2" X 14 GA. S/S CHANNEL

1 5/8" DIA. X 16 GA. S/S TUBING

16 GA. S/S WITH 14 GA. S/S BRACKETS

18 GA. S/S DOUBLE PAN CONSTR. SOUND DEADEN WITH STYROFOAM

FULLY AT UNDERSIDE OF TOPS

CHROME ACORN NUTZ NO EXPOSED FASTNERS

NO. DESCRIPTION MATERIAL

1 TOPS AND SINKS

3 REINFORCEMENT—EXPOSED

4 LEGS & CROSSRAILS

5 REMOV. UNDERSHELVES

6 WALL & OVERSHELVES

8 DOOR AND DRAWER FACES

9 FIXED UNDERSHELVES

10 SOUND DEADENING

11 FASTNERS

7 COUNTER BODY


REINFORCEMENT TO BE NOT MORE


THAN 30" O.C. WITH INTERSECTIONS OF
CHANNELS FULLY WELDED.
SOUND DEADENING MASTIC TO BE
APPLIED BETWEEN TOP & CHANNEL
REINFORCEMENT ONLY.

These Items ARE NOT PROVIDED BY NATIONWIDE


★ Items That Must Be Shipped To Nationwide For Installation

	UL LISTED	10923 LEROY DRIVE Fabrication, Inc. PHONE: (303) 853-0107 NORTHGLENN, CO. 80233 FAX: (303) 853-0114	THE TOWN THE
	DATE: 2-22-10	PROJECT: JOLIET JR. COLLEGE	
REVISIONS:	DRAWN BY: CUSHING	Joliet, IL	
	CHECKED BY:	CUSTOMER: EDWARD DON	PAGE NUMBER
	SCALE: AS NOTED	North Riverside, IL	1 OF 24
CONSULTANT:	ITEMS THIS SHEET:	TEN A ALLMANIA TONA ANOLES ITEM S ELOSO TROUGH	JOB NUMBER
Mackesey And Associates LLC Crystal Lake, IL		ITEM:4 ALUMINUM TRIM ANGLES, ITEM:8 FLOOR TROUGH ITEM:31 WORKTABLE	5789

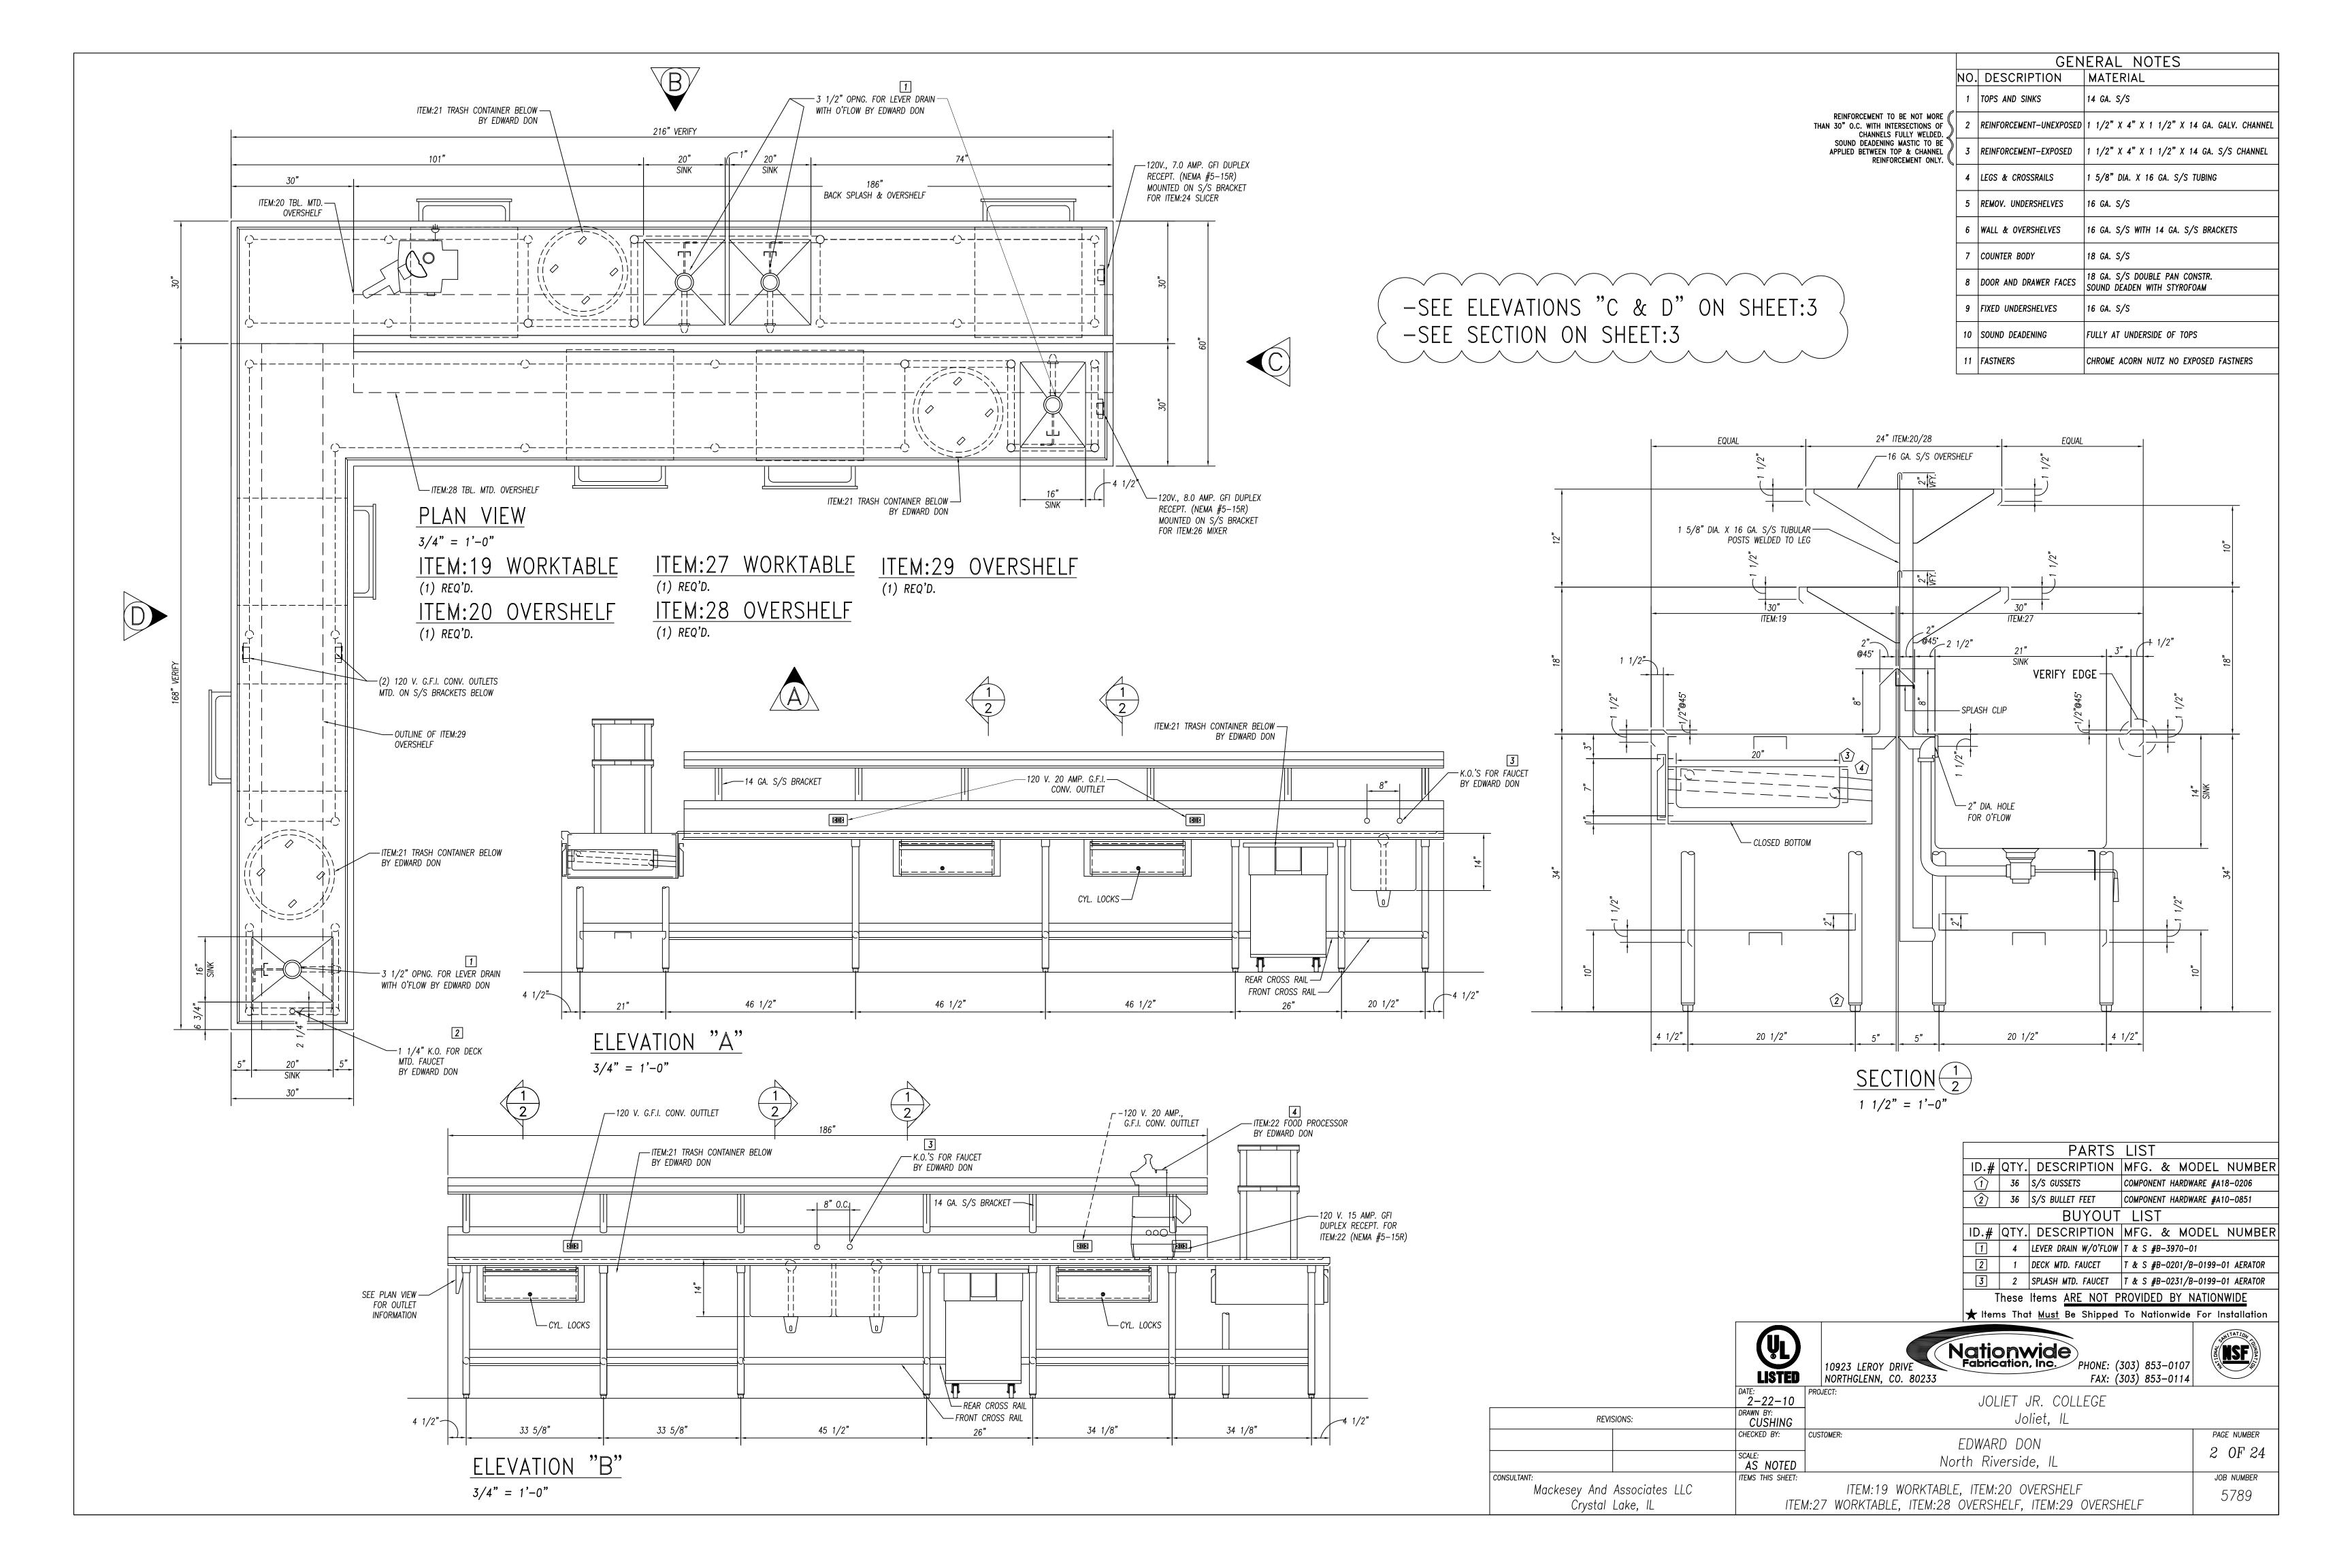

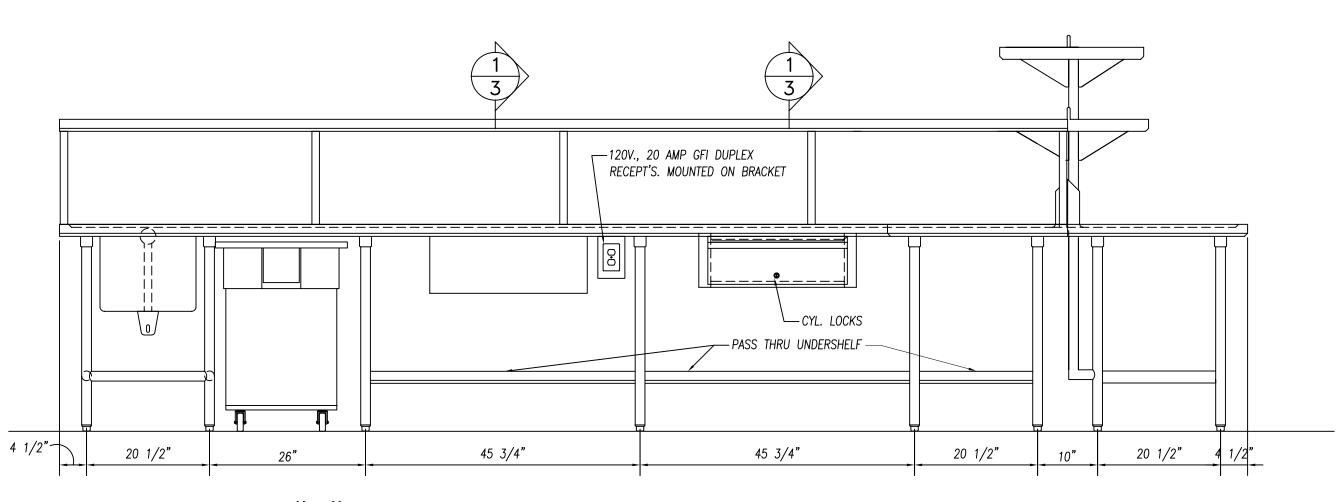



 $\frac{\text{ELEVATION "C"}}{3/4" = 1'-0"}$

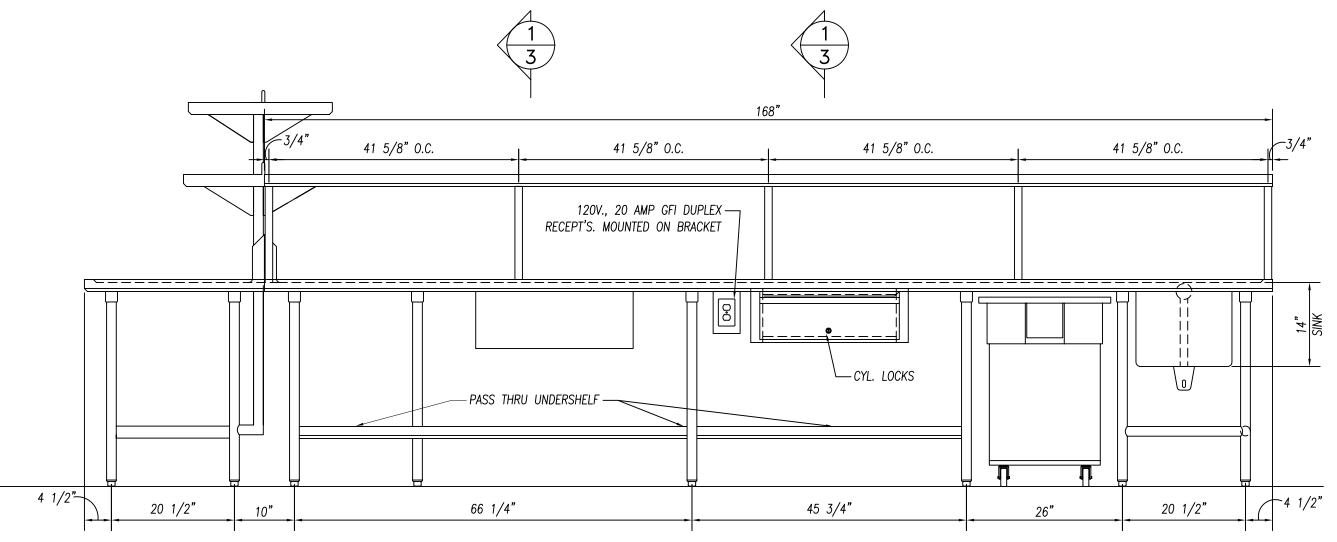

<u>ELEVATION</u> "D"

3/4" = 1'-0"

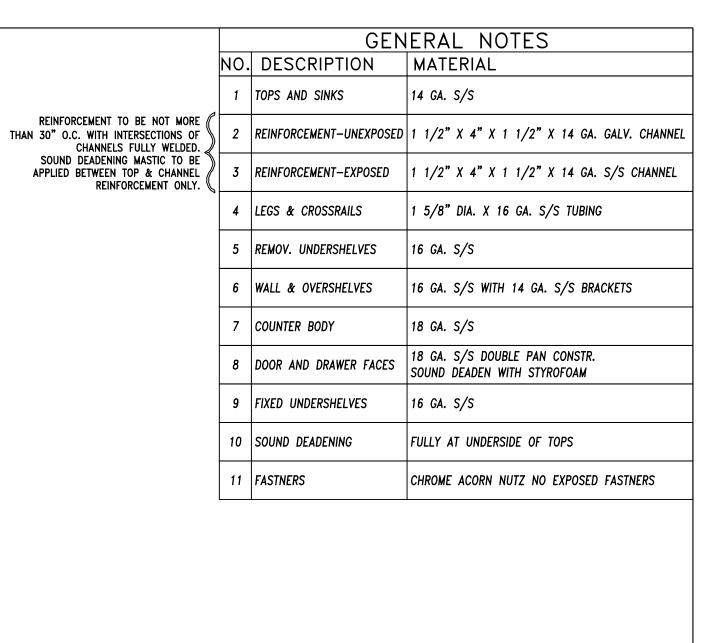


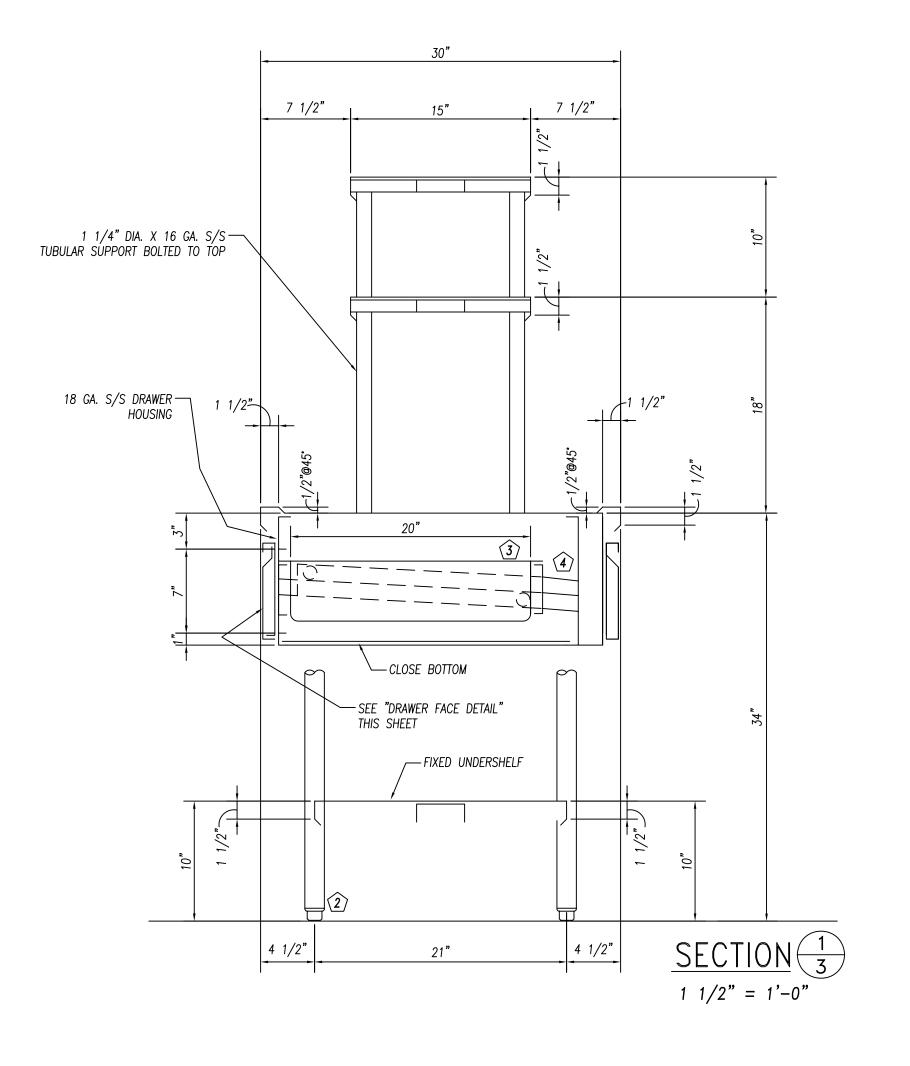



		PARTS	LIST			
ID.#	QTY.	DESCRIPTION	MFG. & MODEL NUMBER			
1	36	S/S GUSSETS	COMPONENT HARDWARE #A18-0206			
2	36	S/S BULLET FEET	COMPONENT HARDWARE #A10-0851			
		BUYOUT	LIST			
ID.#	QTY.	DESCRIPTION	MFG. & MODEL NUMBER			
1	4	LEVER DRAIN W/O'FLOW	T & S #B-3970-01			
2	1	DECK MTD. FAUCET	T & S #B-0201/B-0199-01 AERATOR			
3	2	SPLASH MTD. FAUCET	T & S #B-0231/B-0199-01 AERATOR			


These Items ARE NOT PROVIDED BY NATIONWIDE


★ Items That Must Be Shipped To Nationwide For Installation

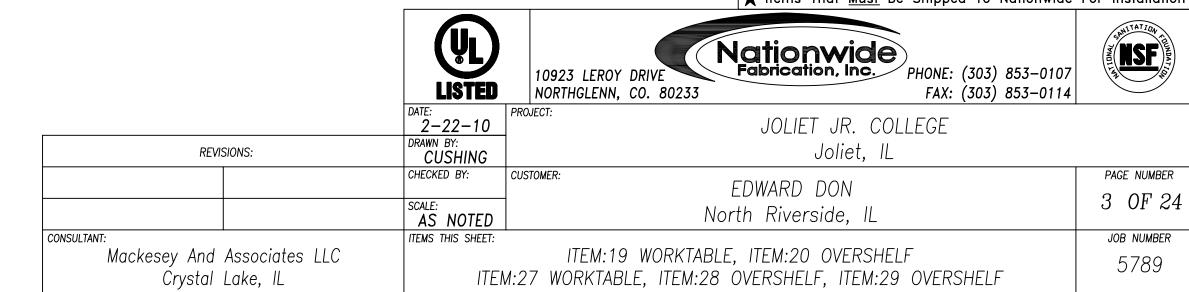


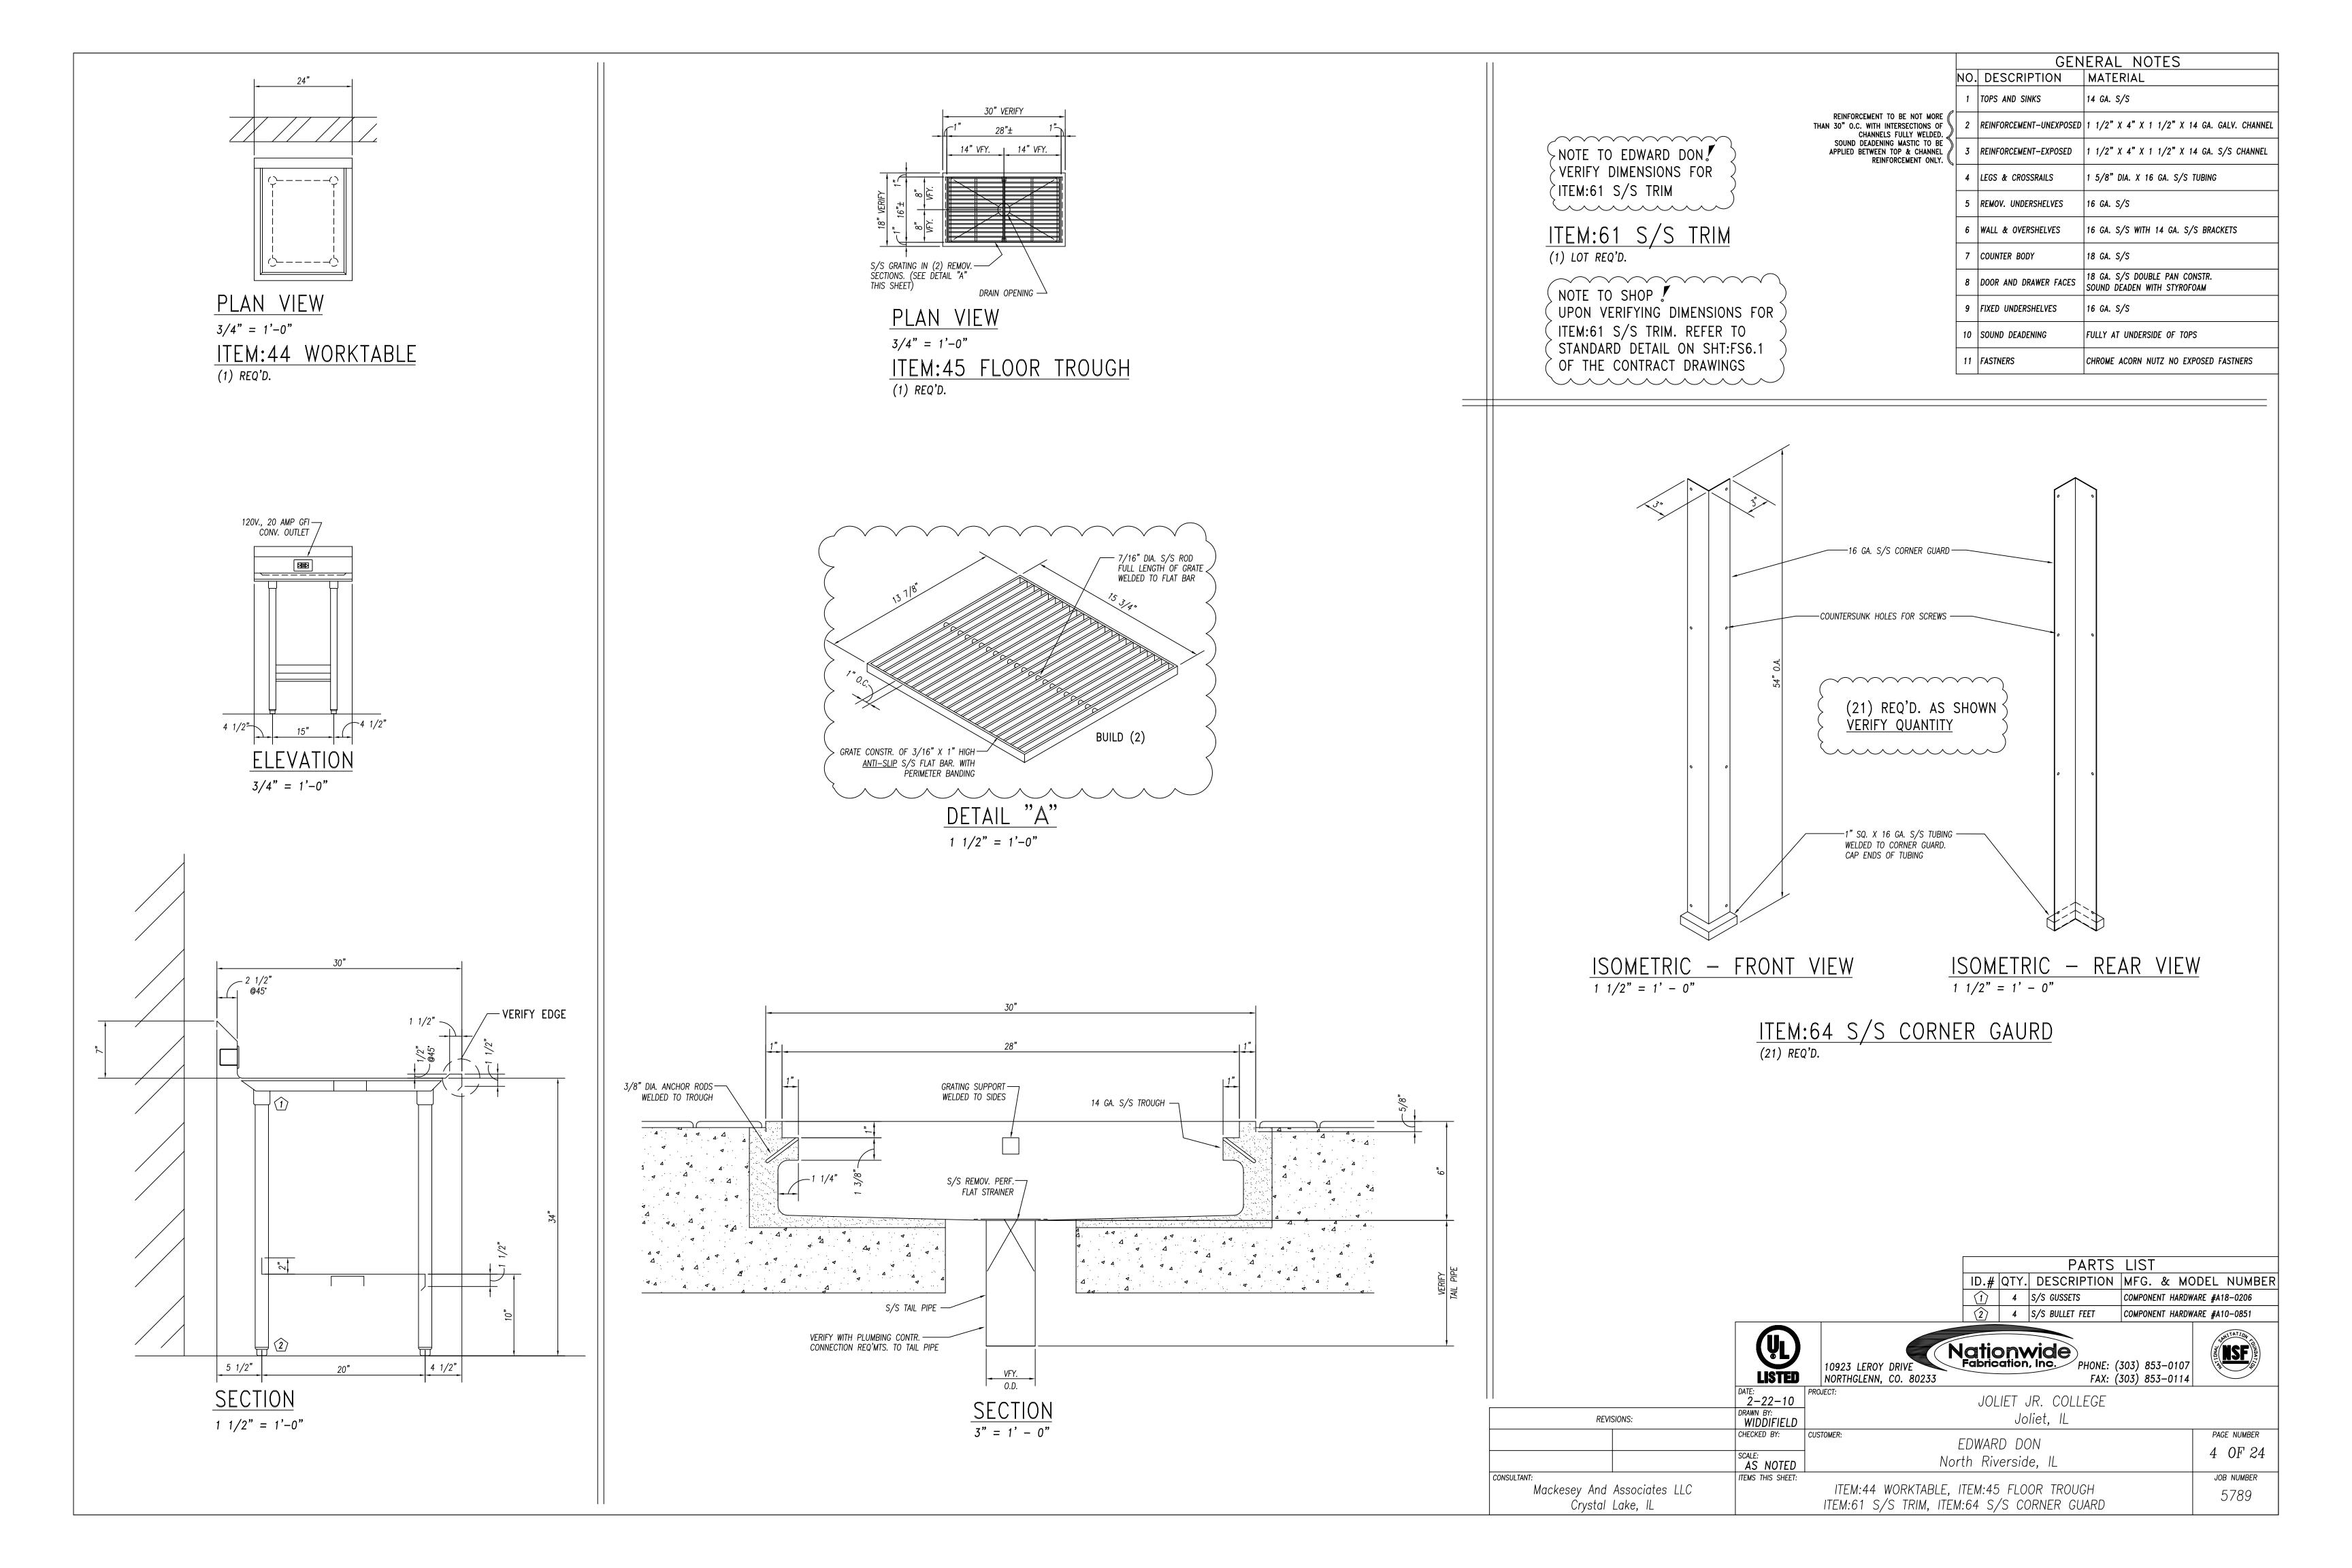


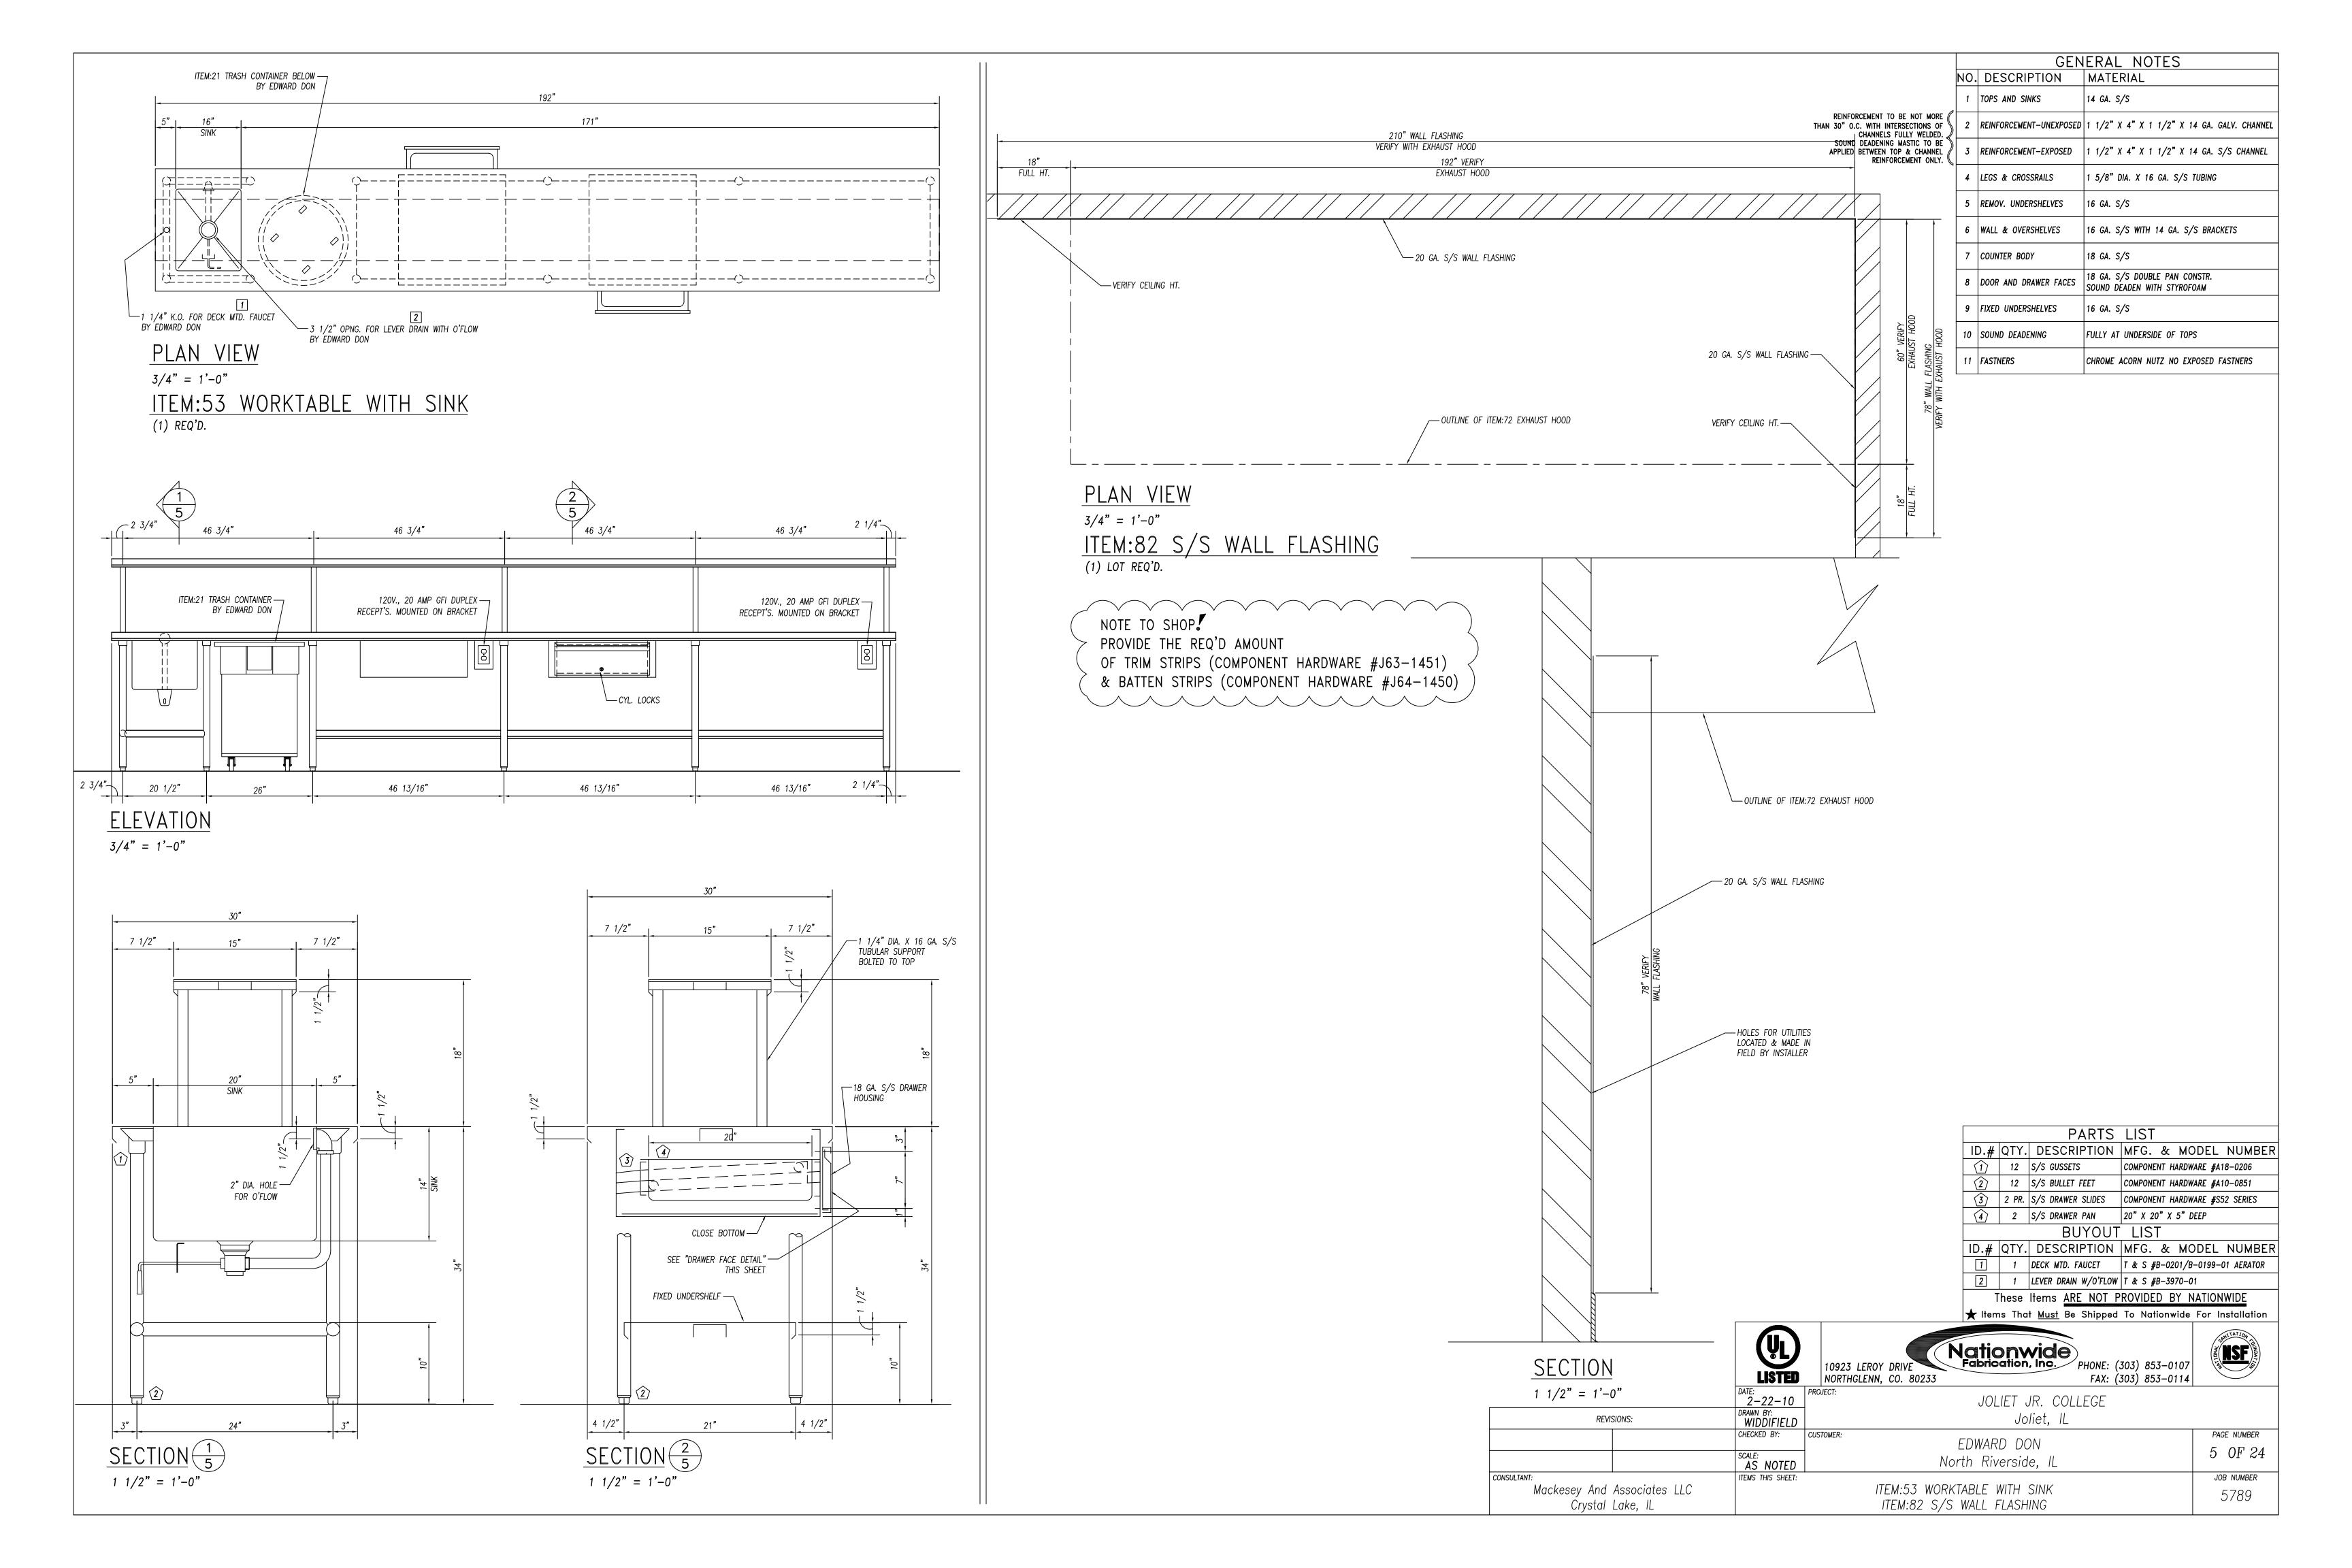


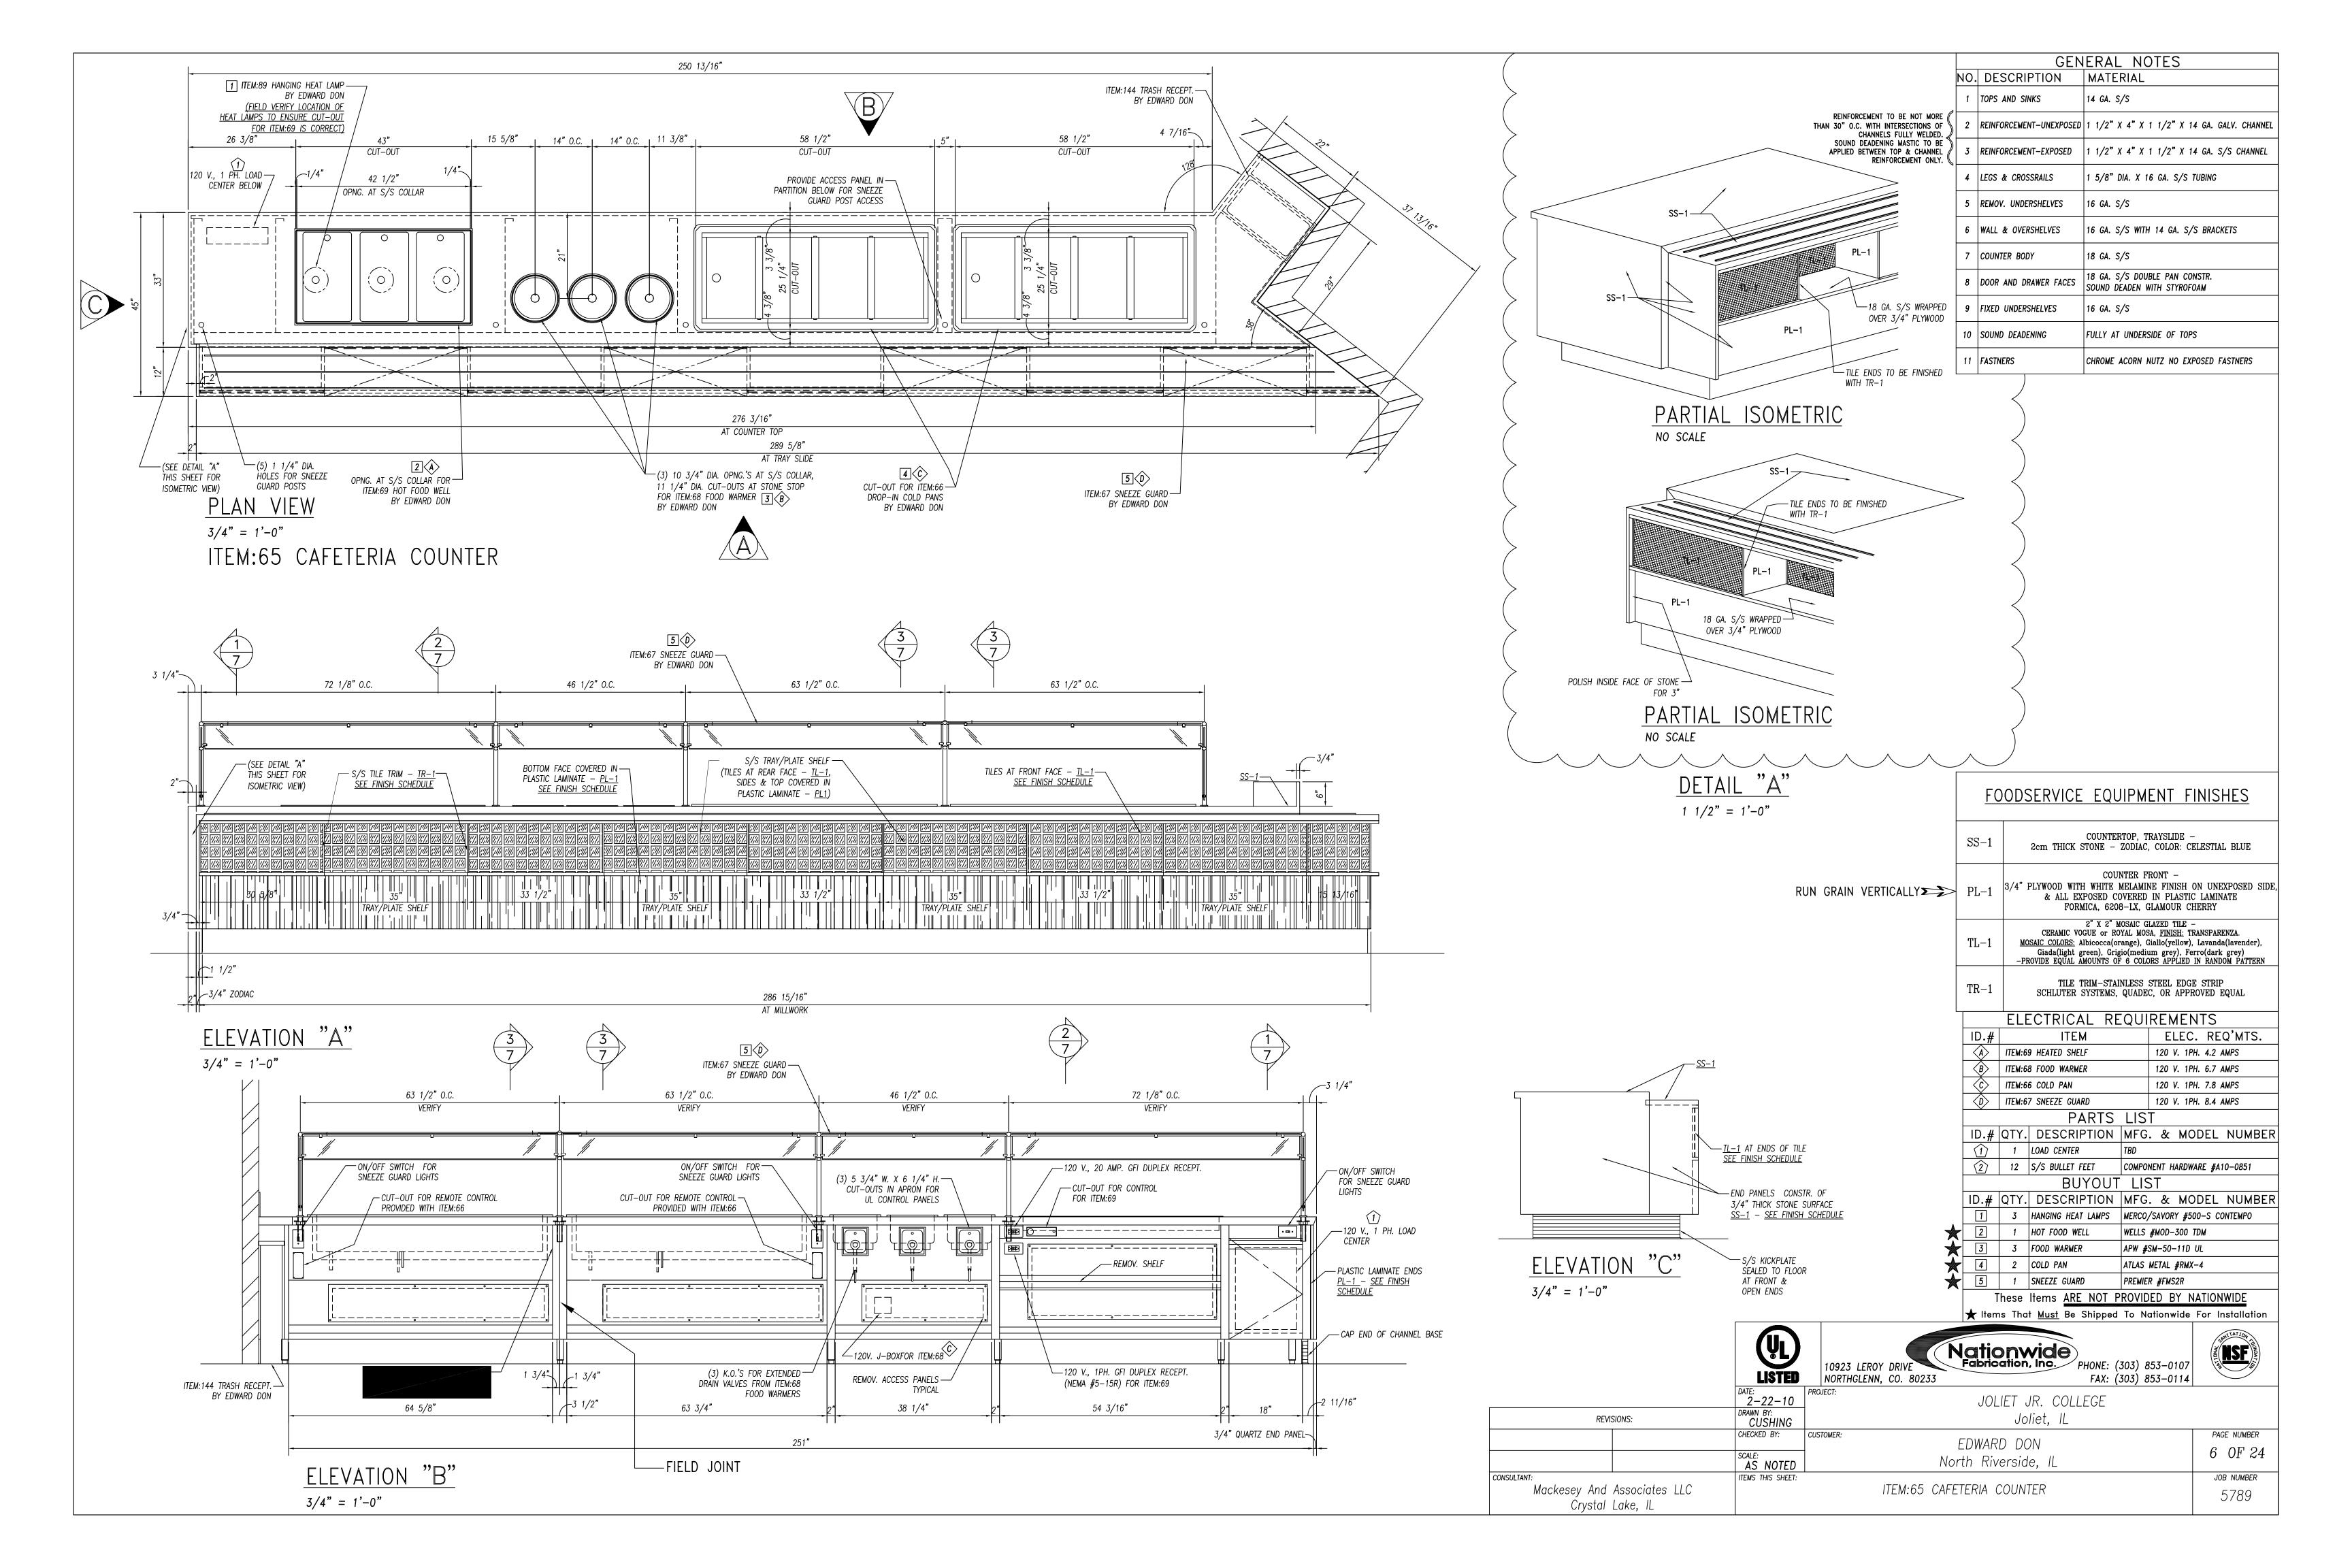


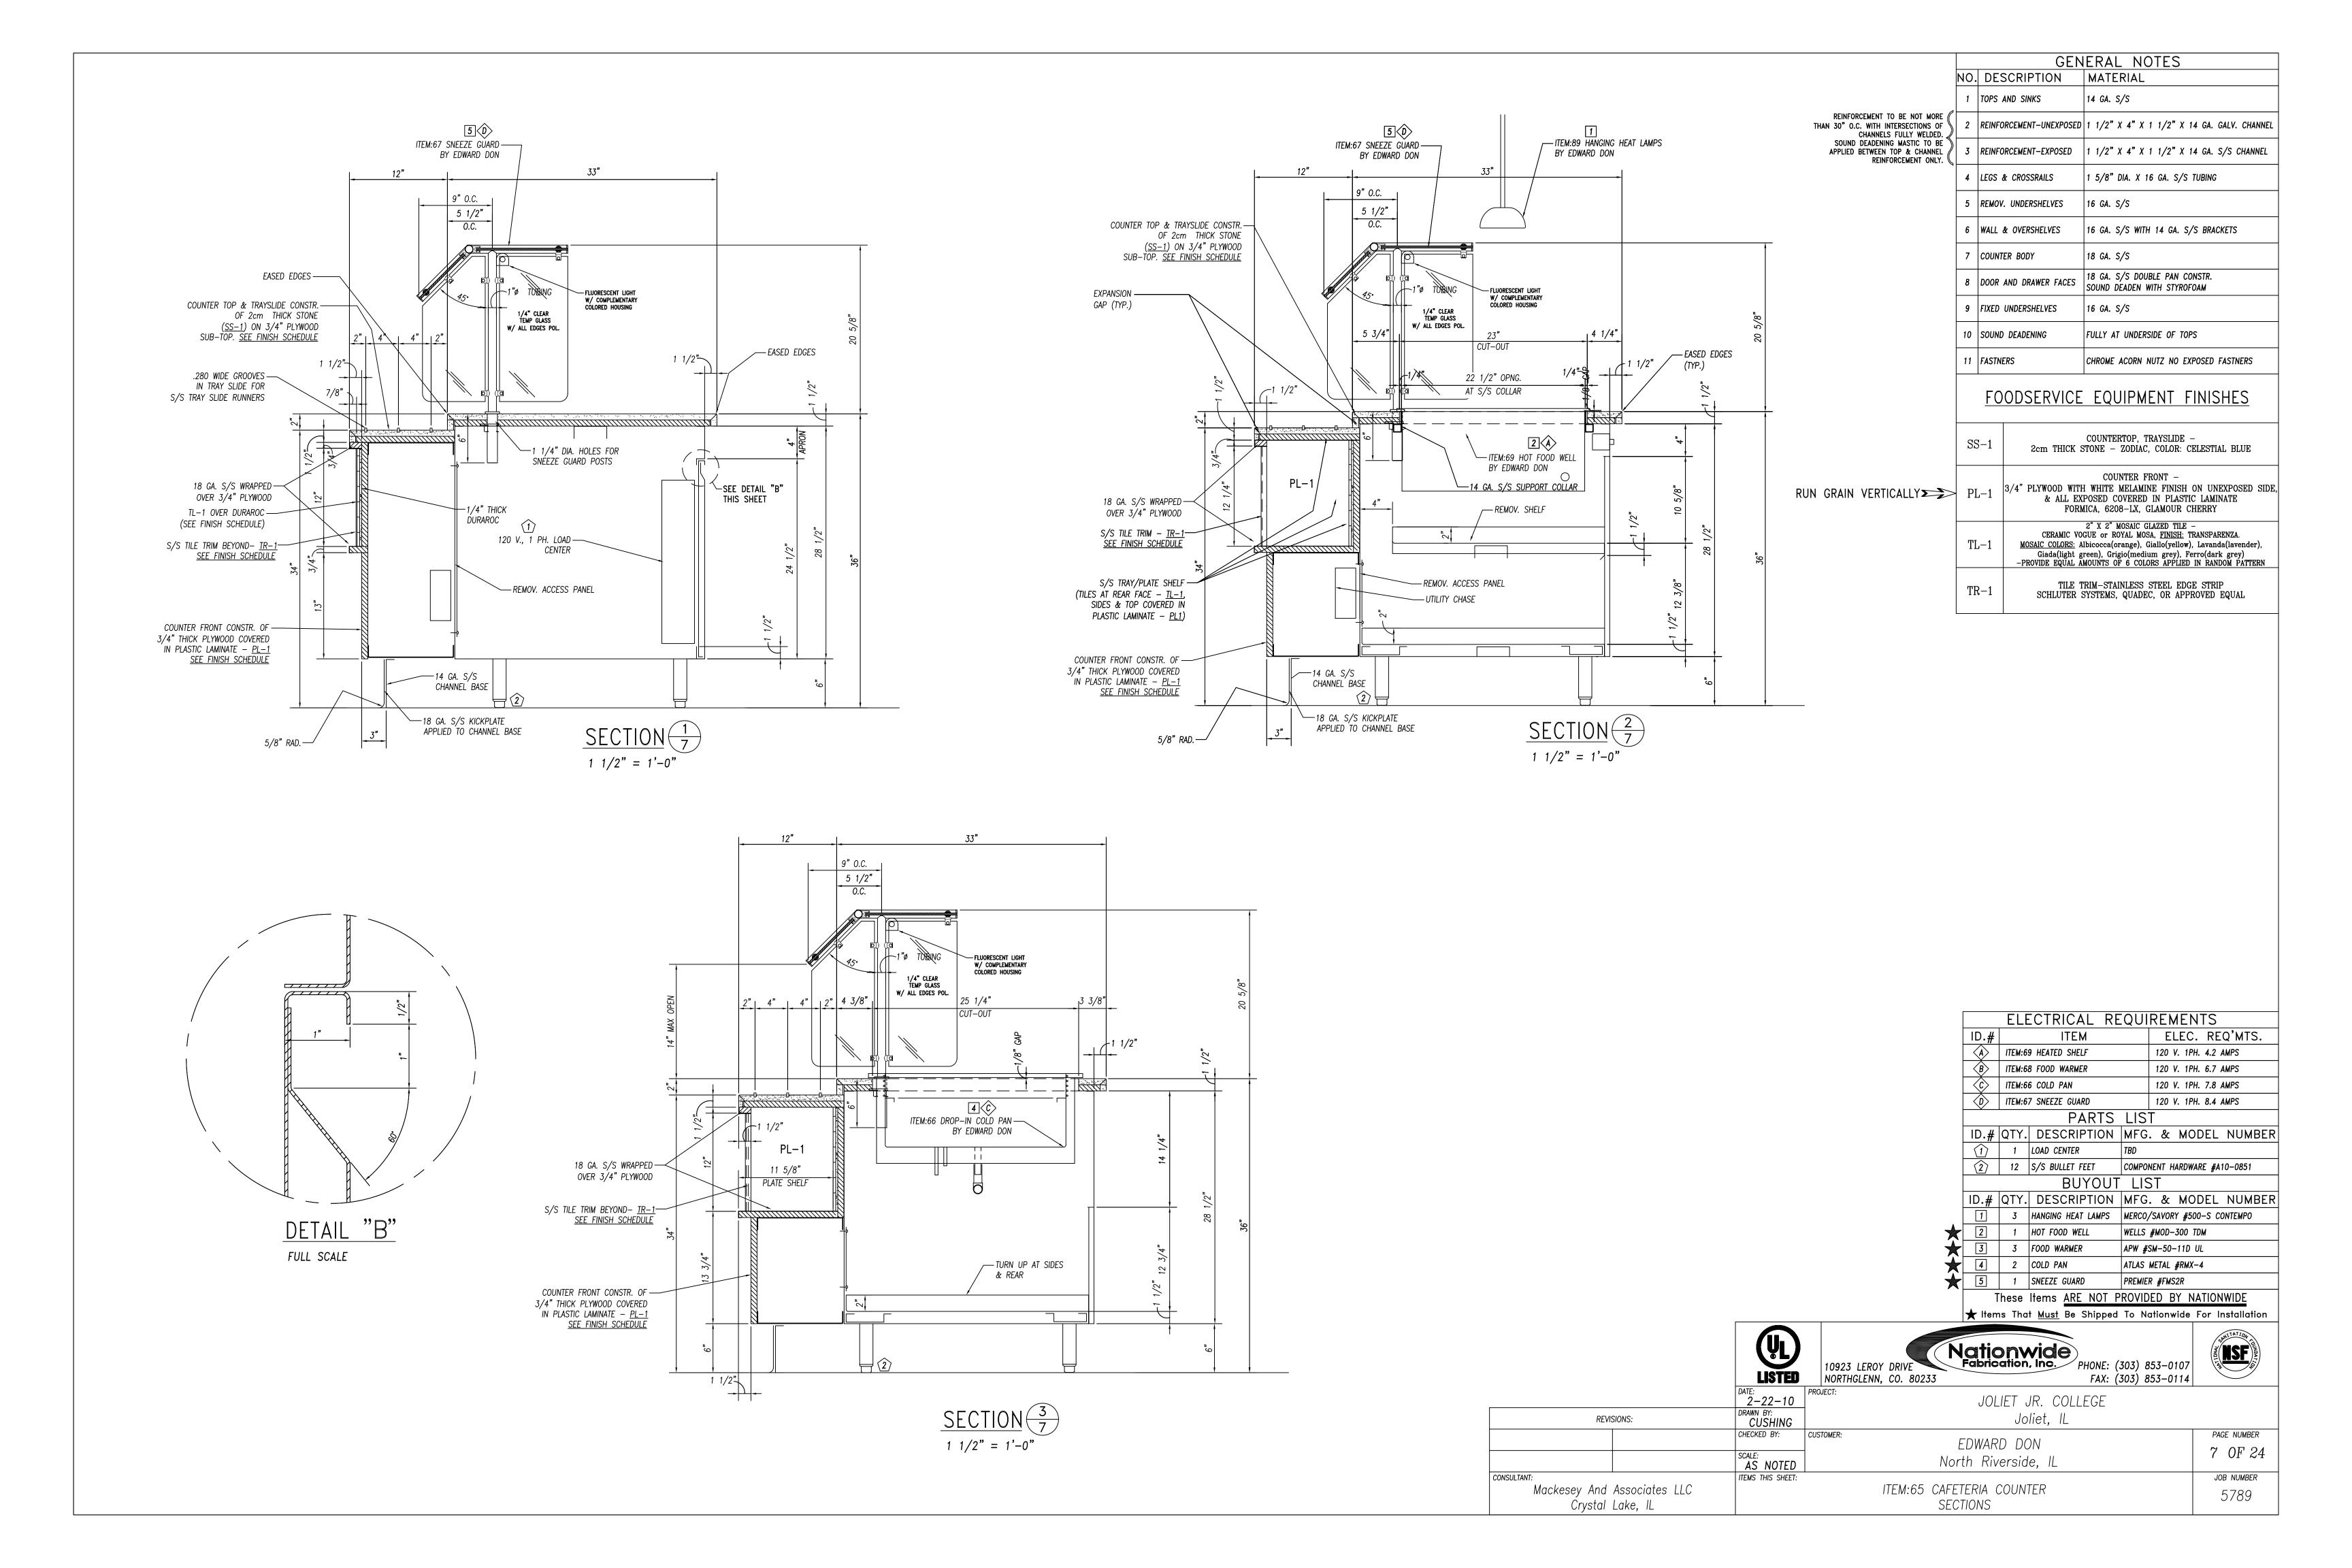


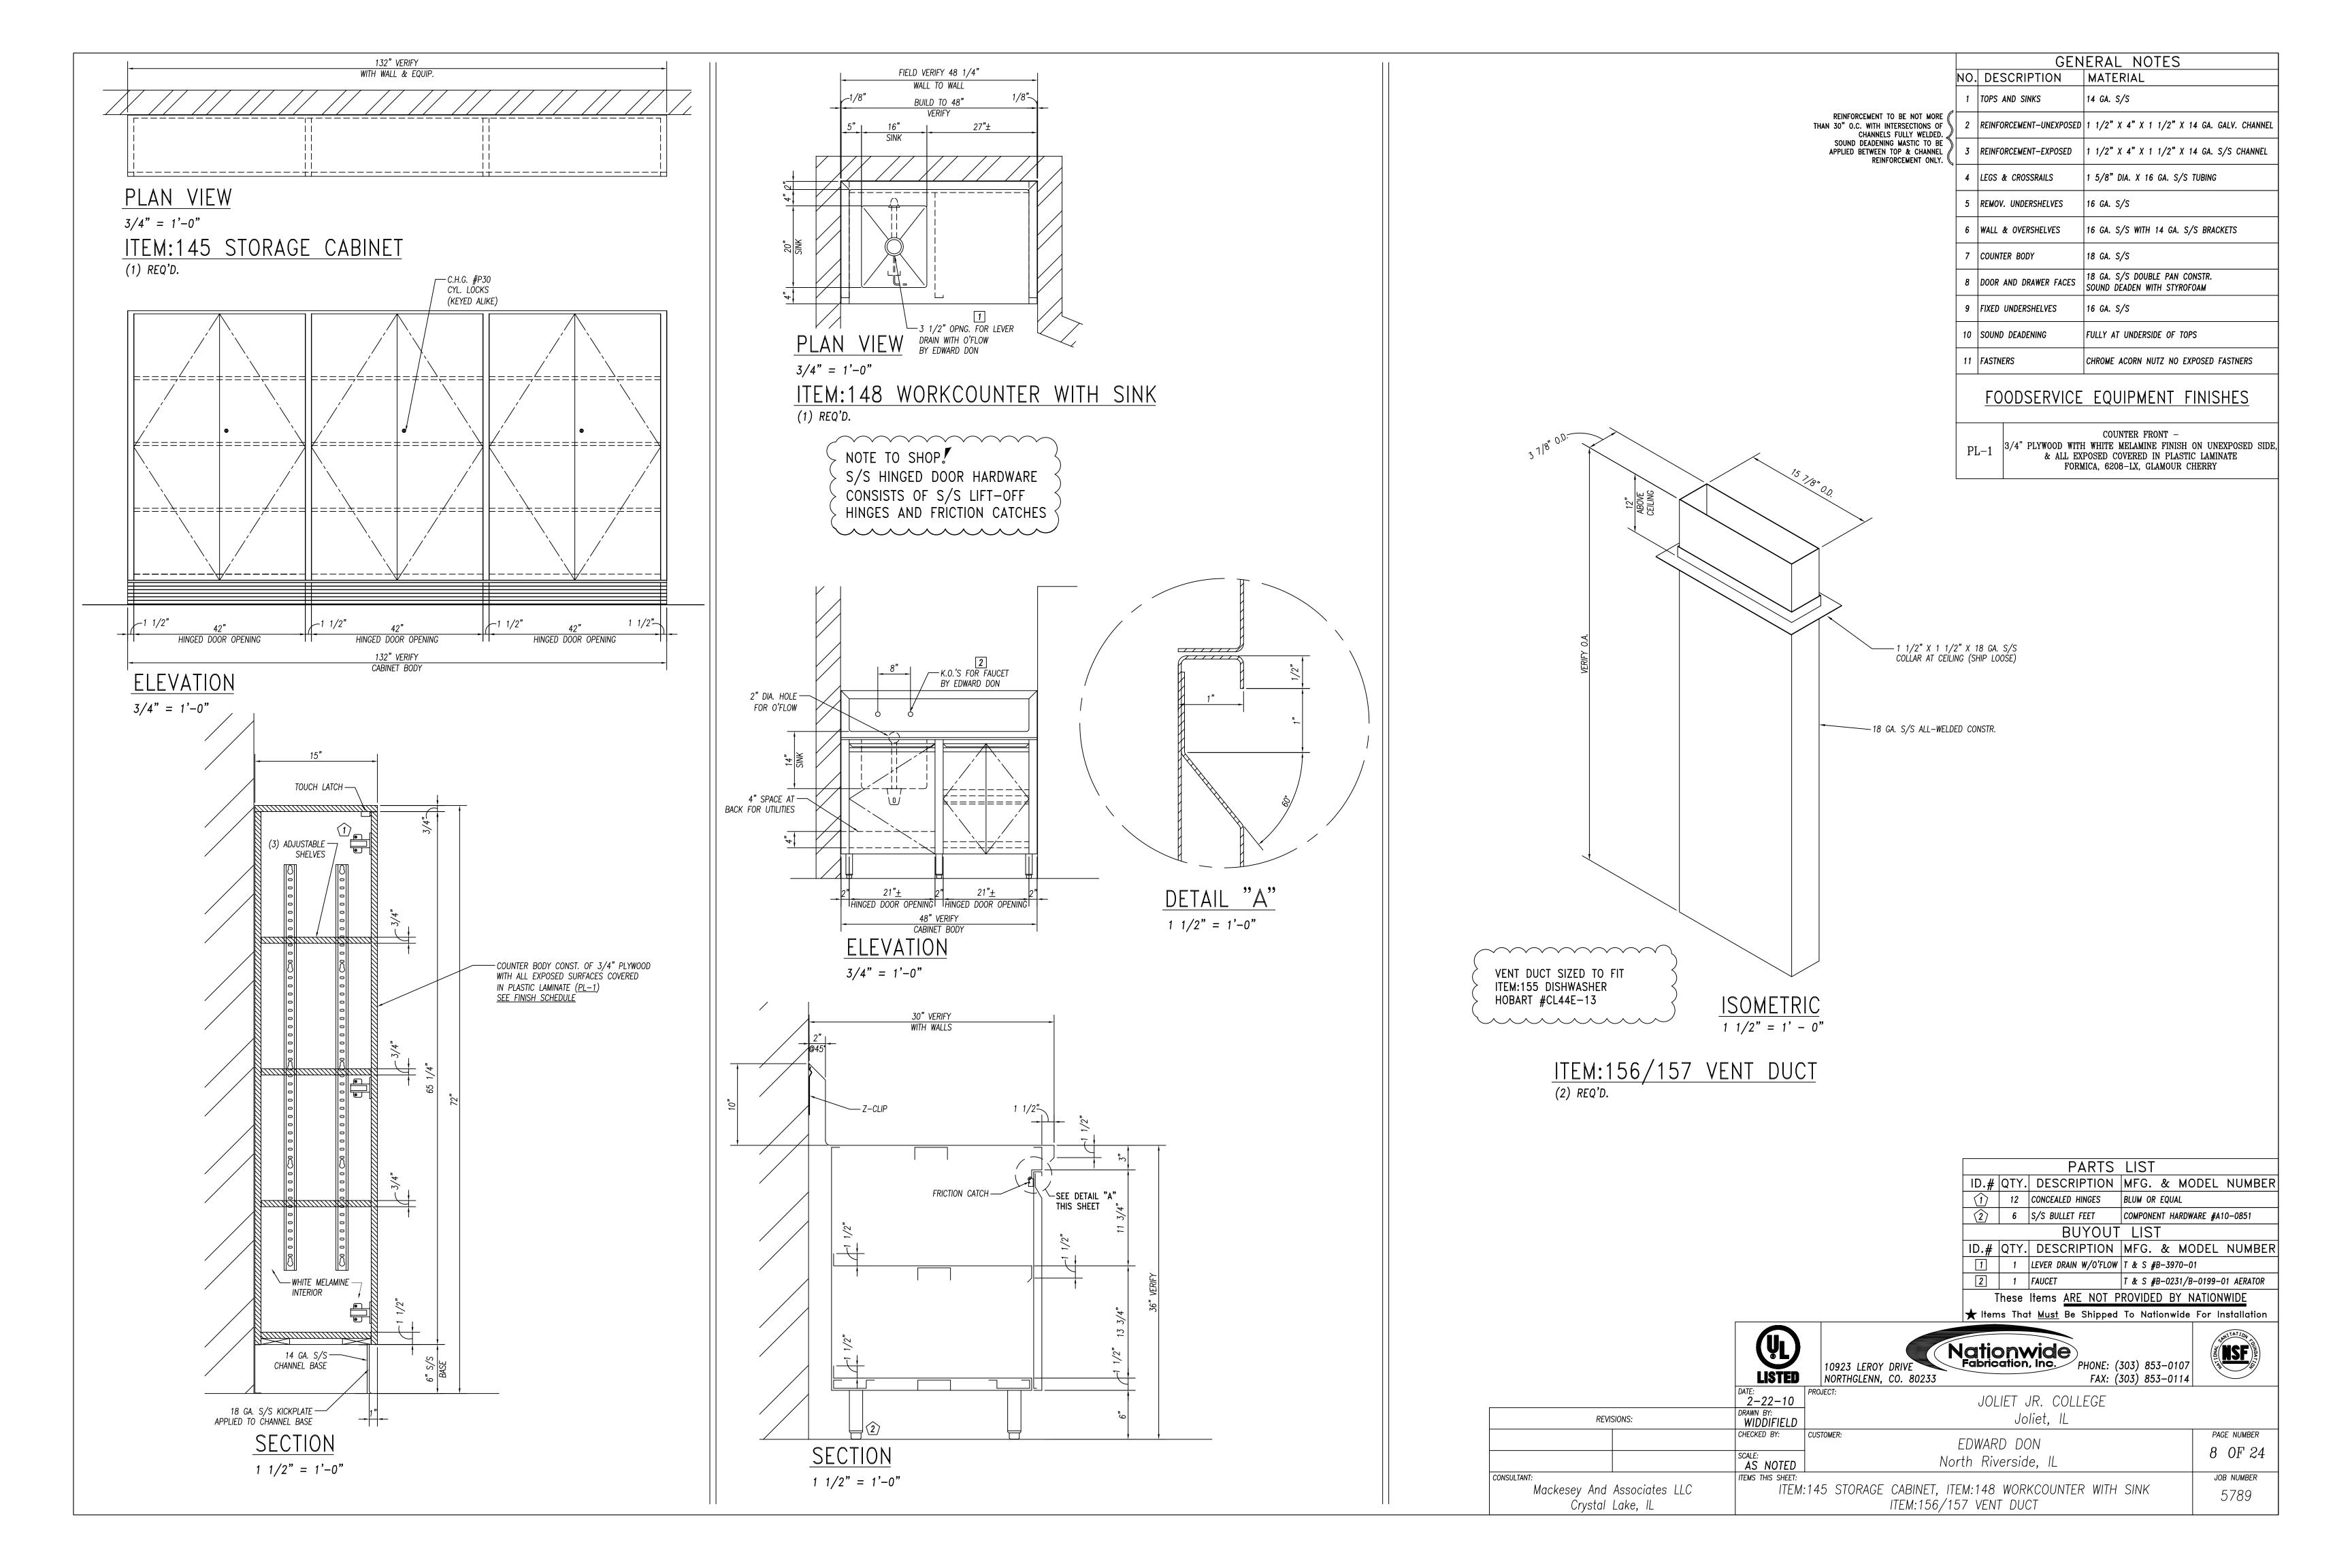


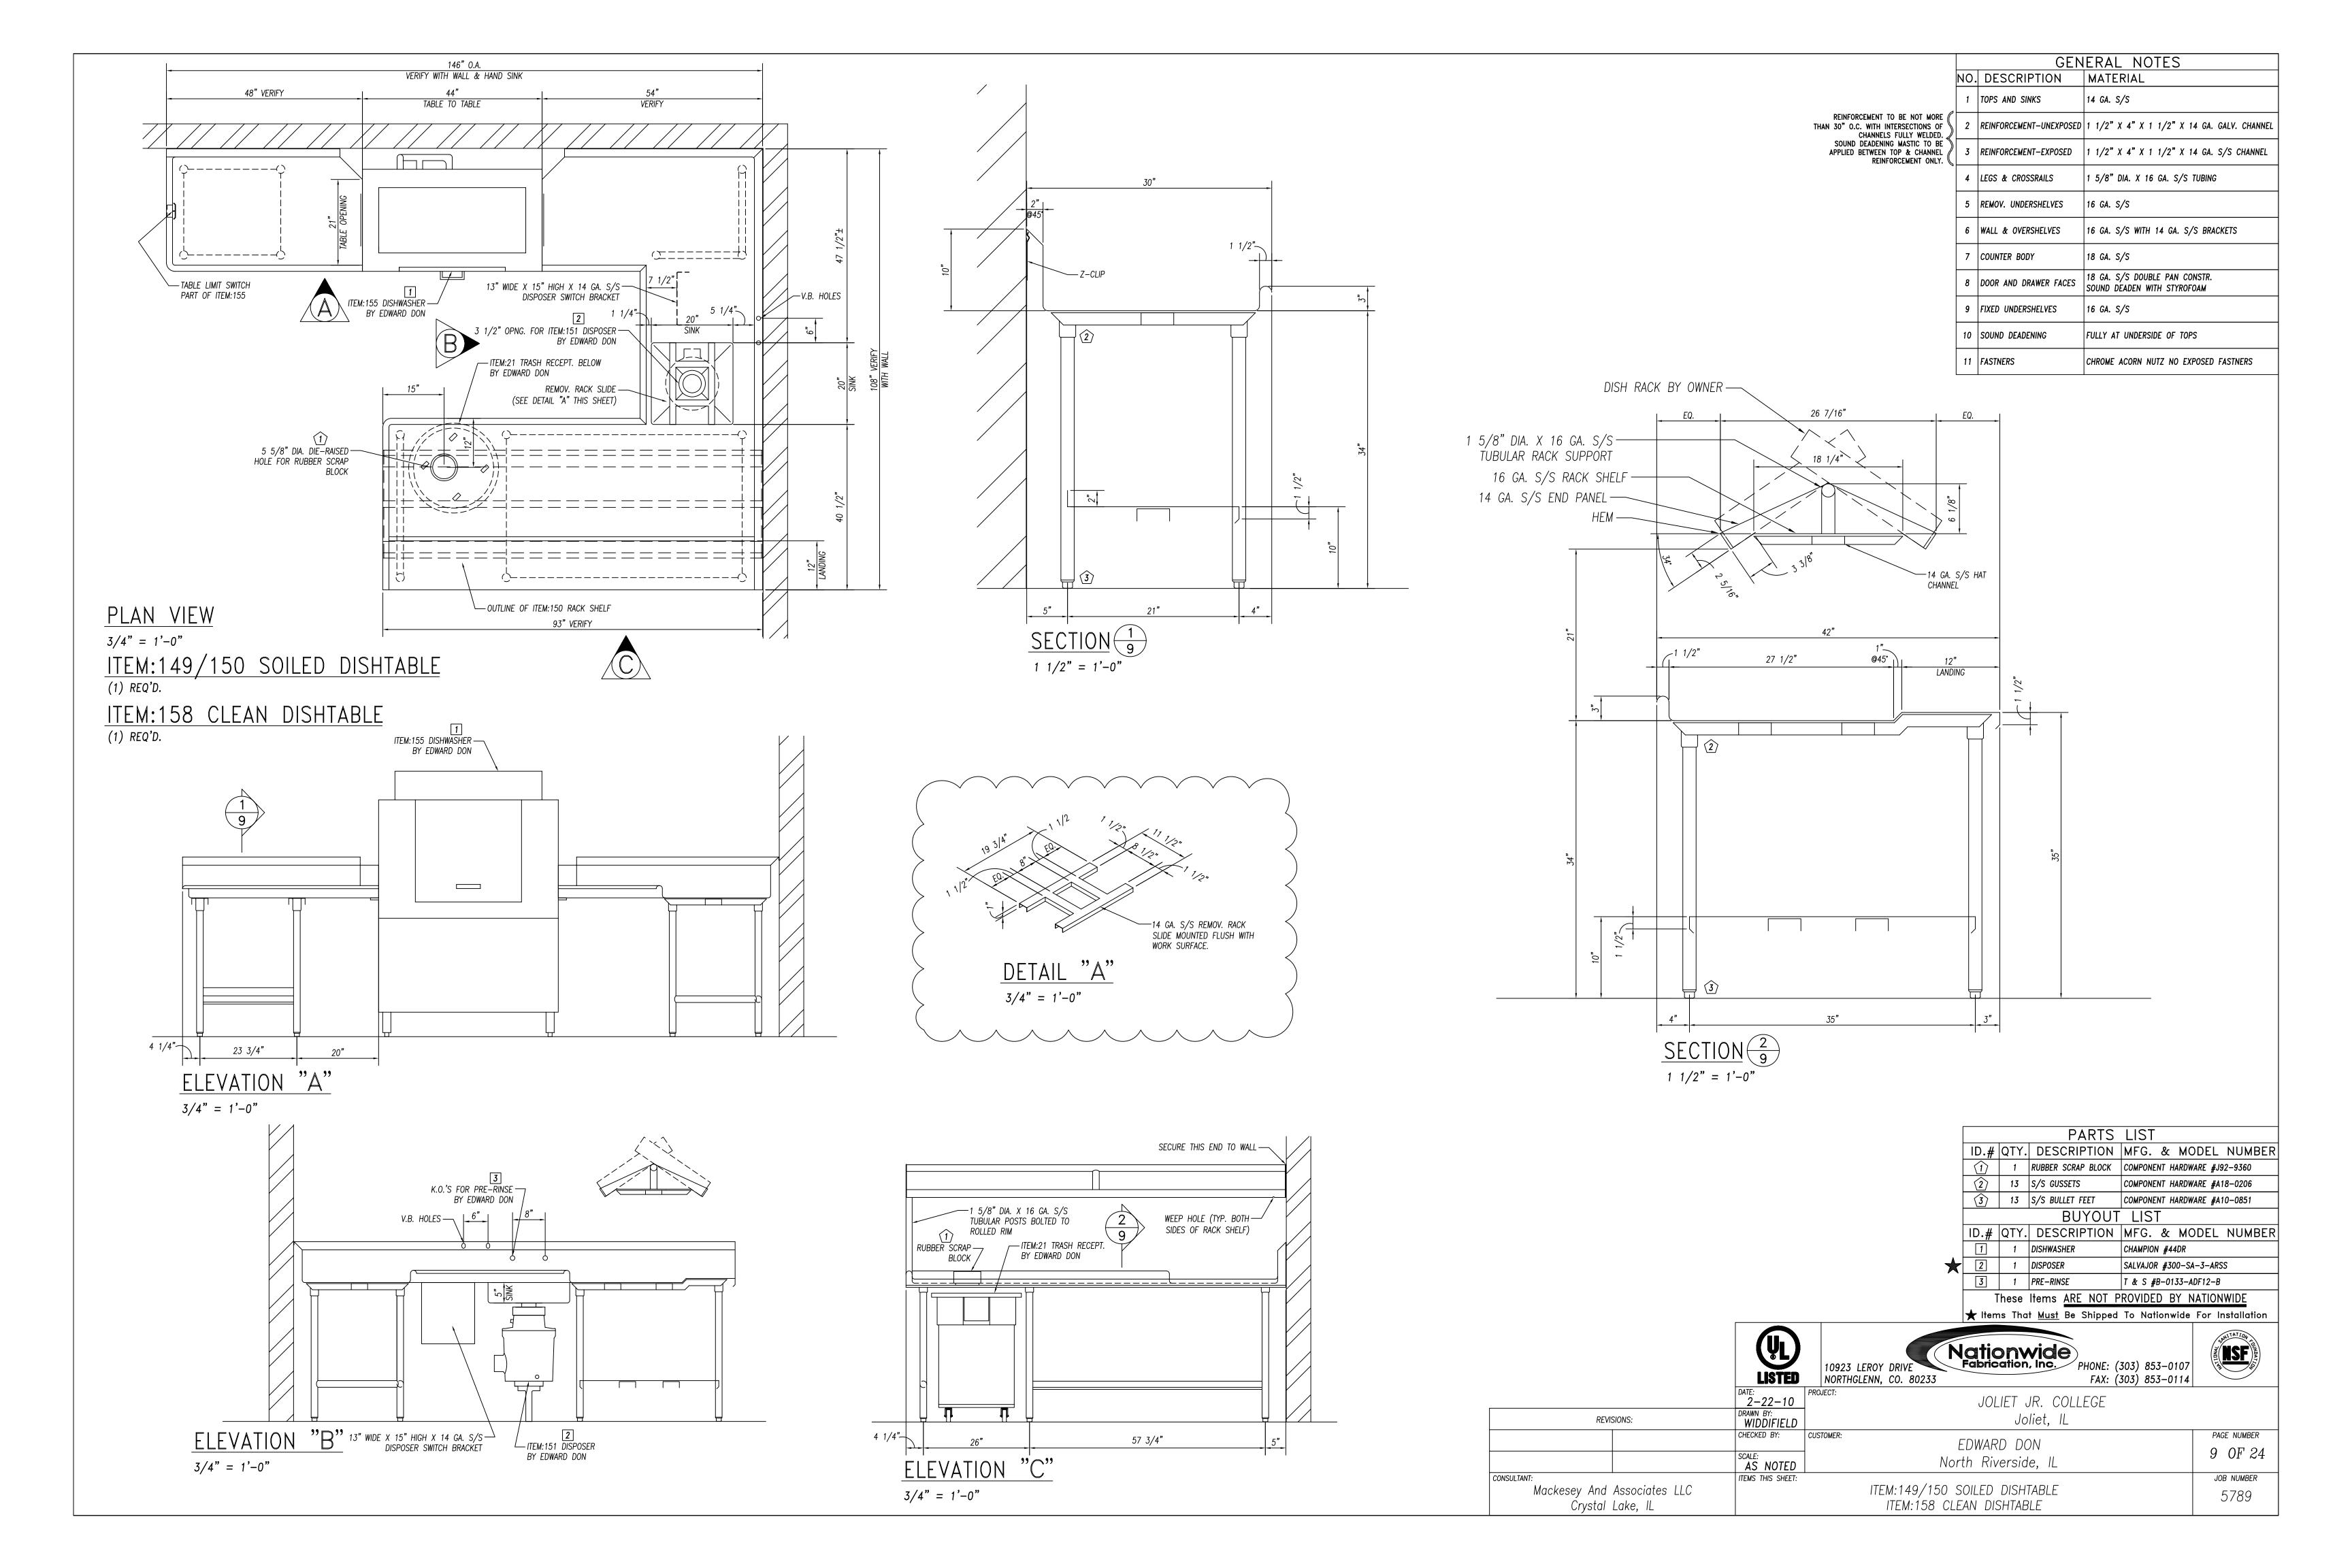


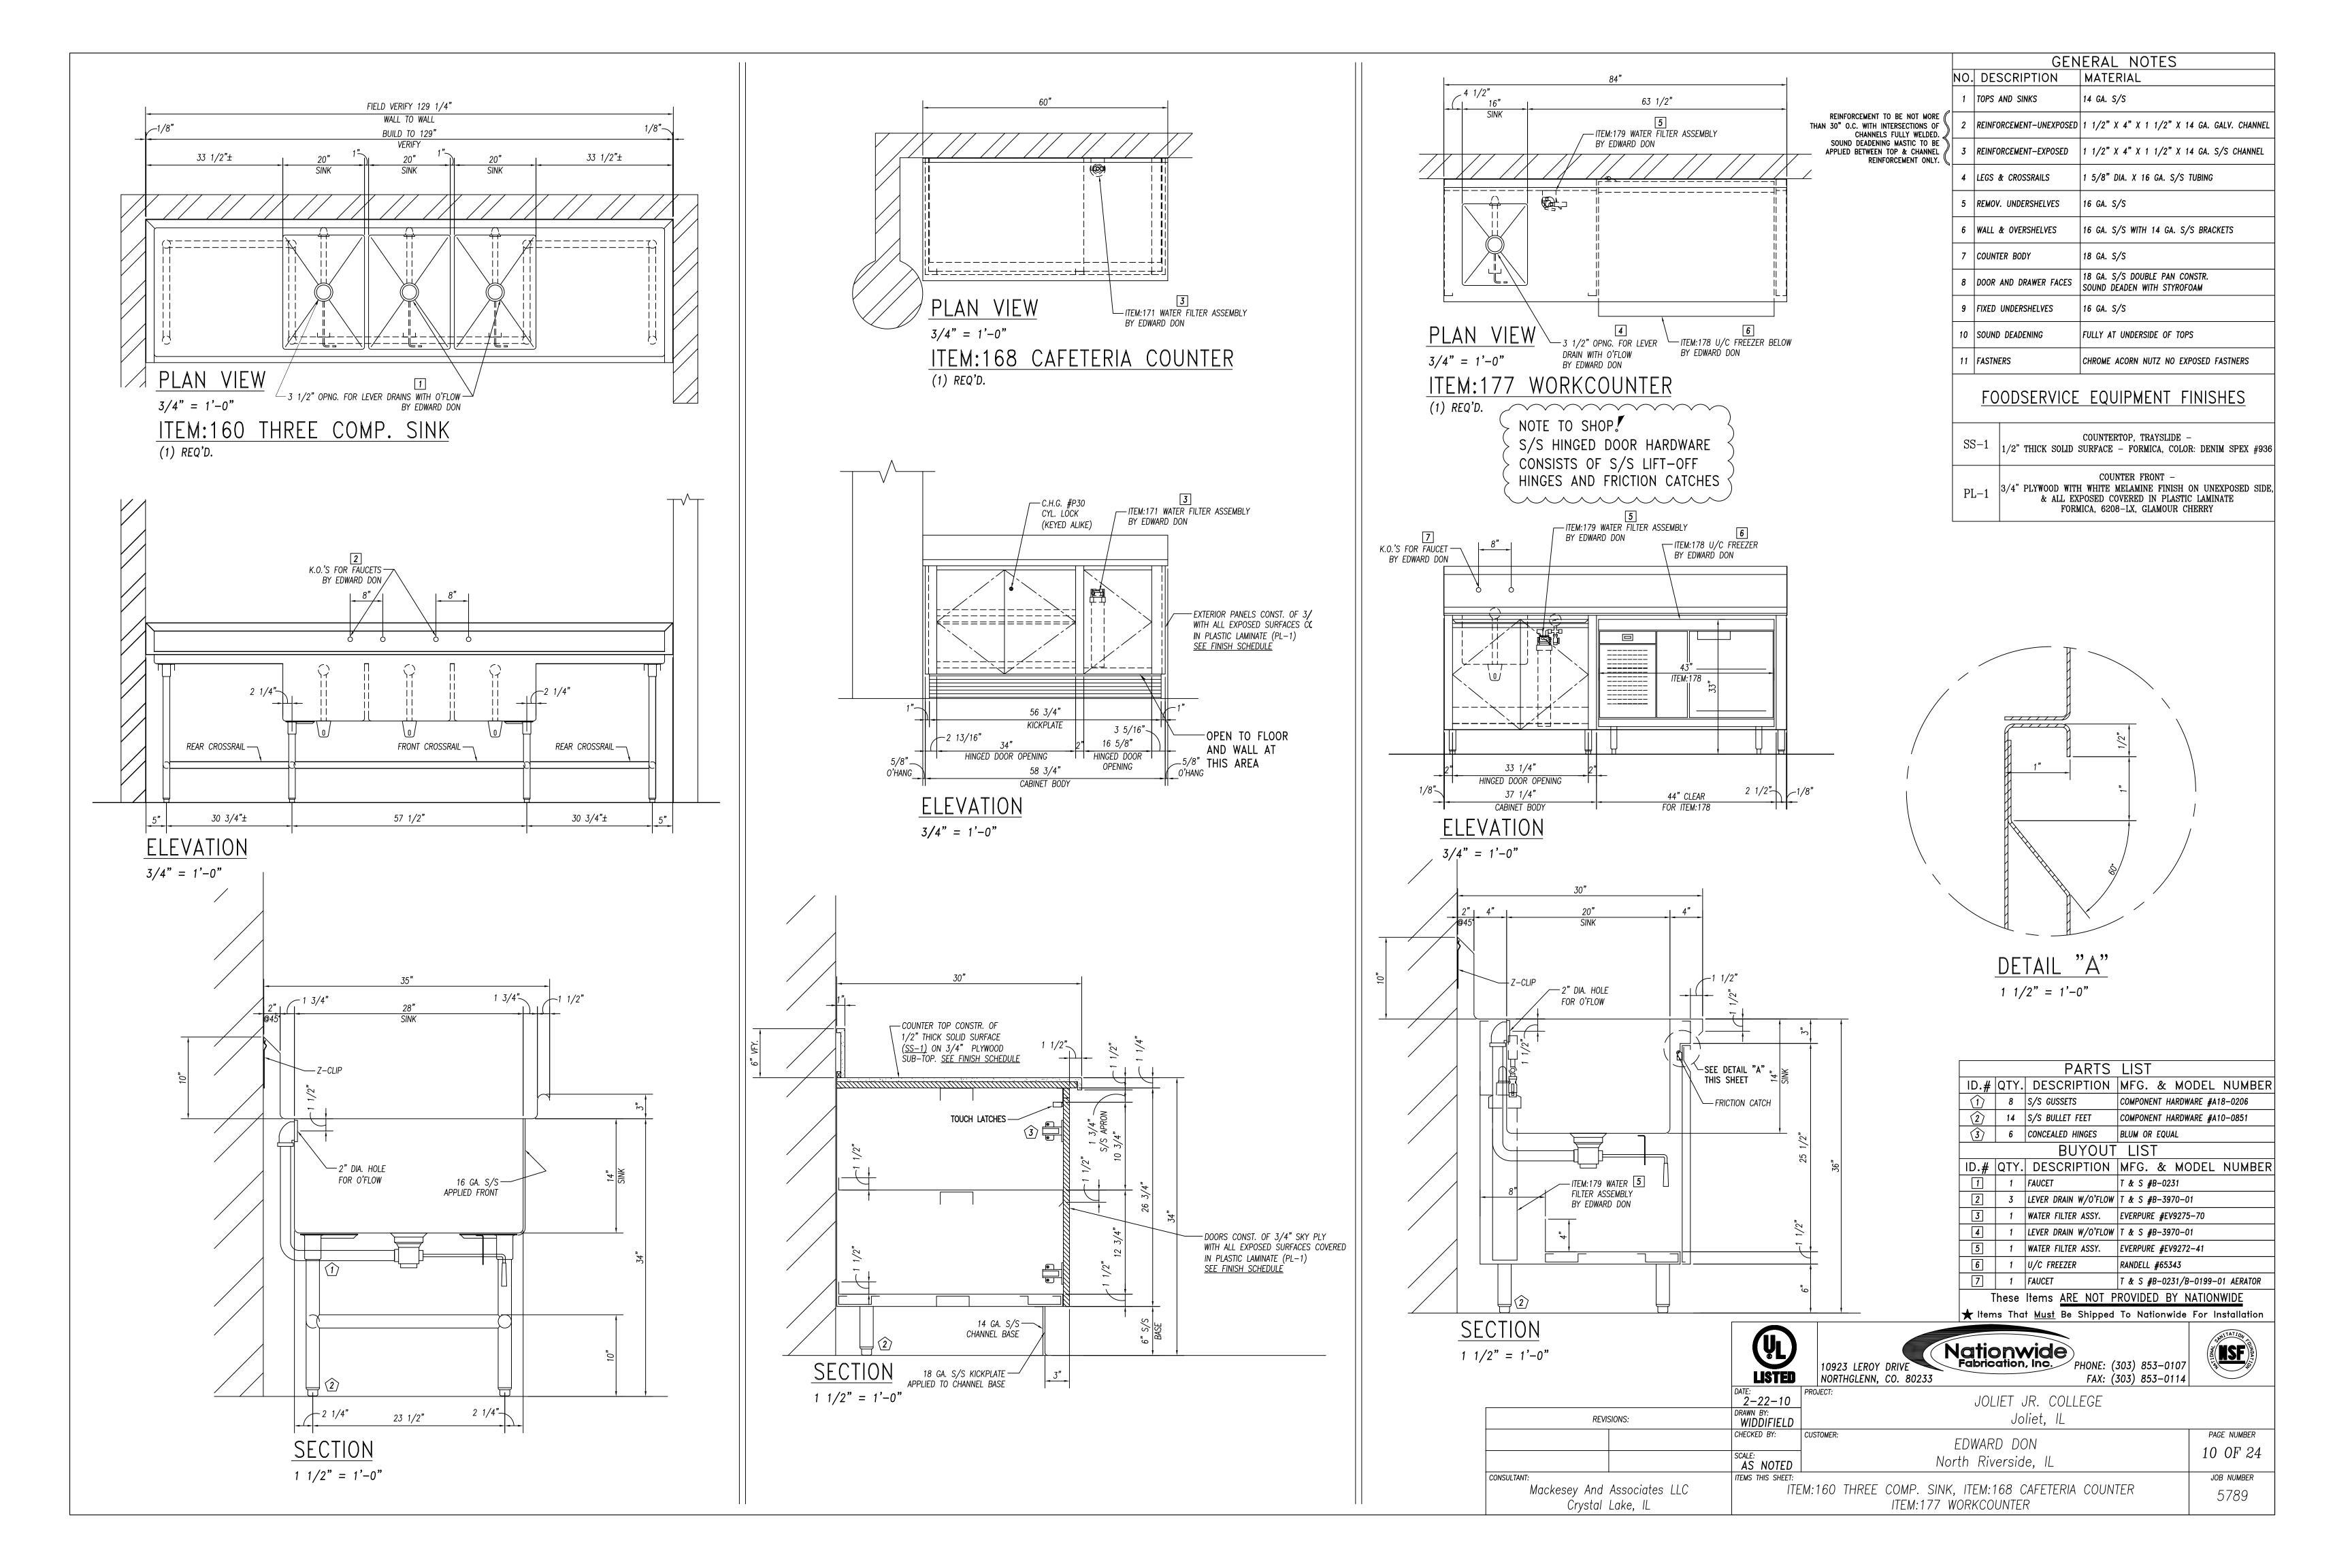


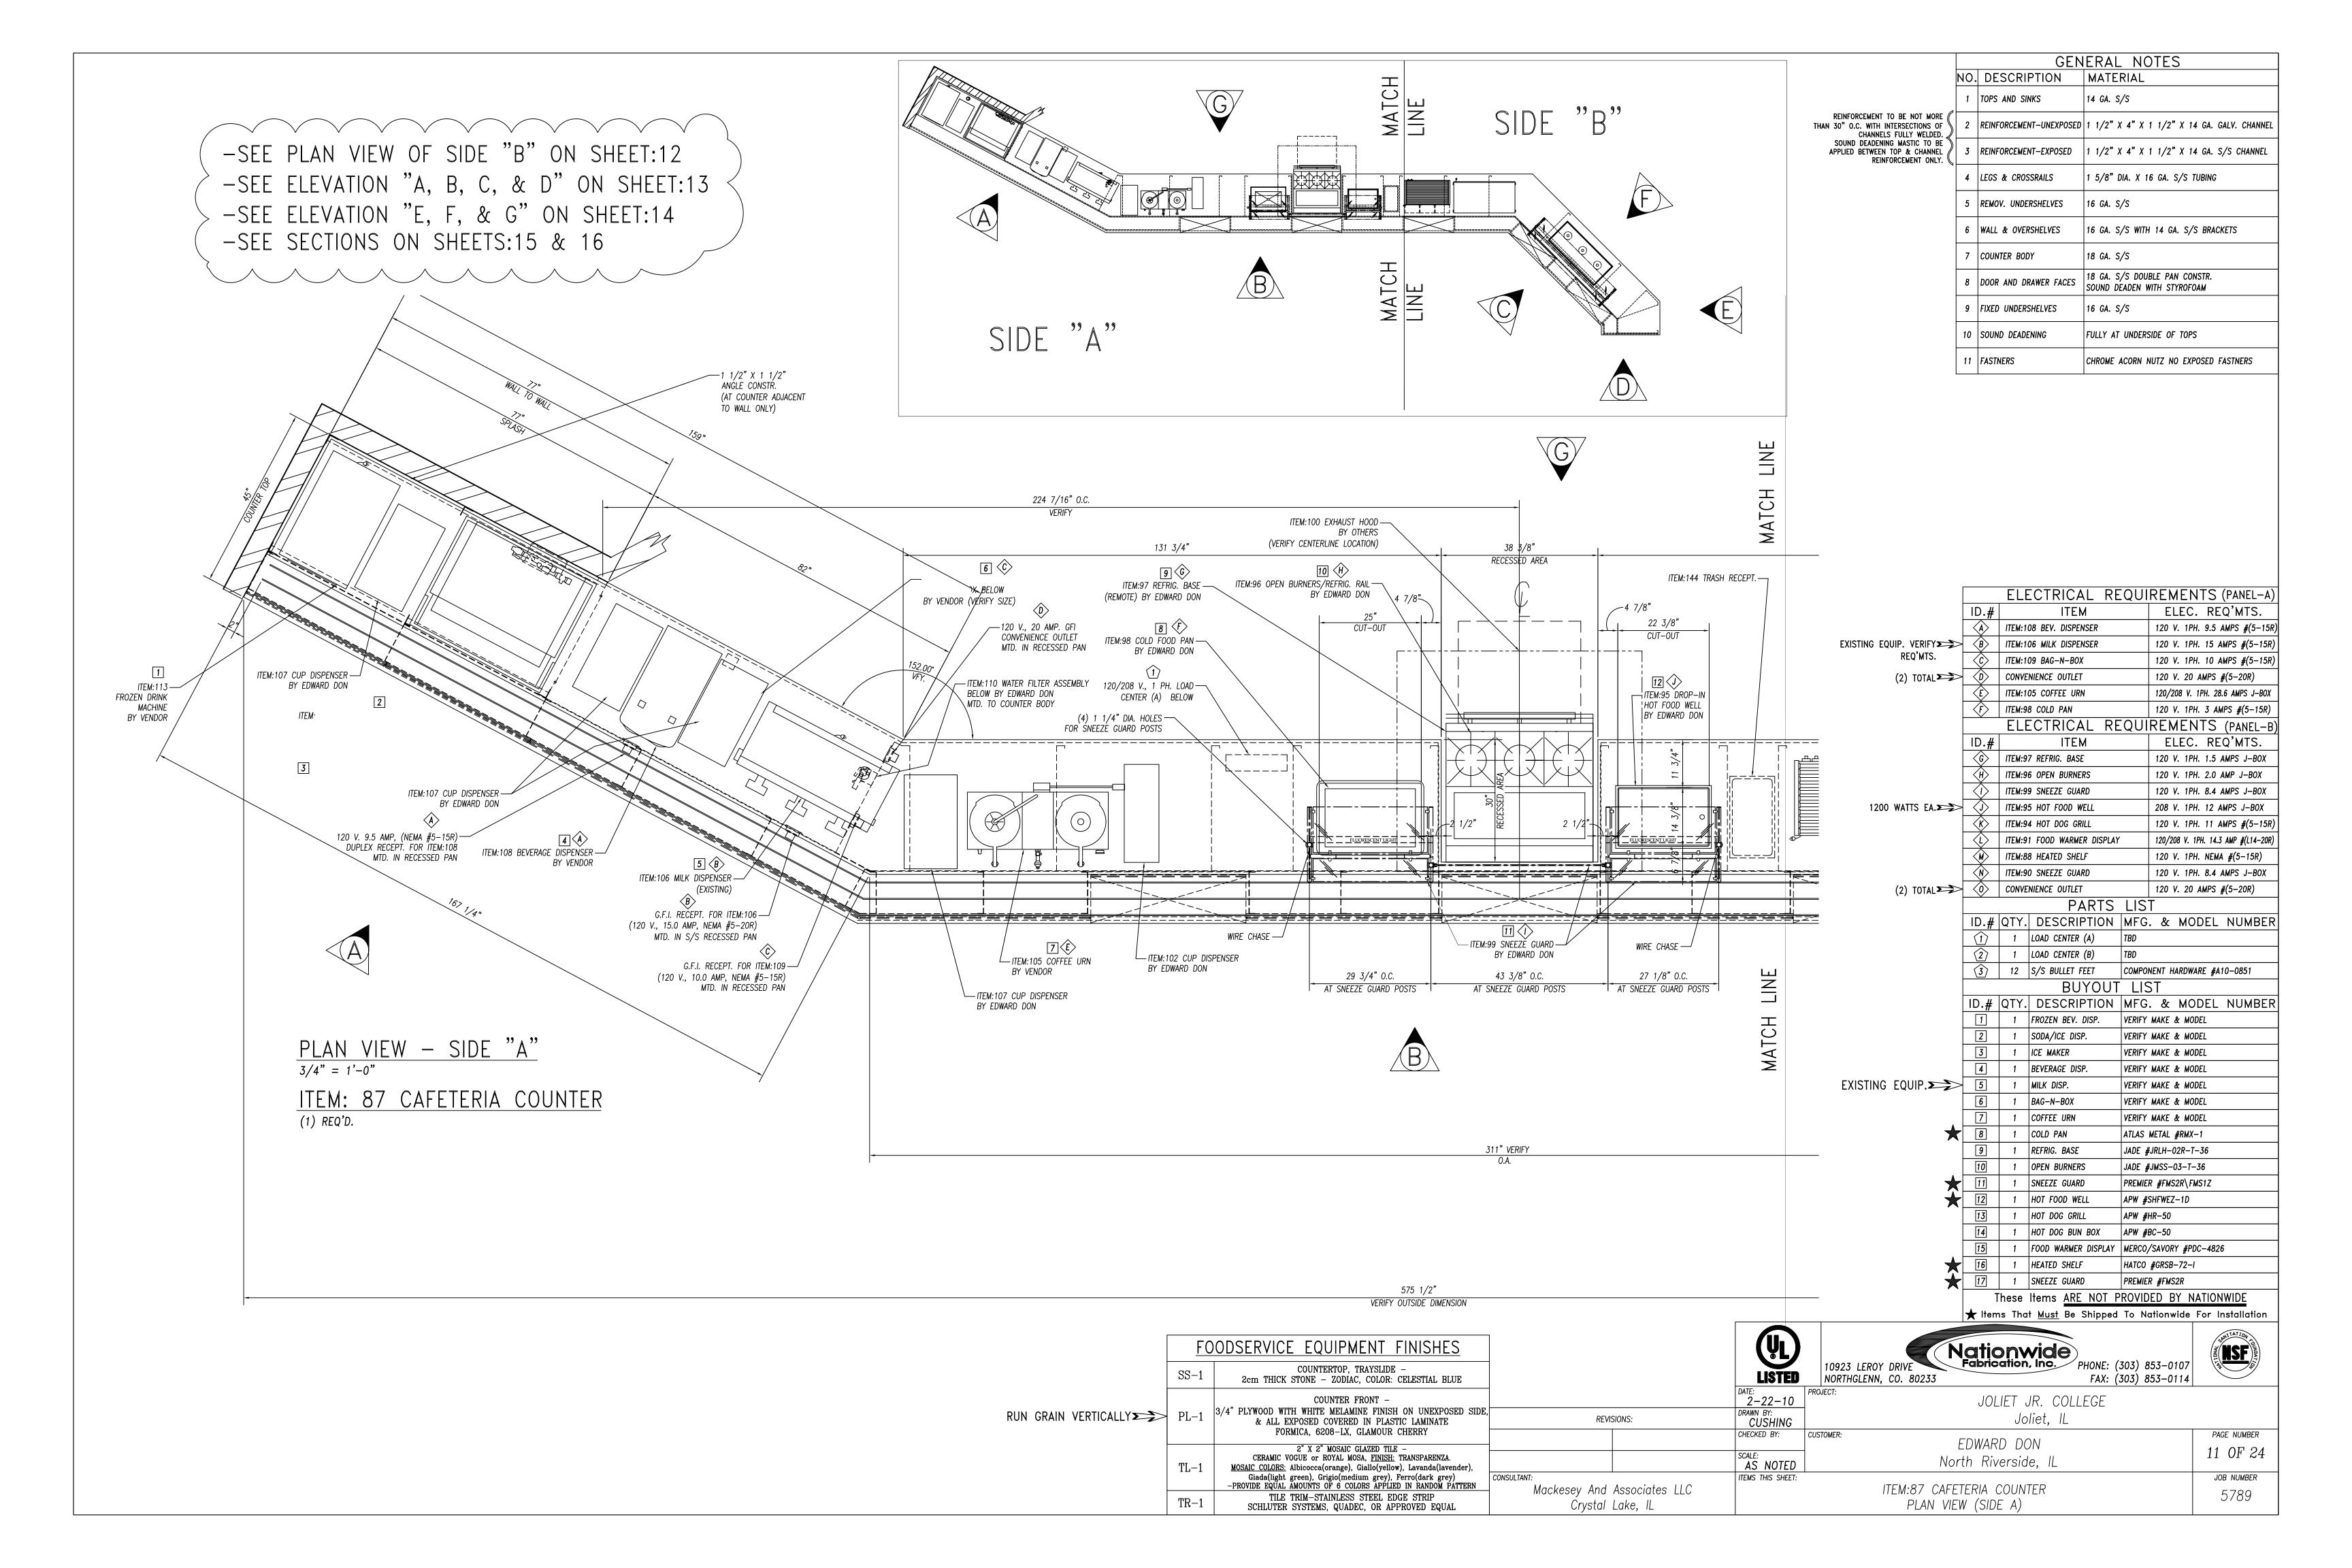


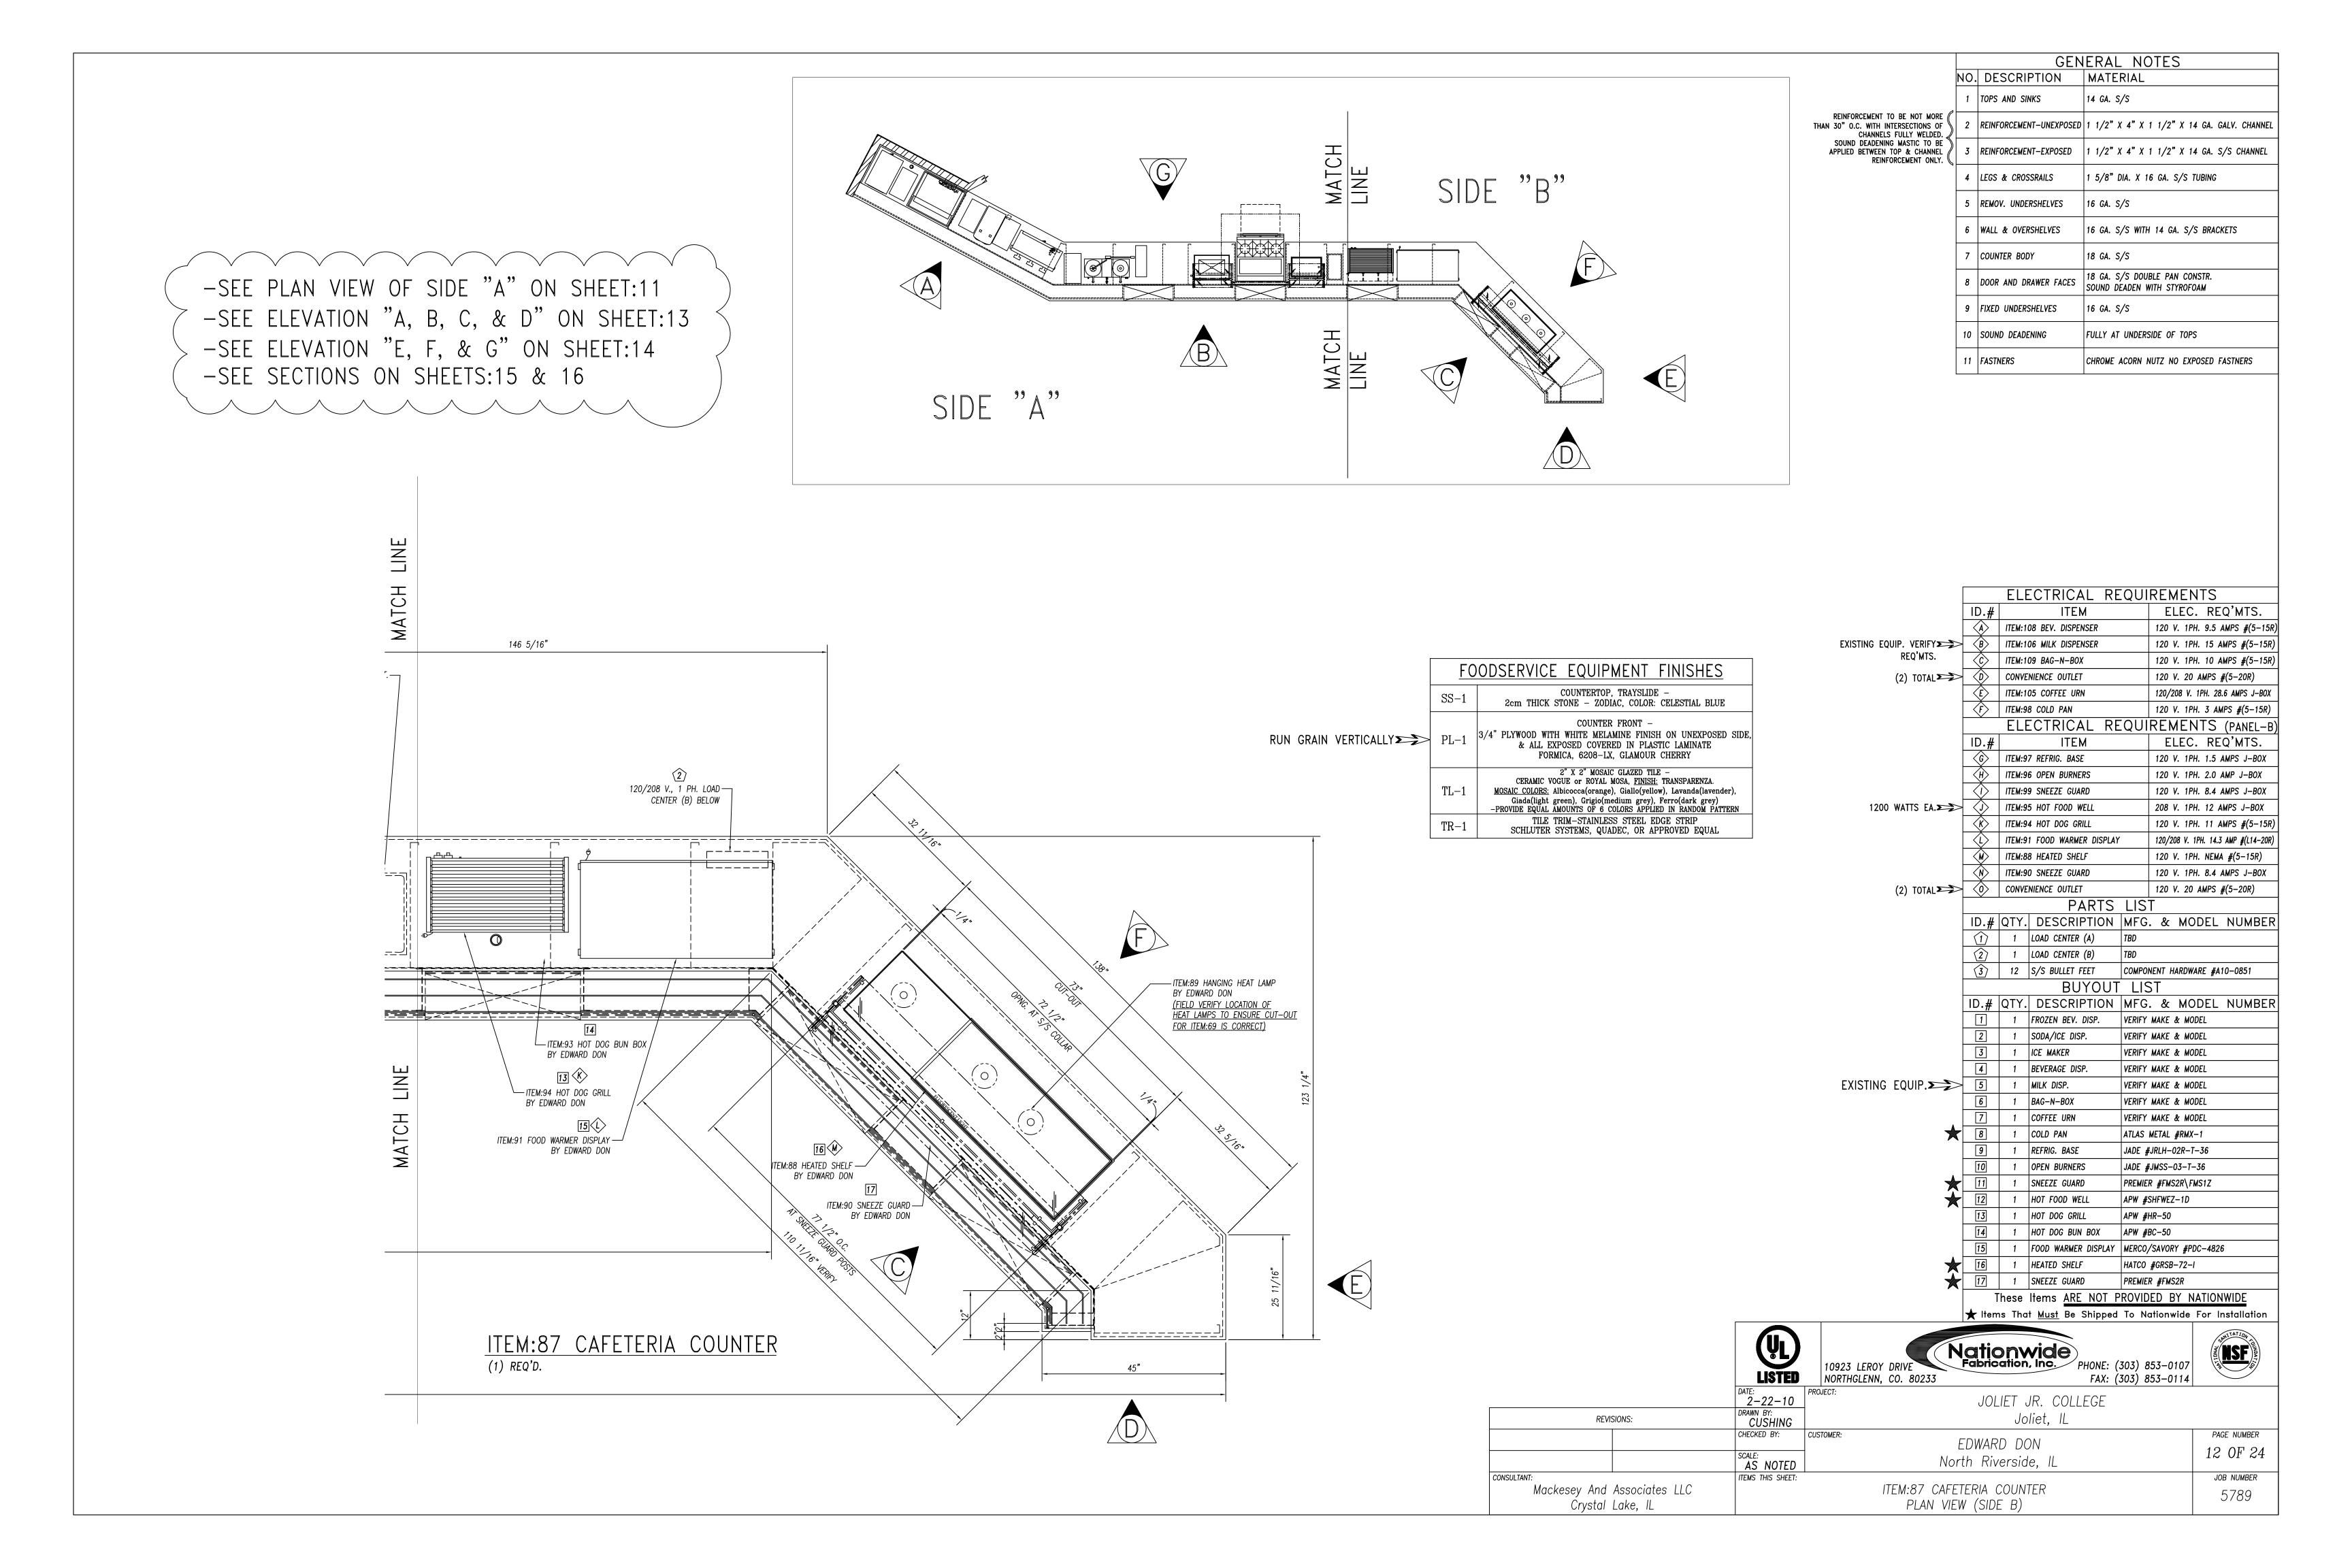


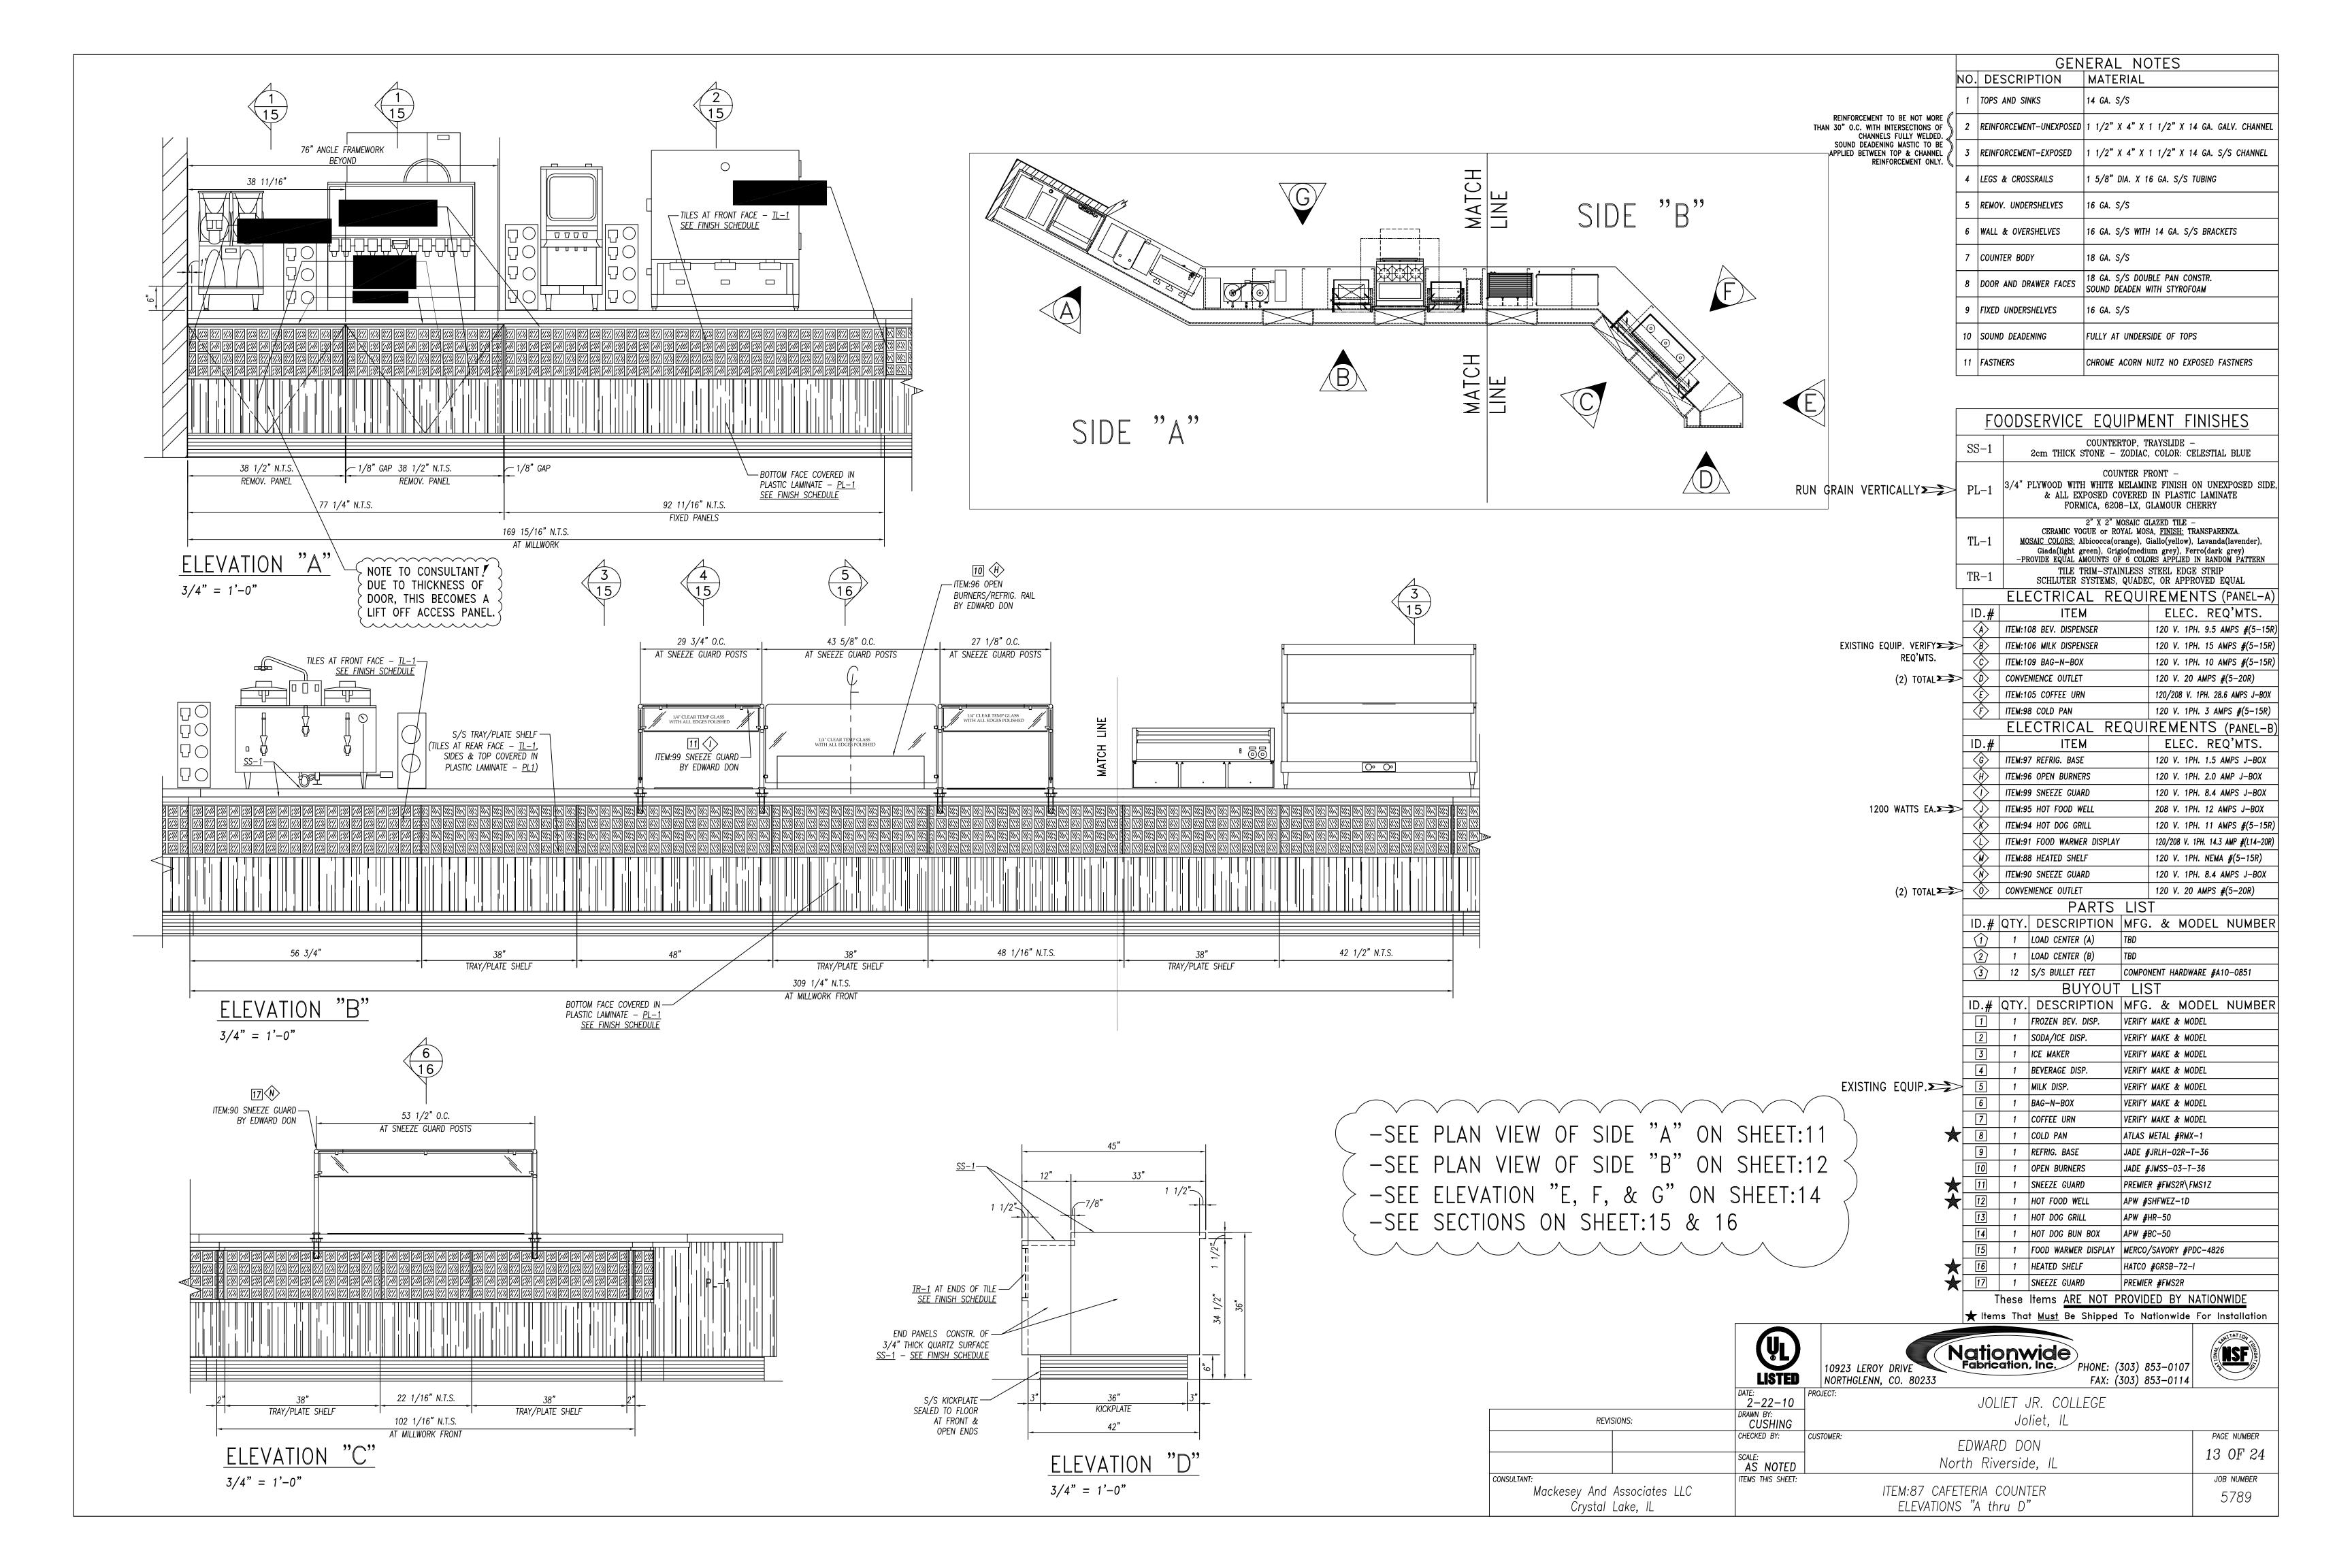


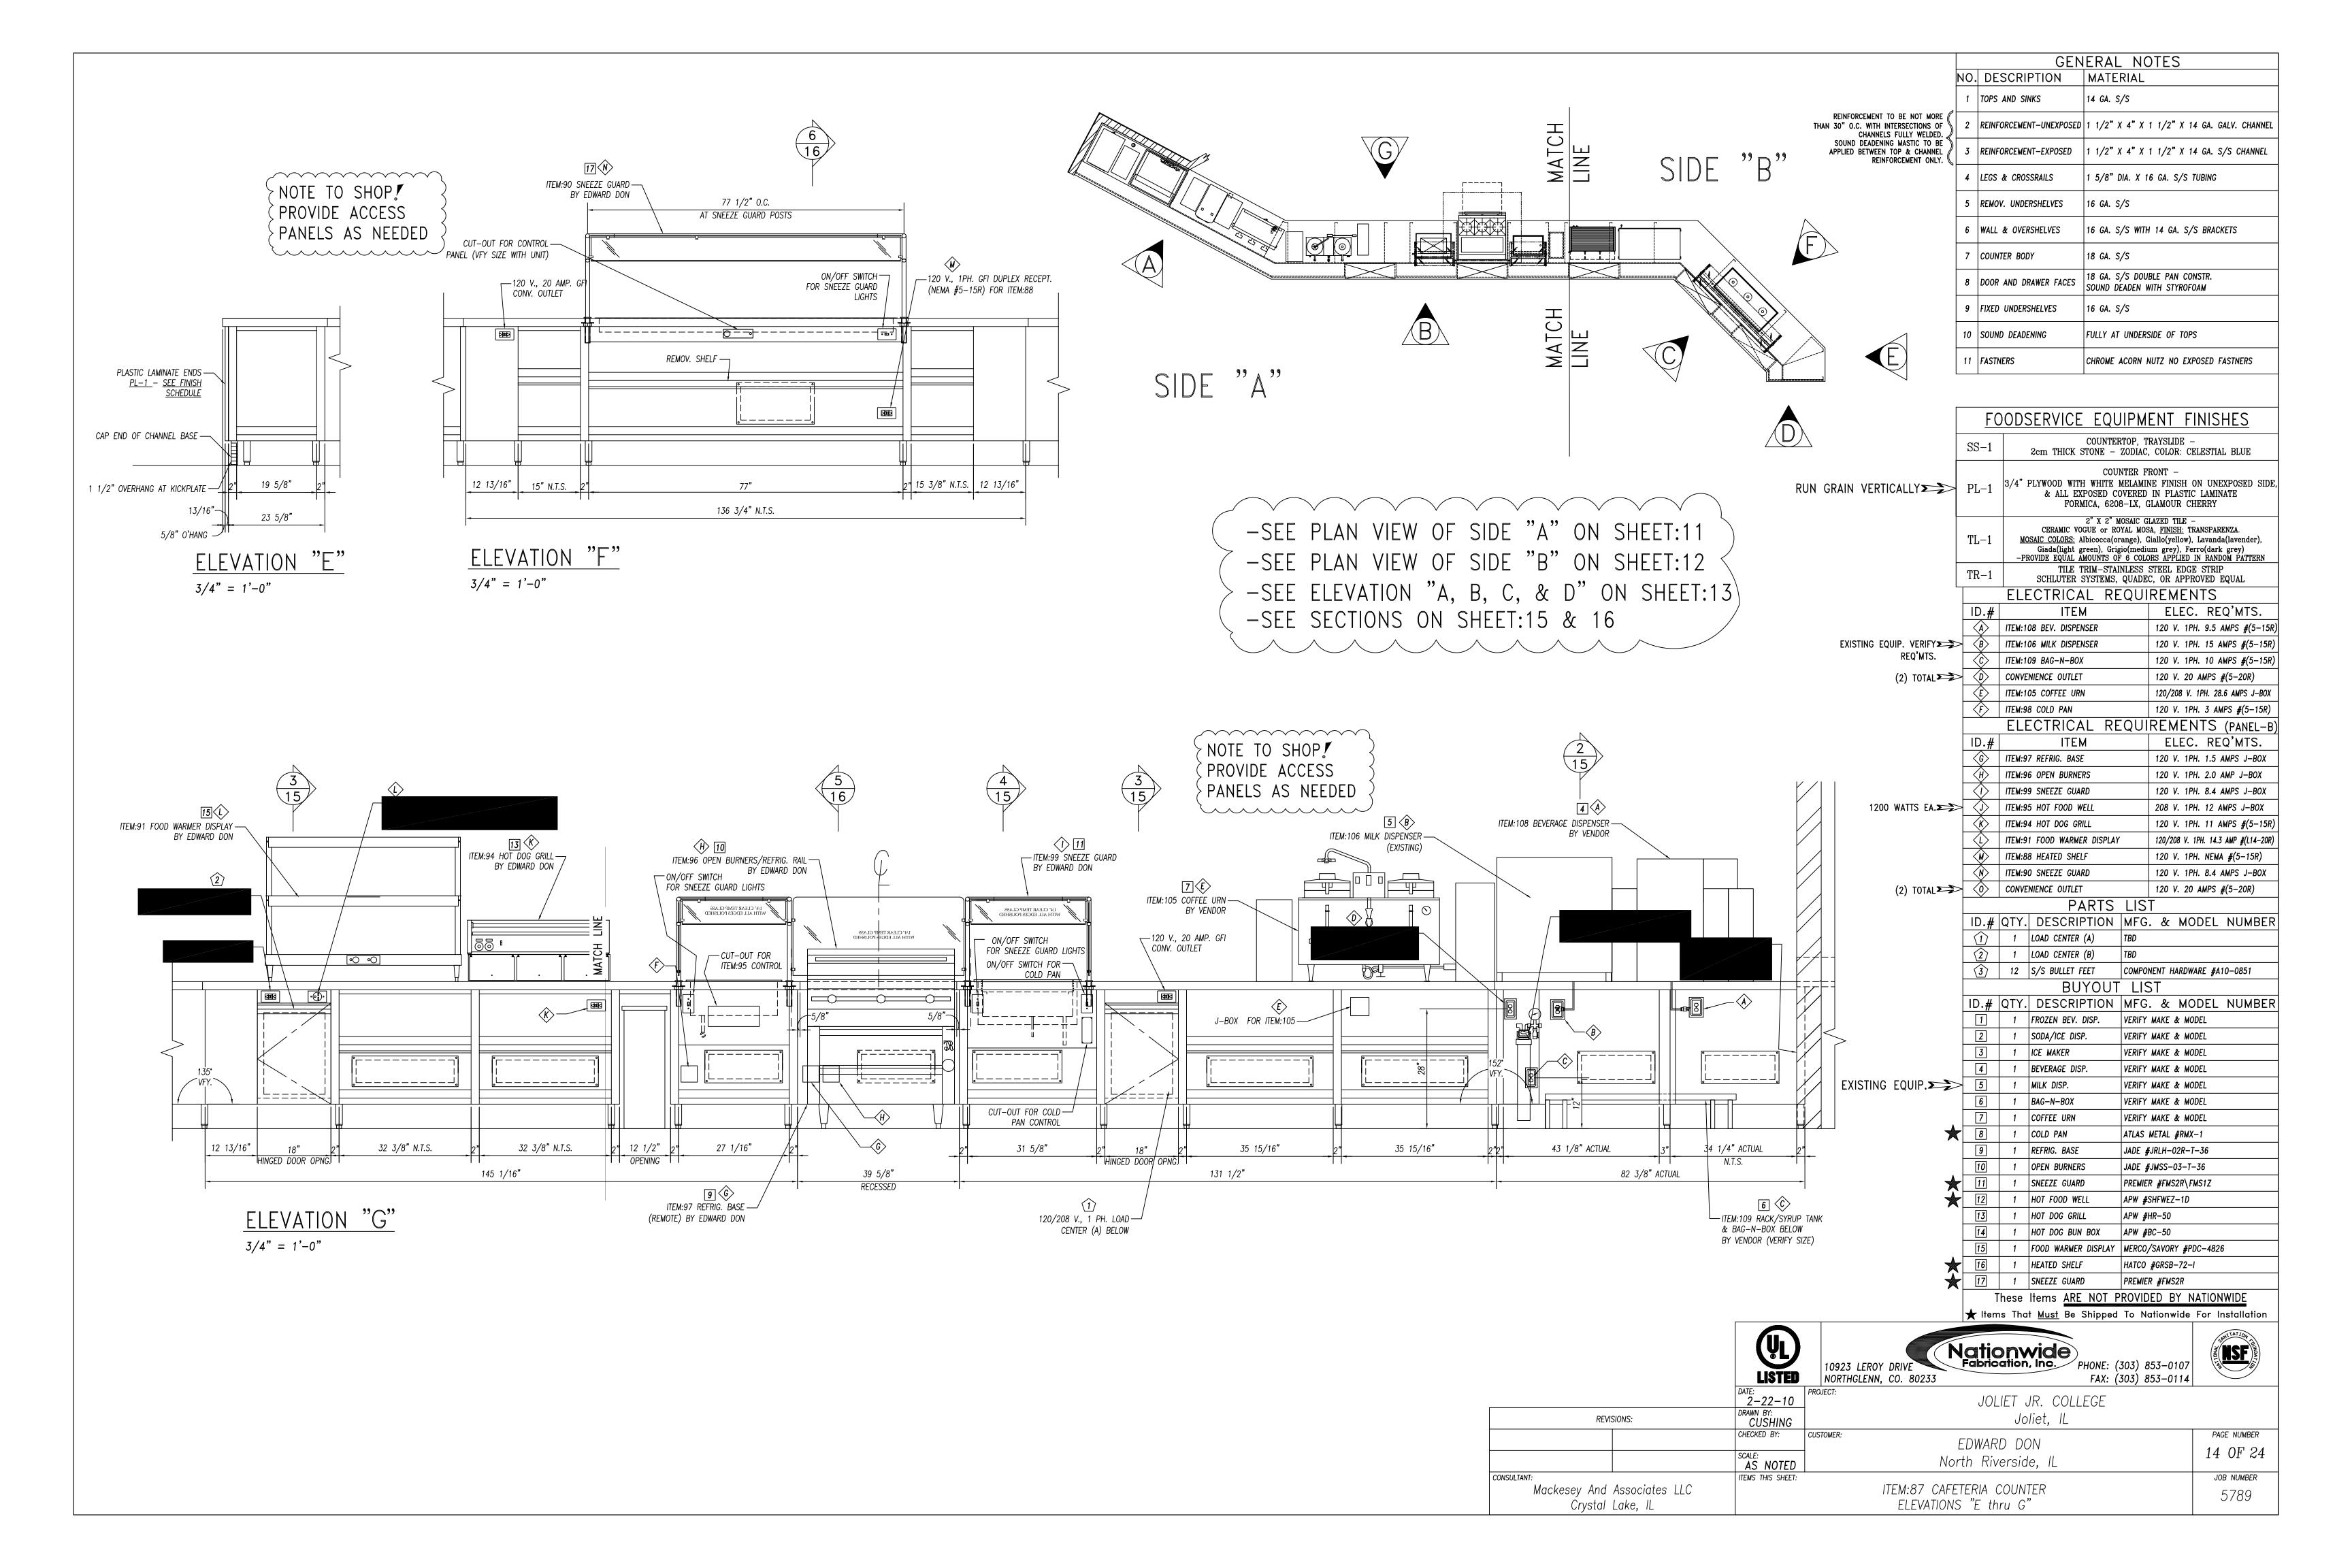


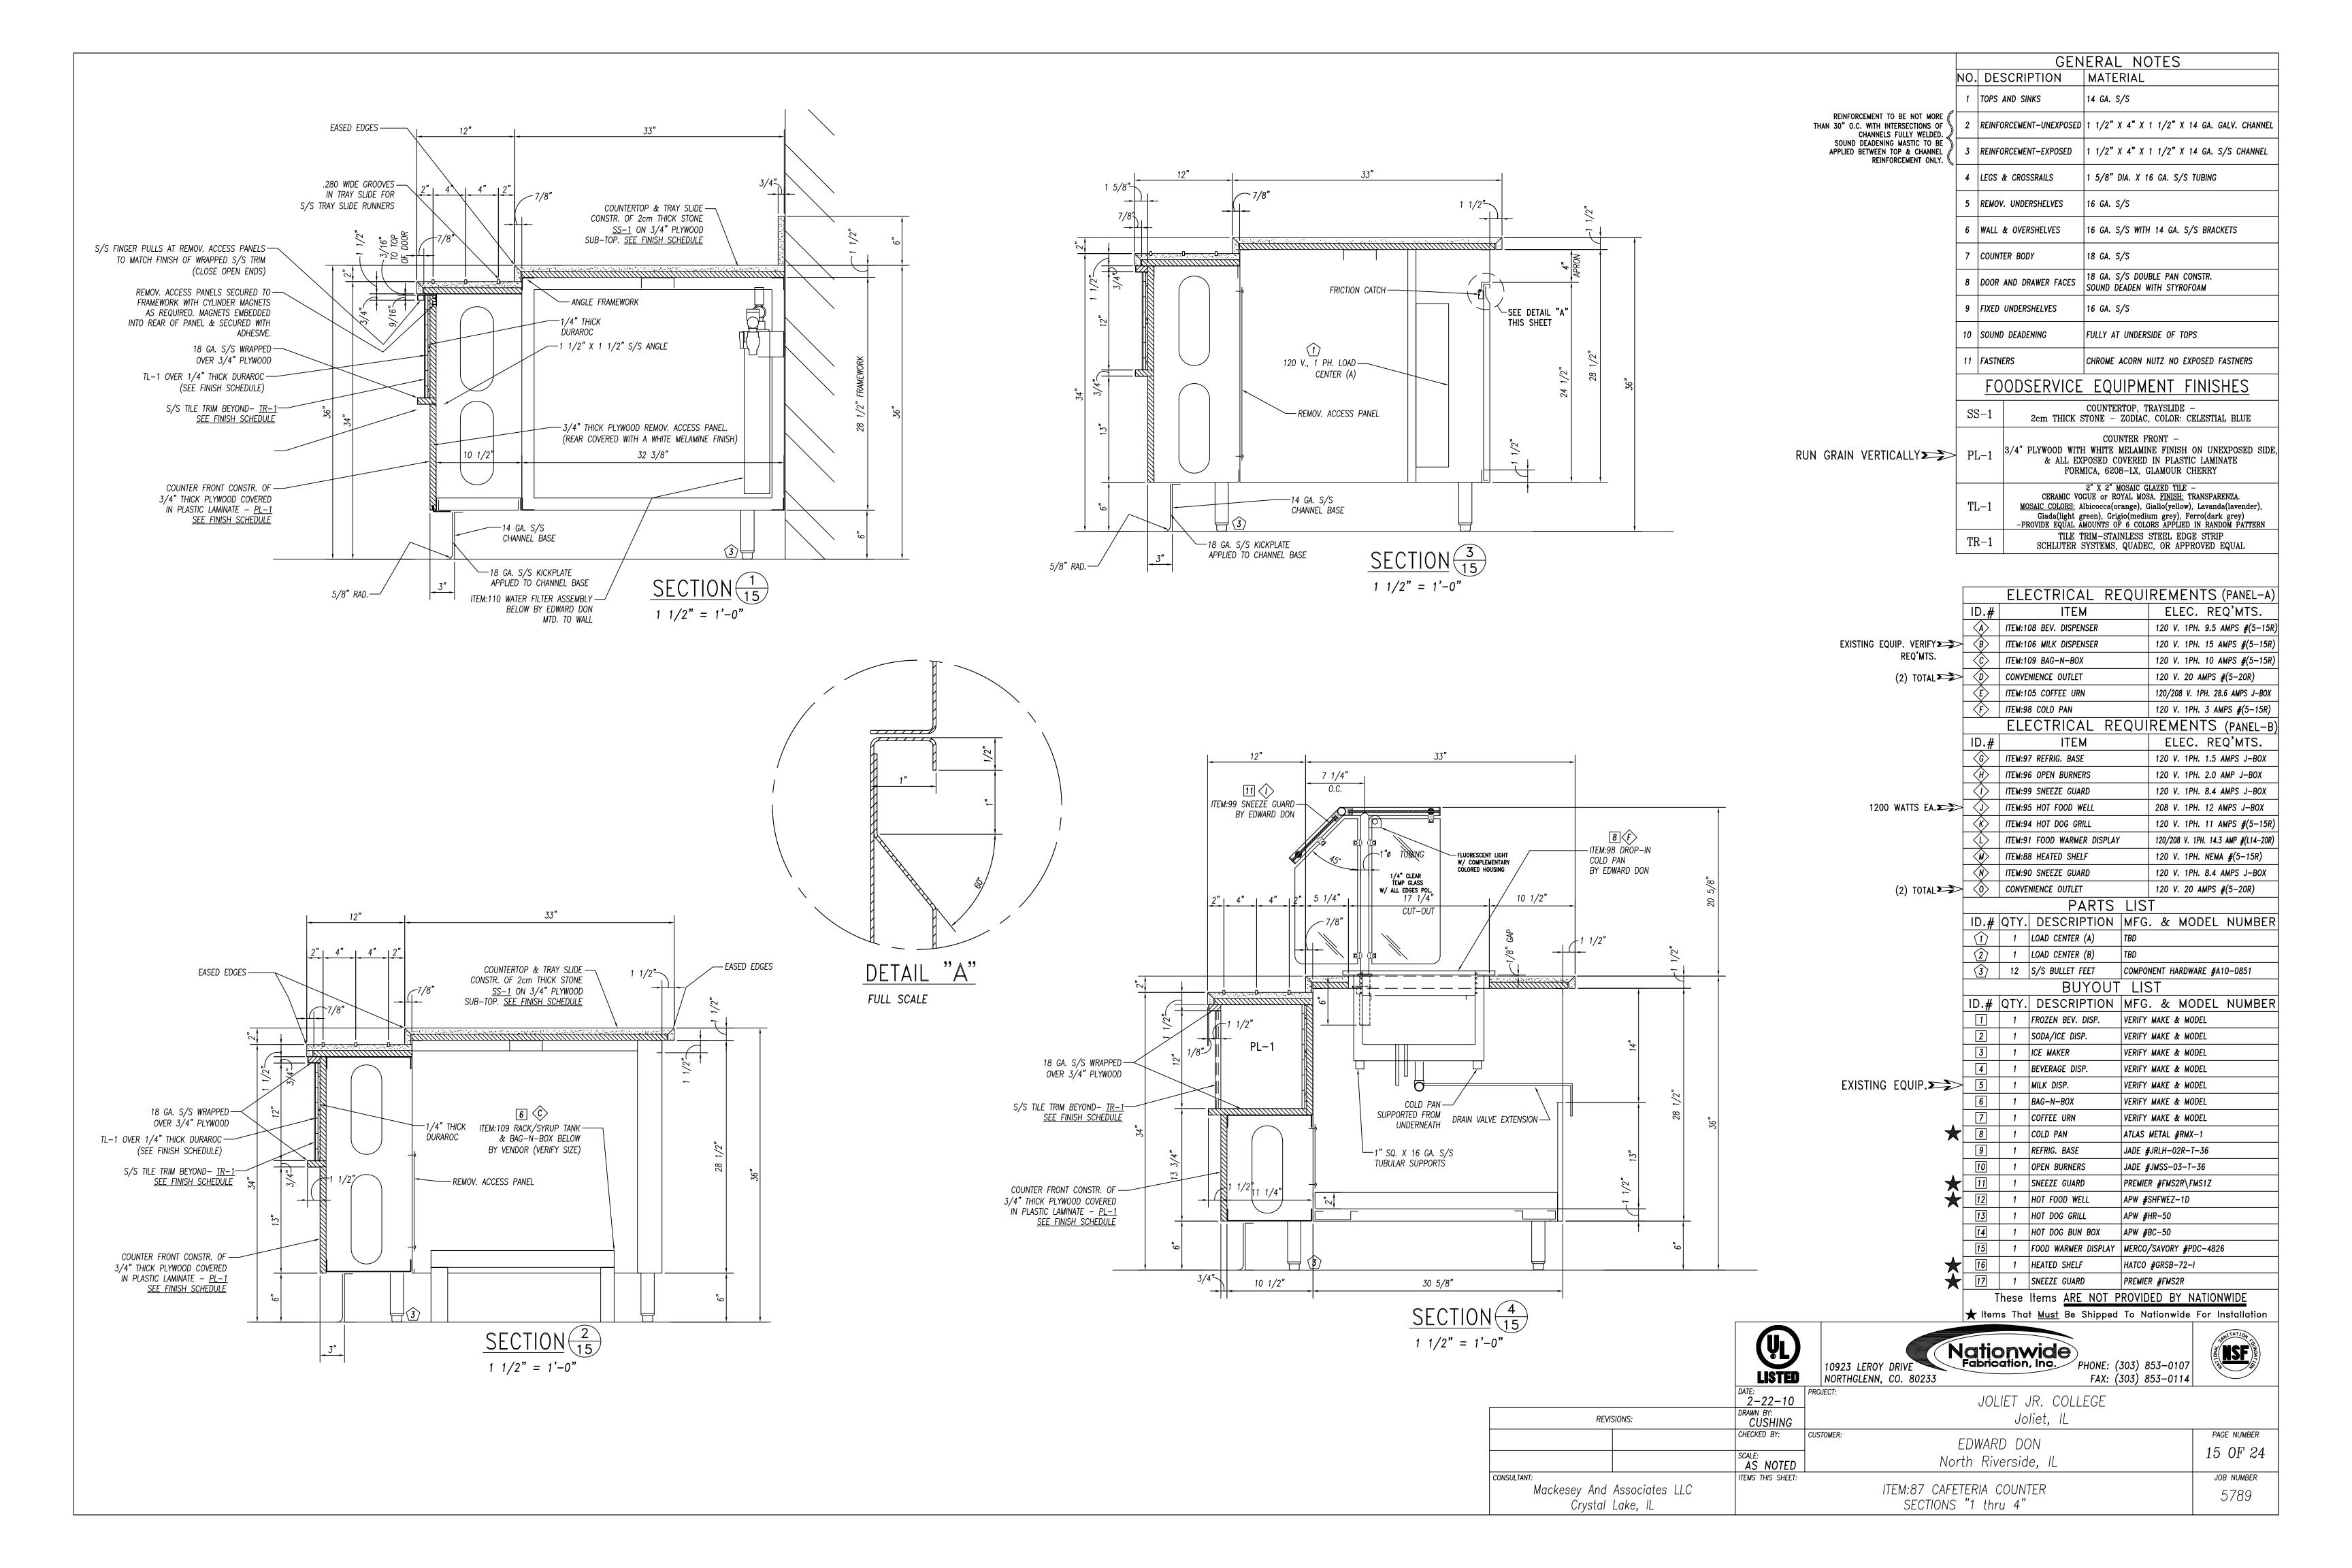


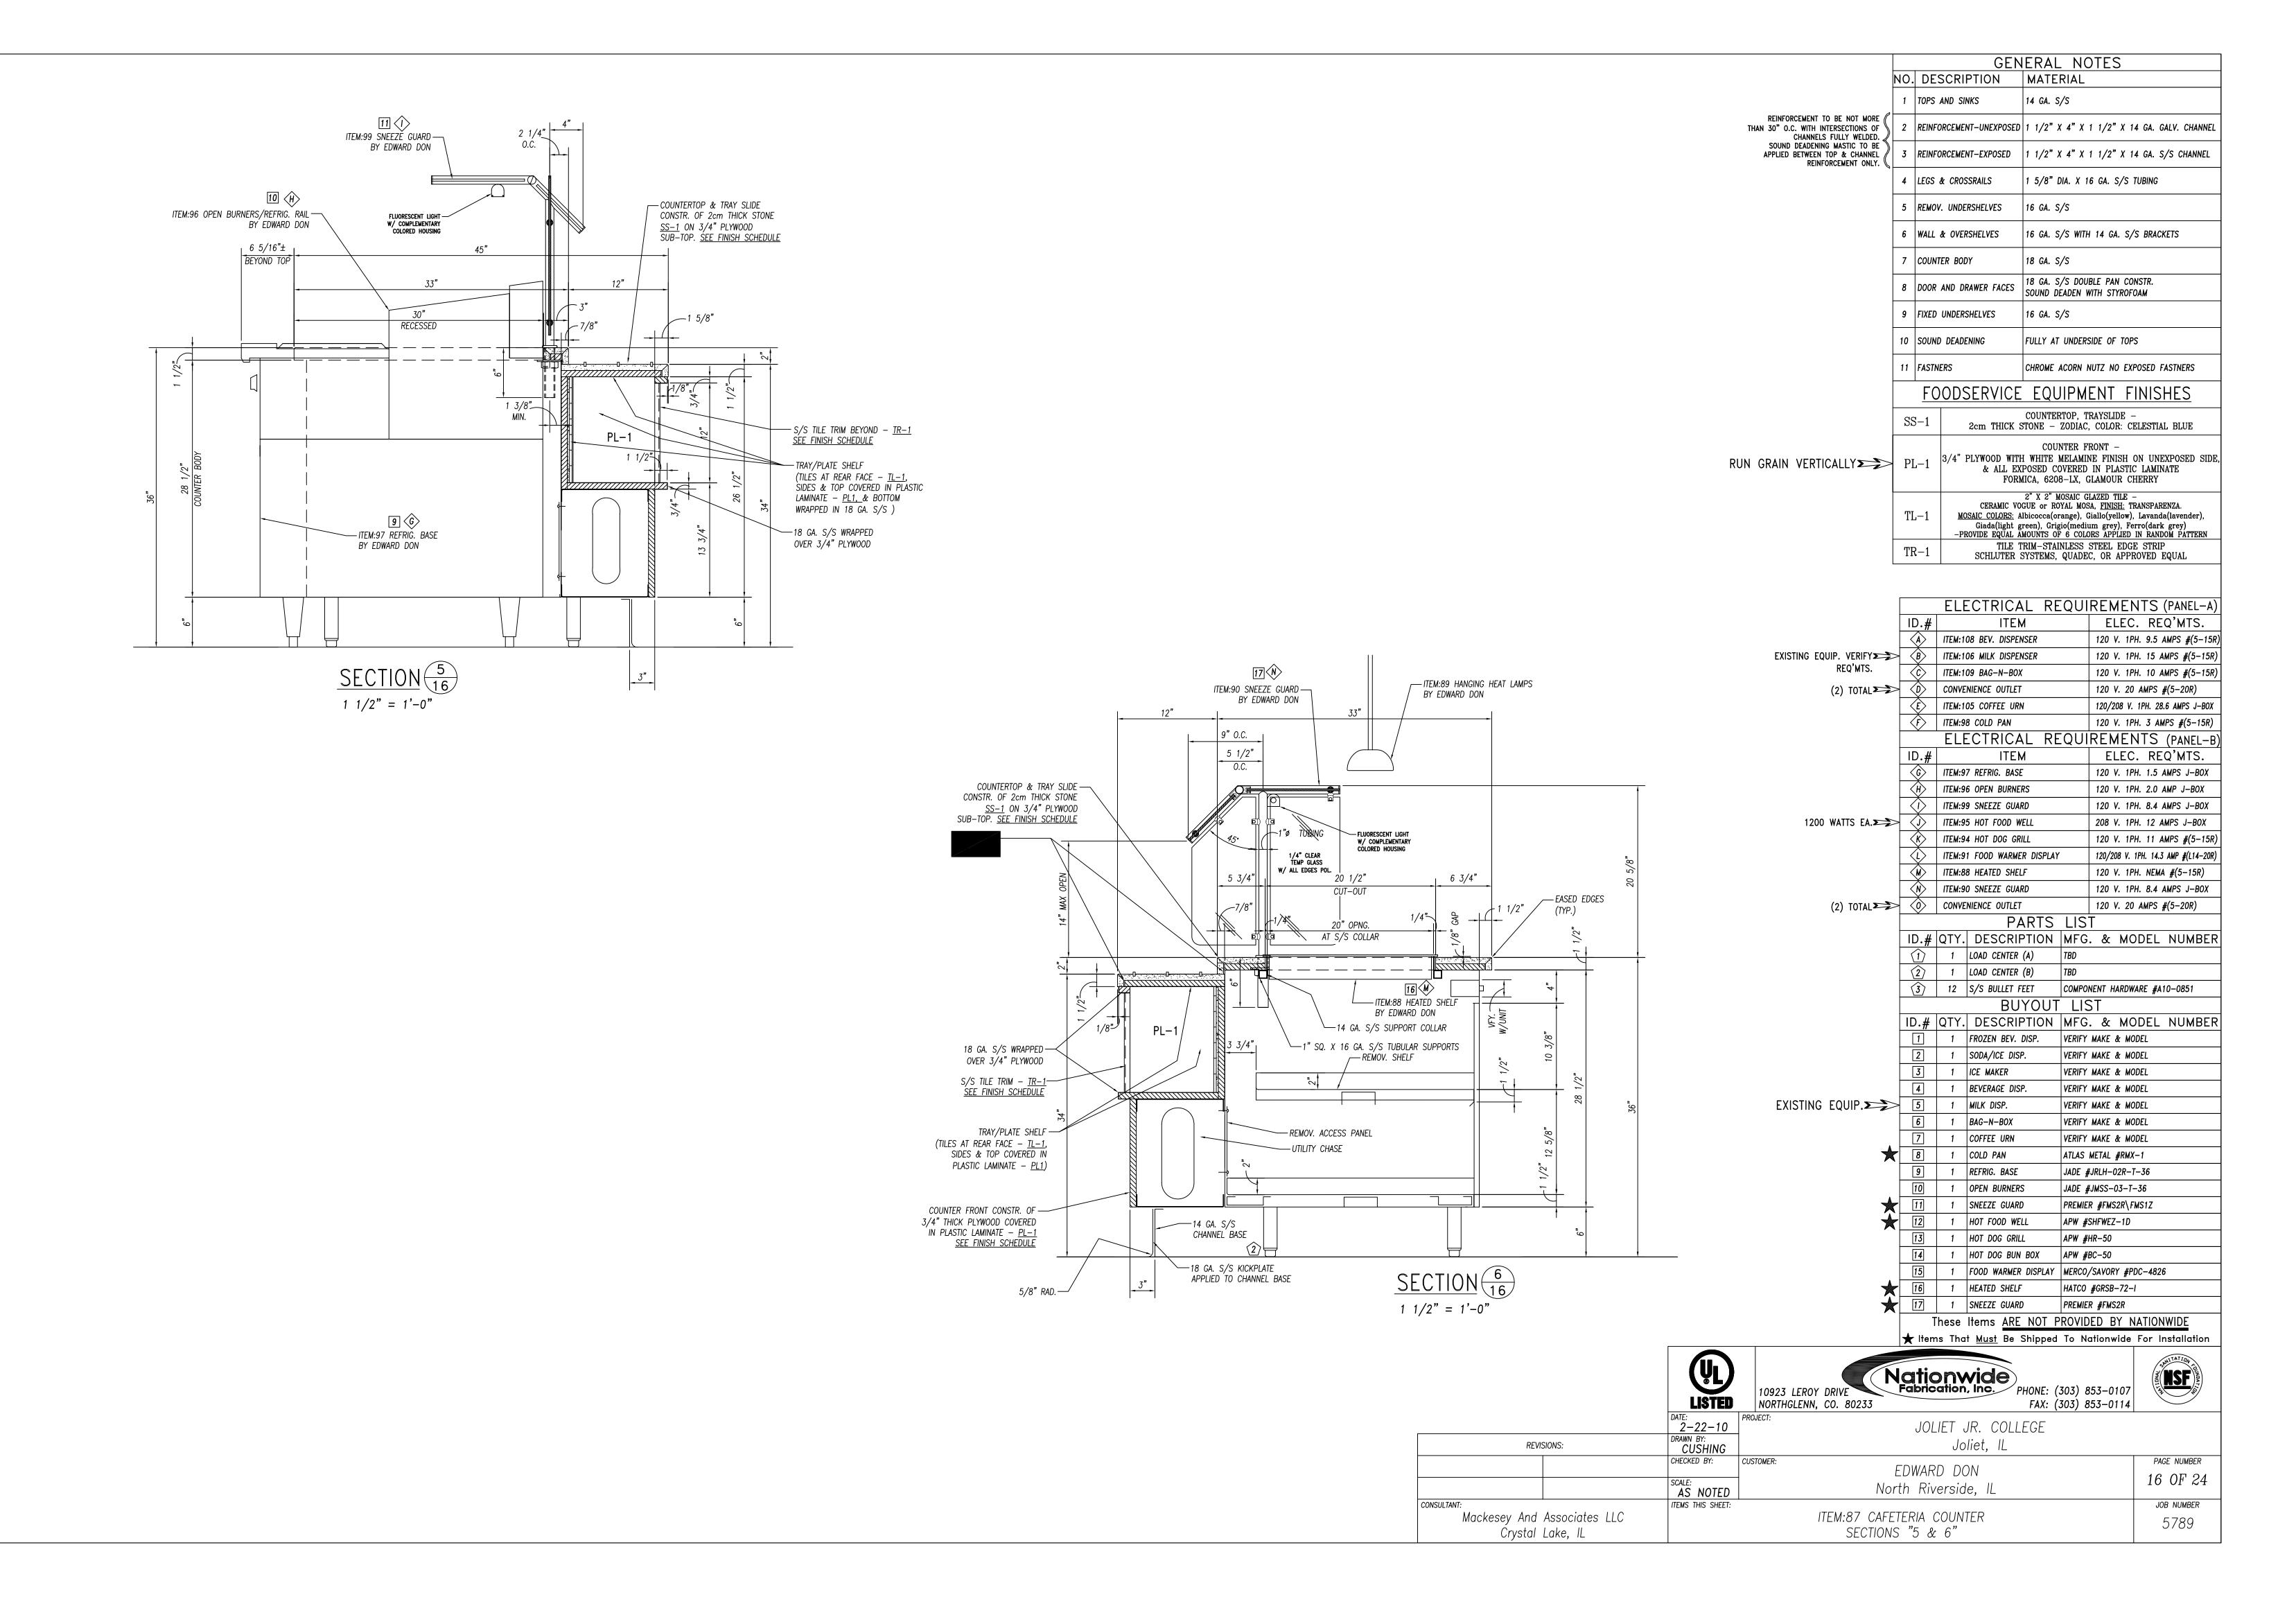

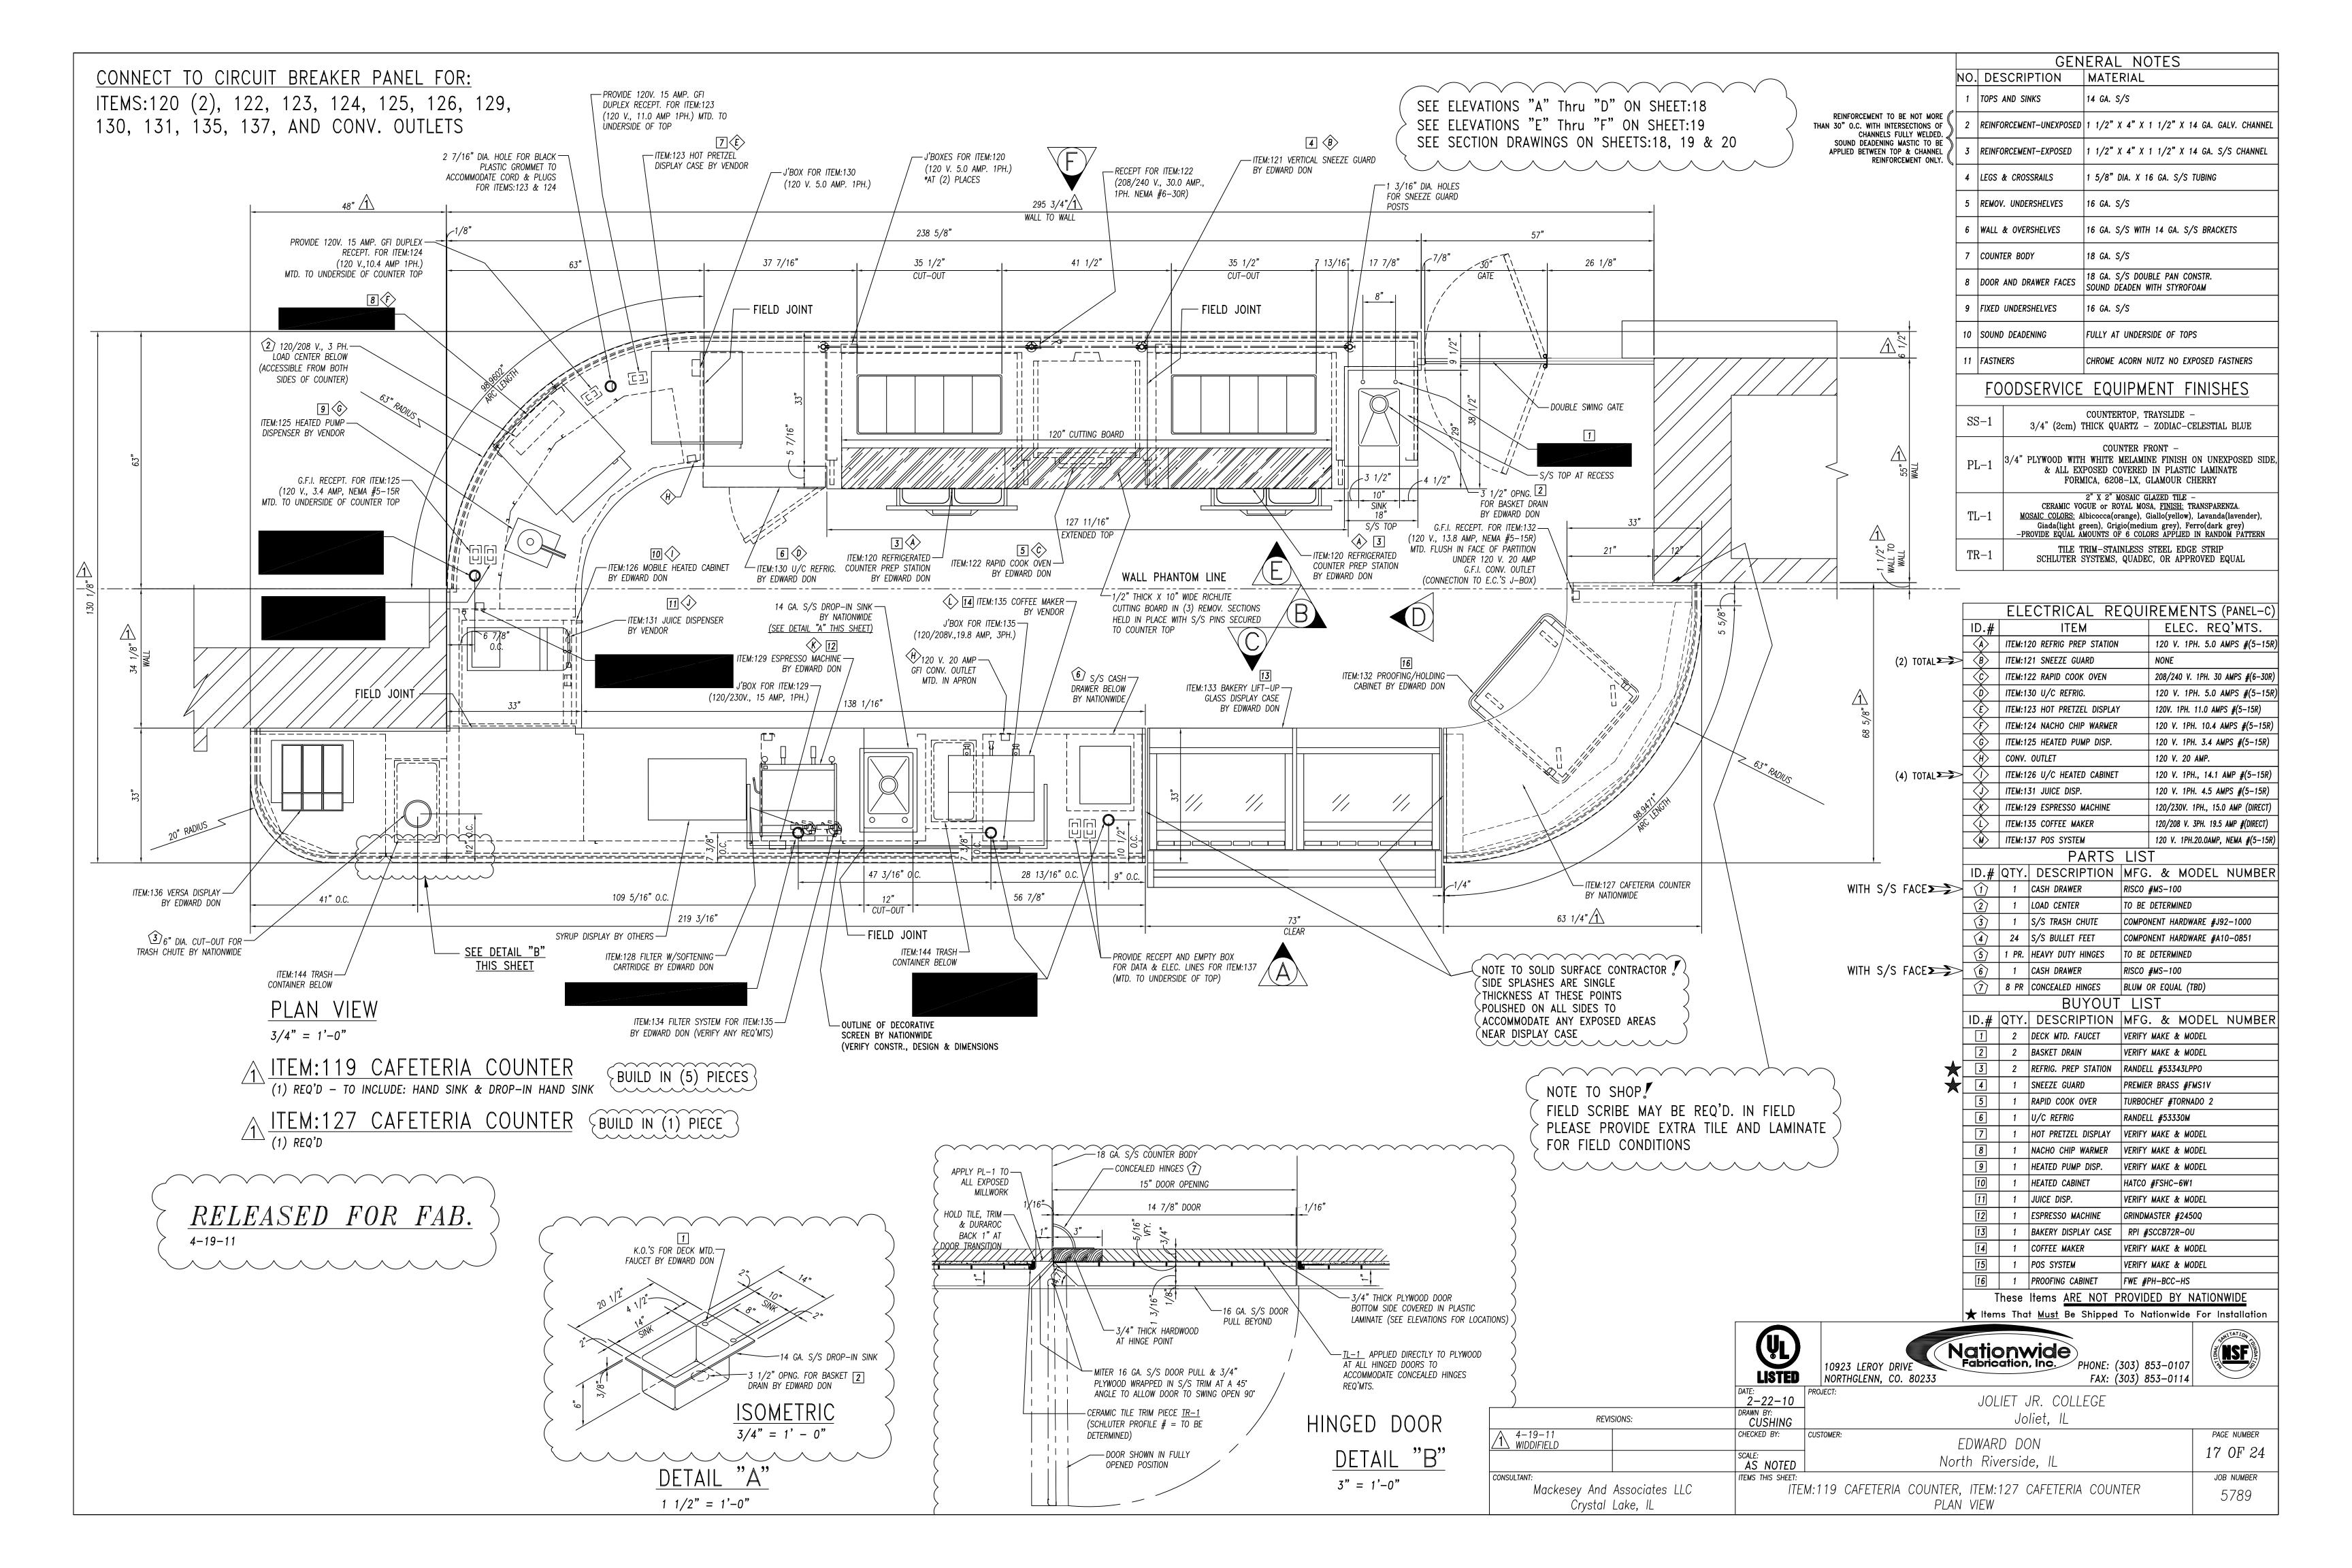


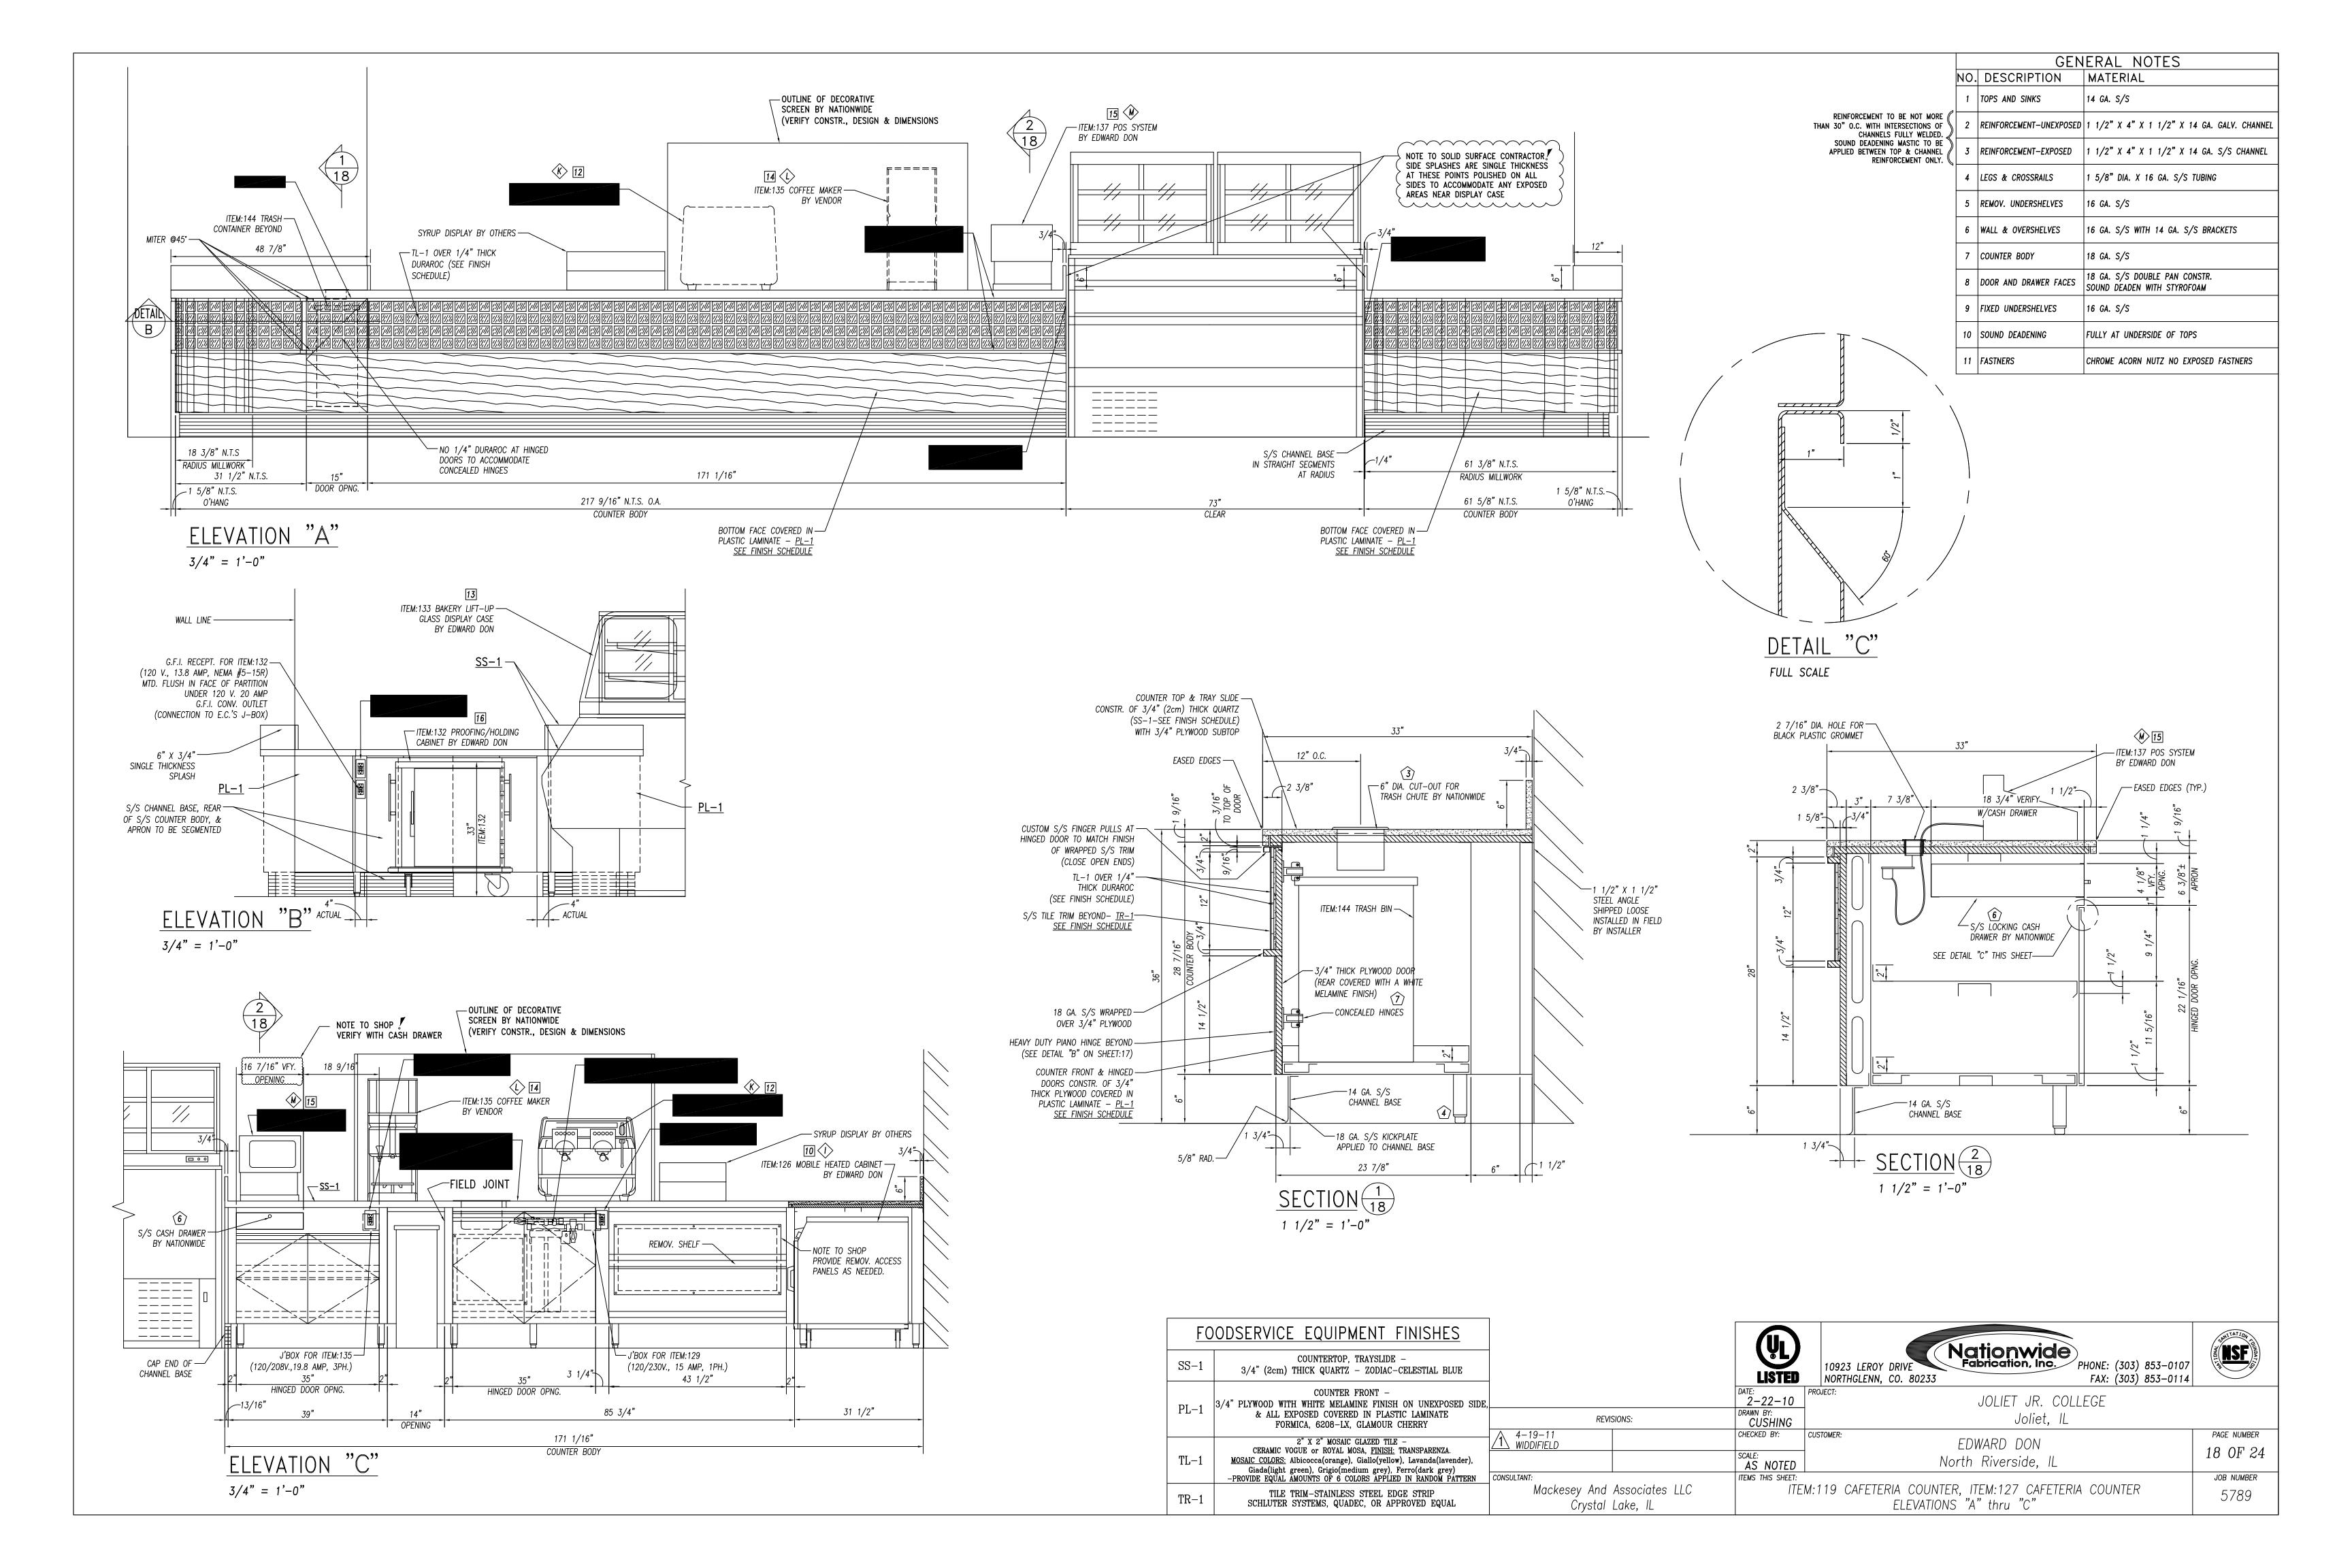


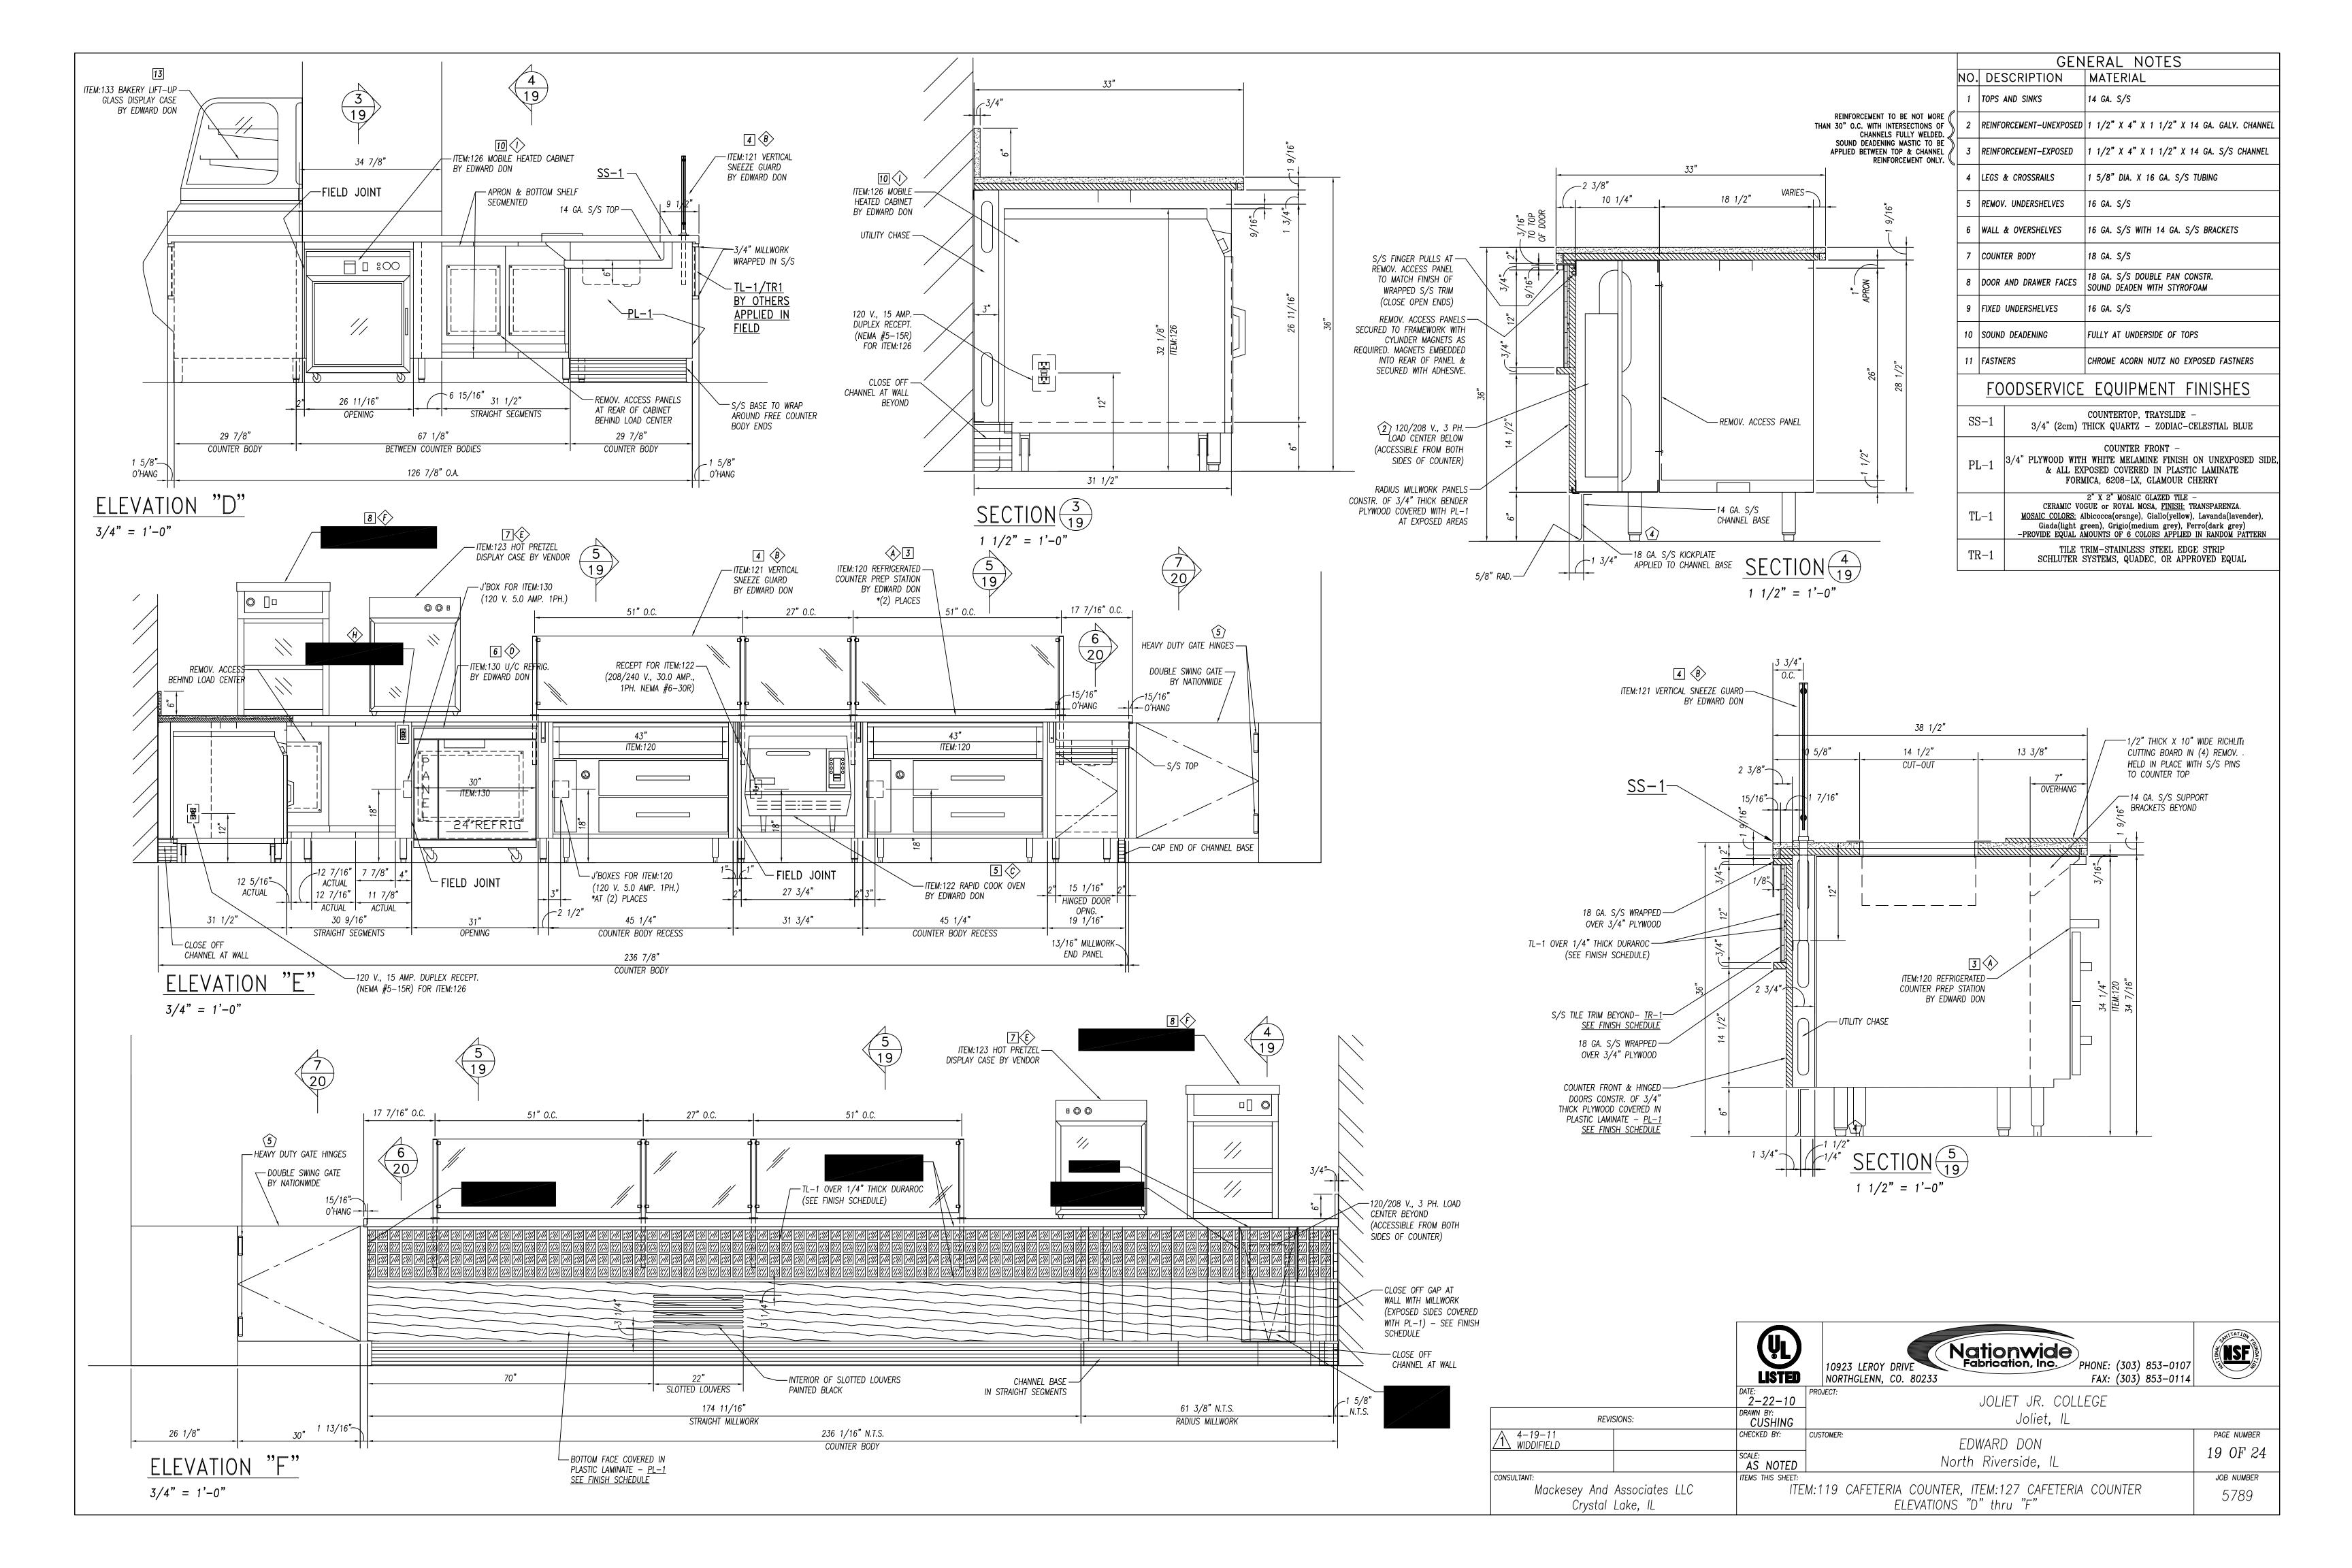

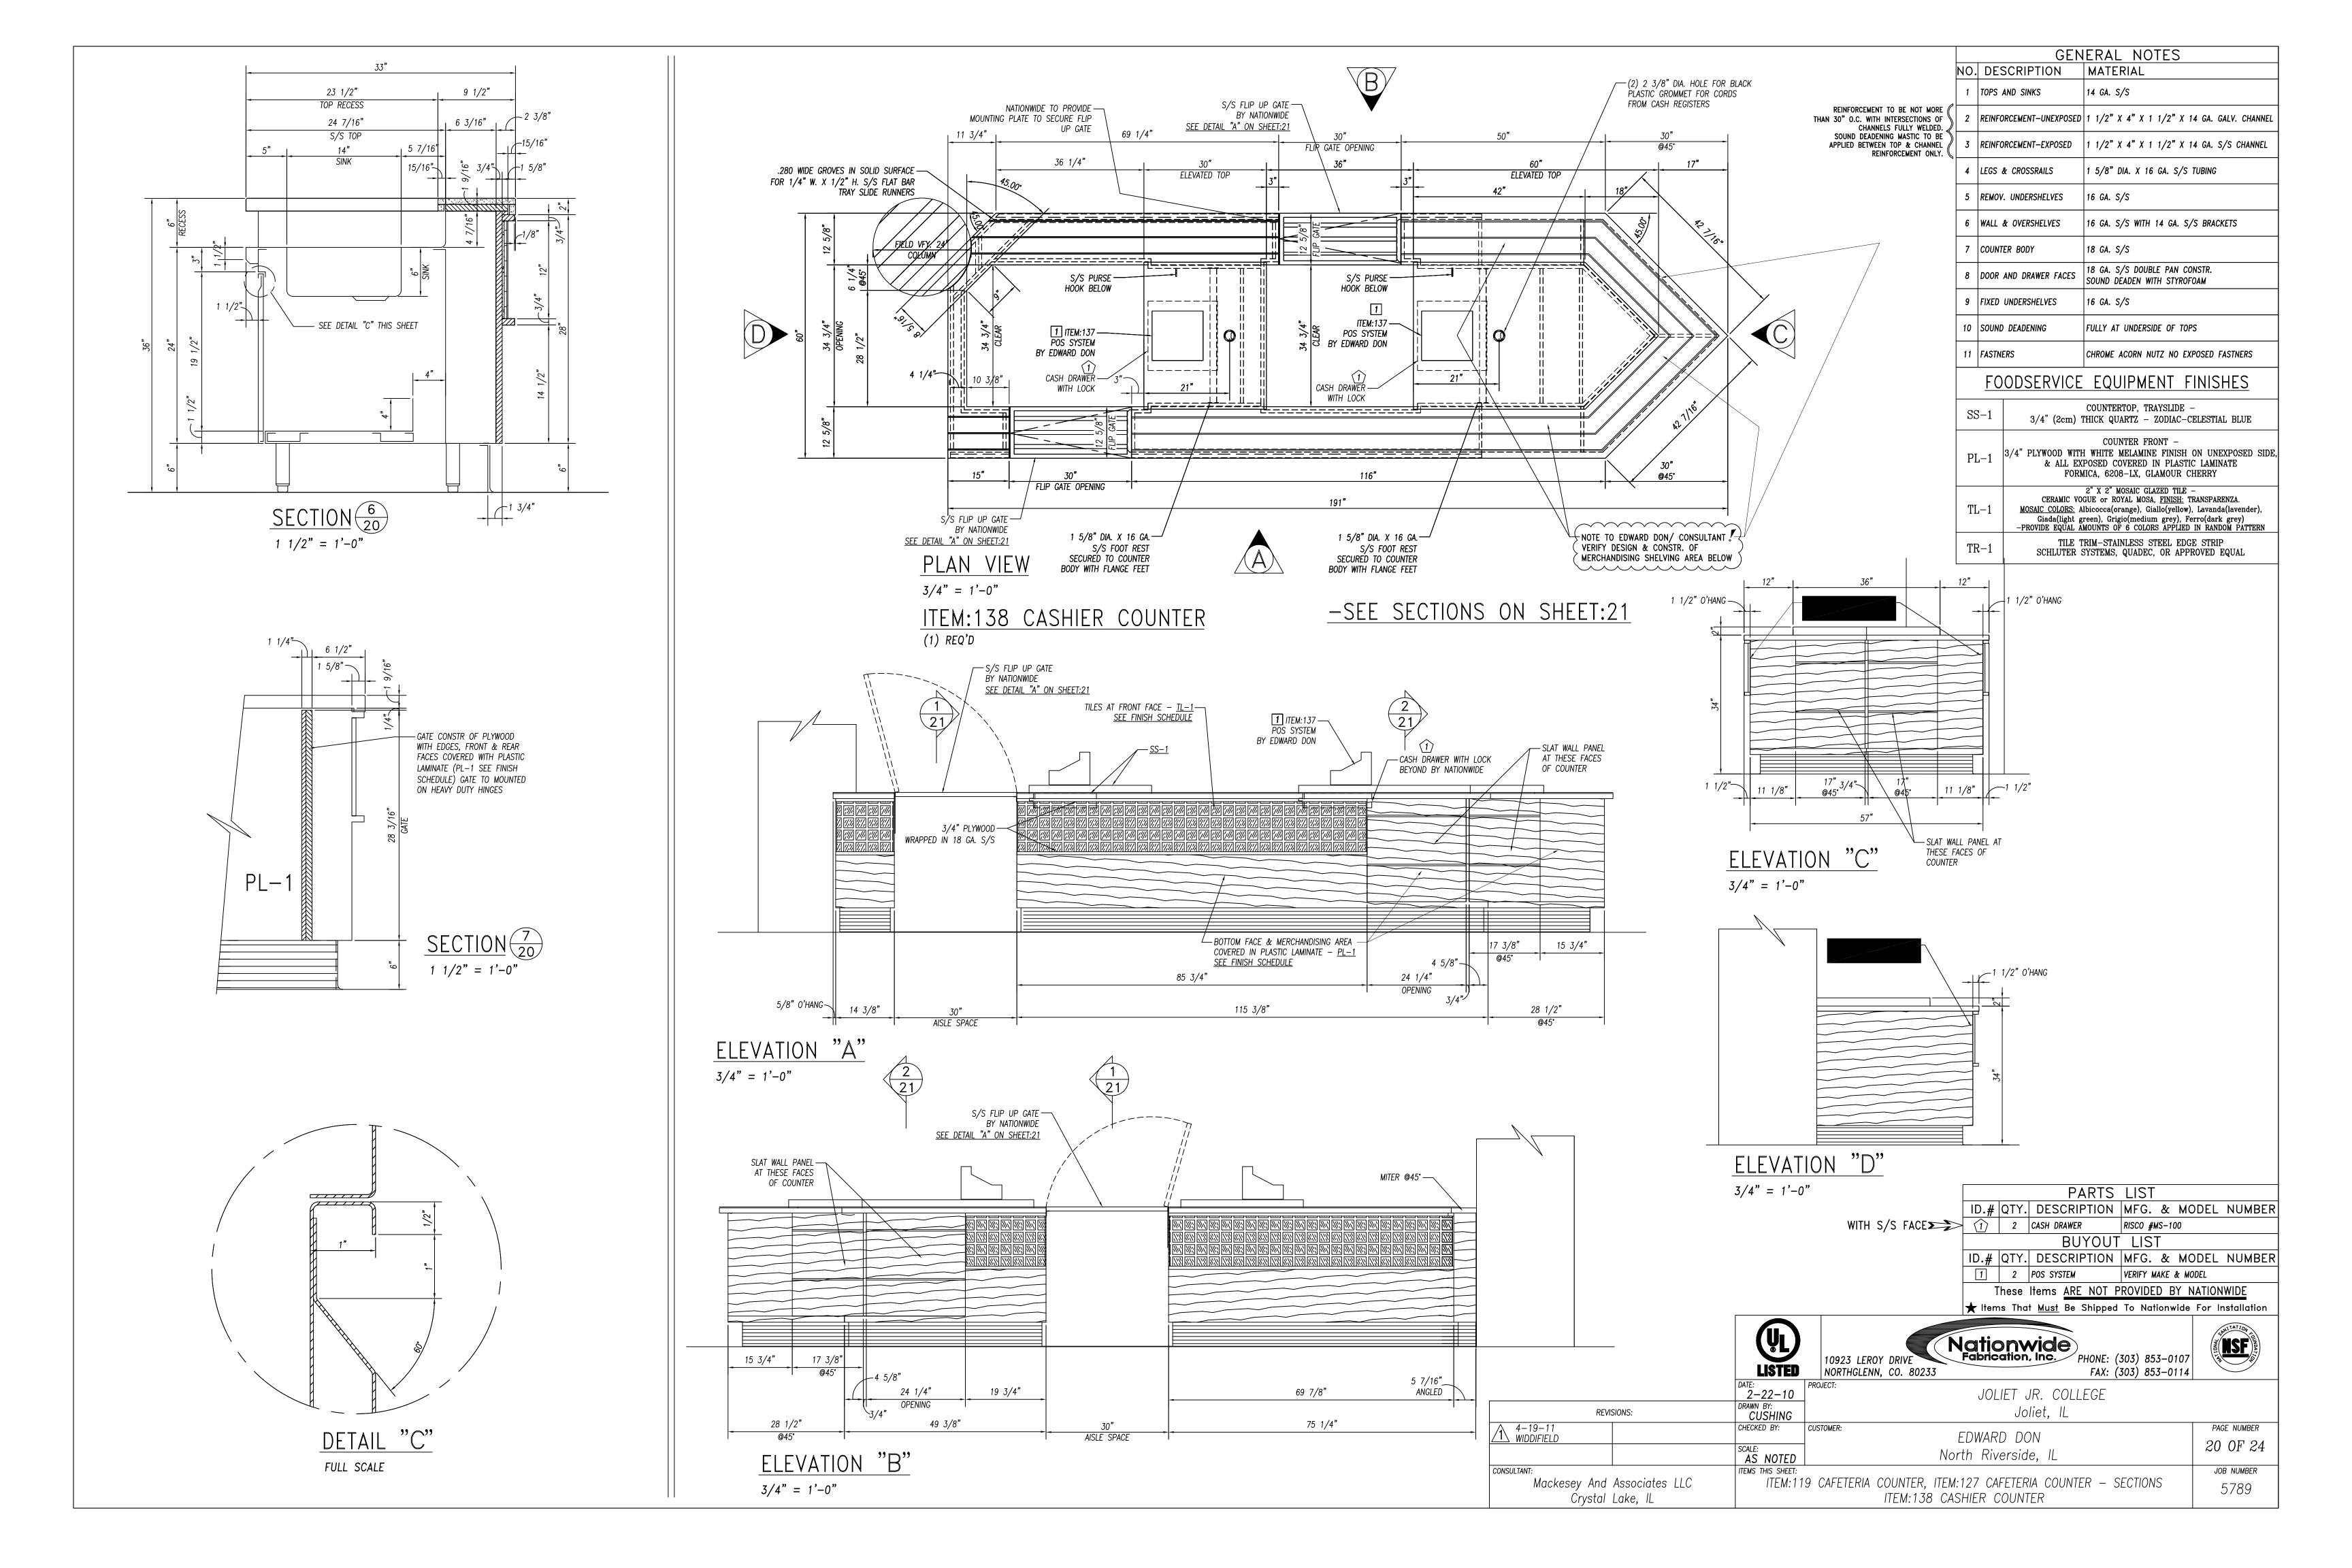



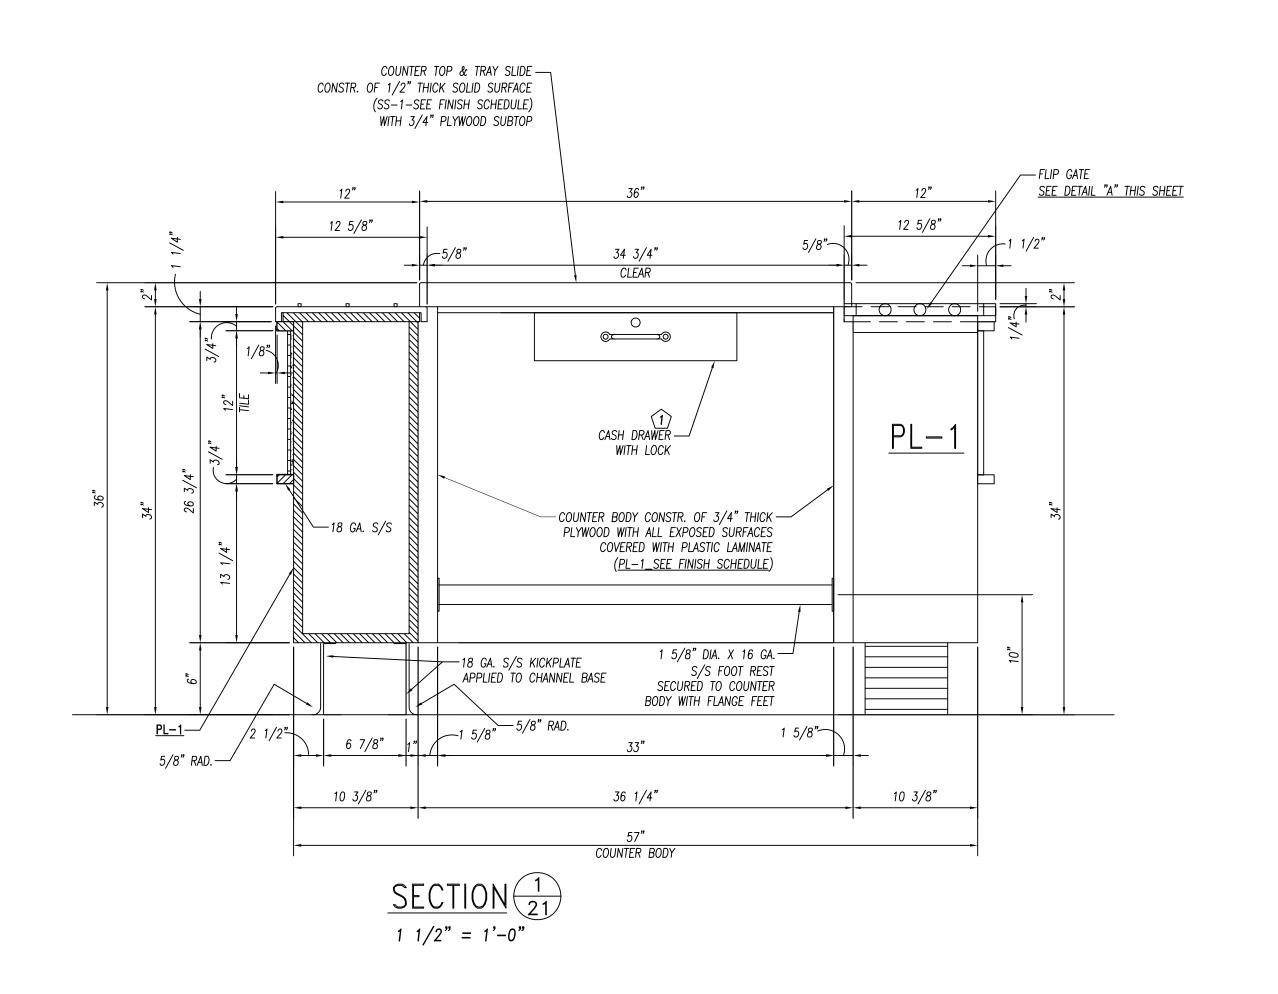

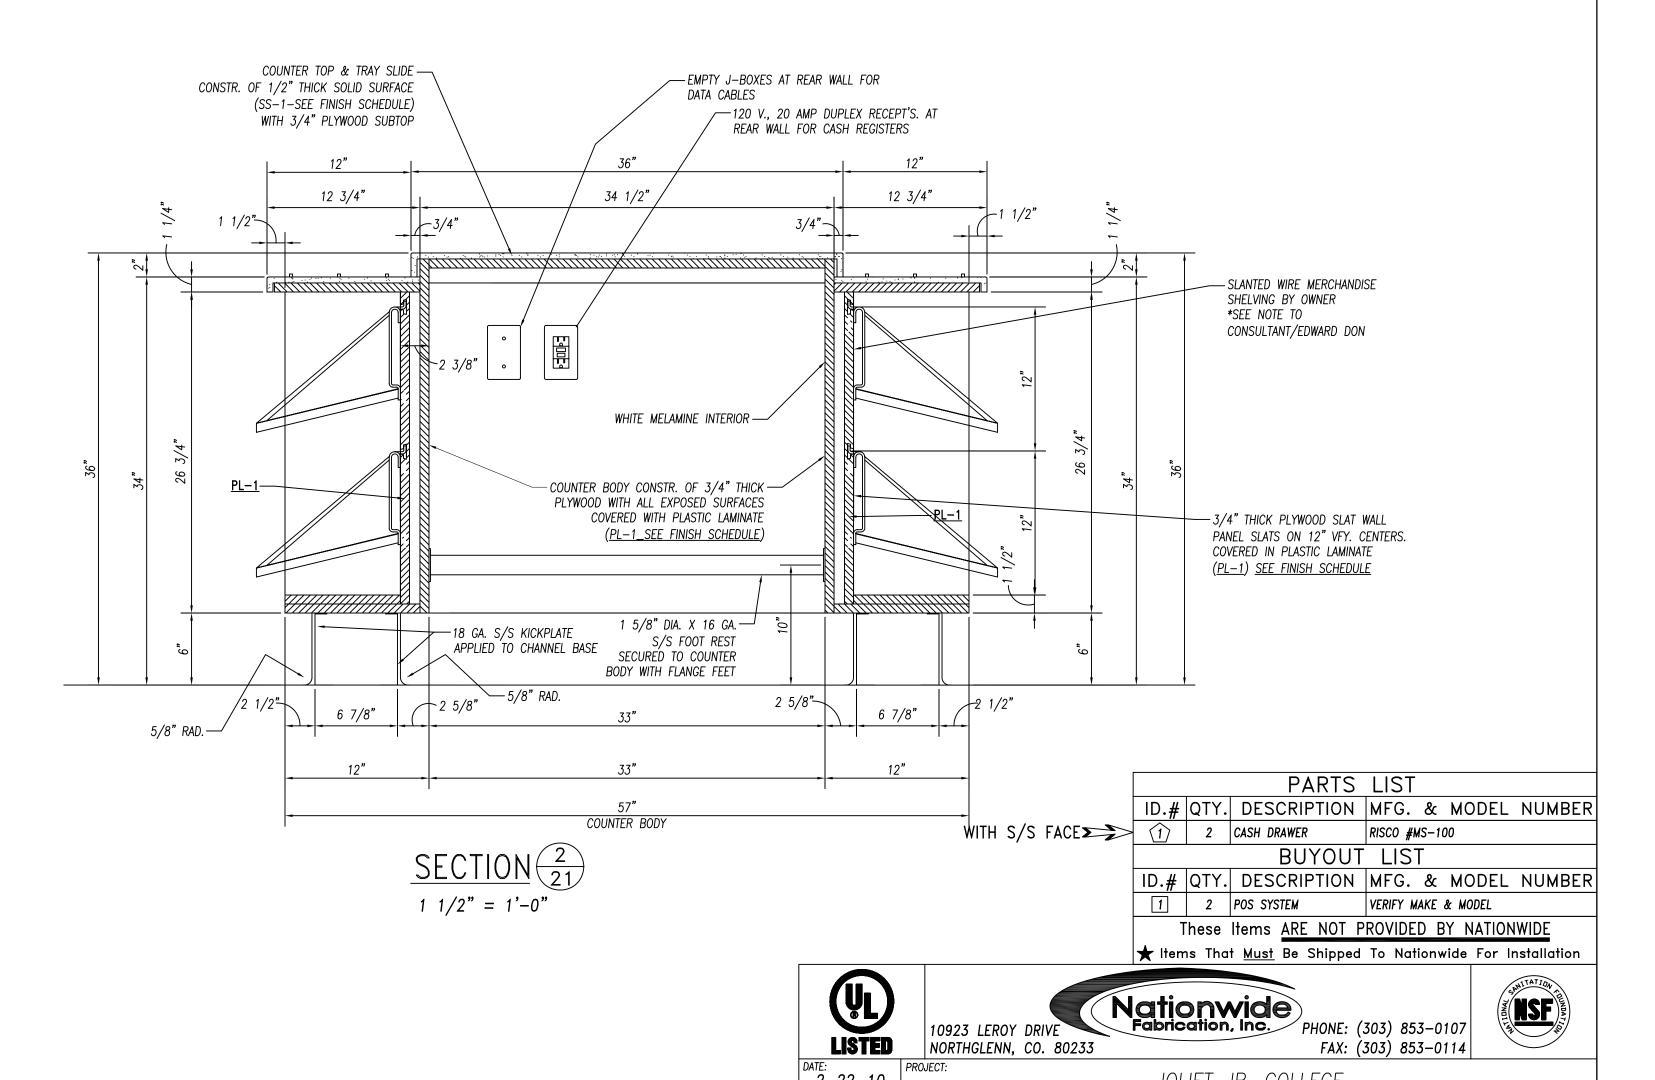

2-22-10
DRAWN BY:
CUSHING
CHECKED BY:

SCALE: AS NOTED

ITEMS THIS SHEET:

CUSTOMER:

REVISIONS:

Mackesey And Associates LLC

Ćrystal Lake, IL

CONSULTANT:

JOLIET JR. COLLEGE Joliet, IL

EDWARD DON

North Riverside, IL

ITEM:138 CASHIER COUNTER


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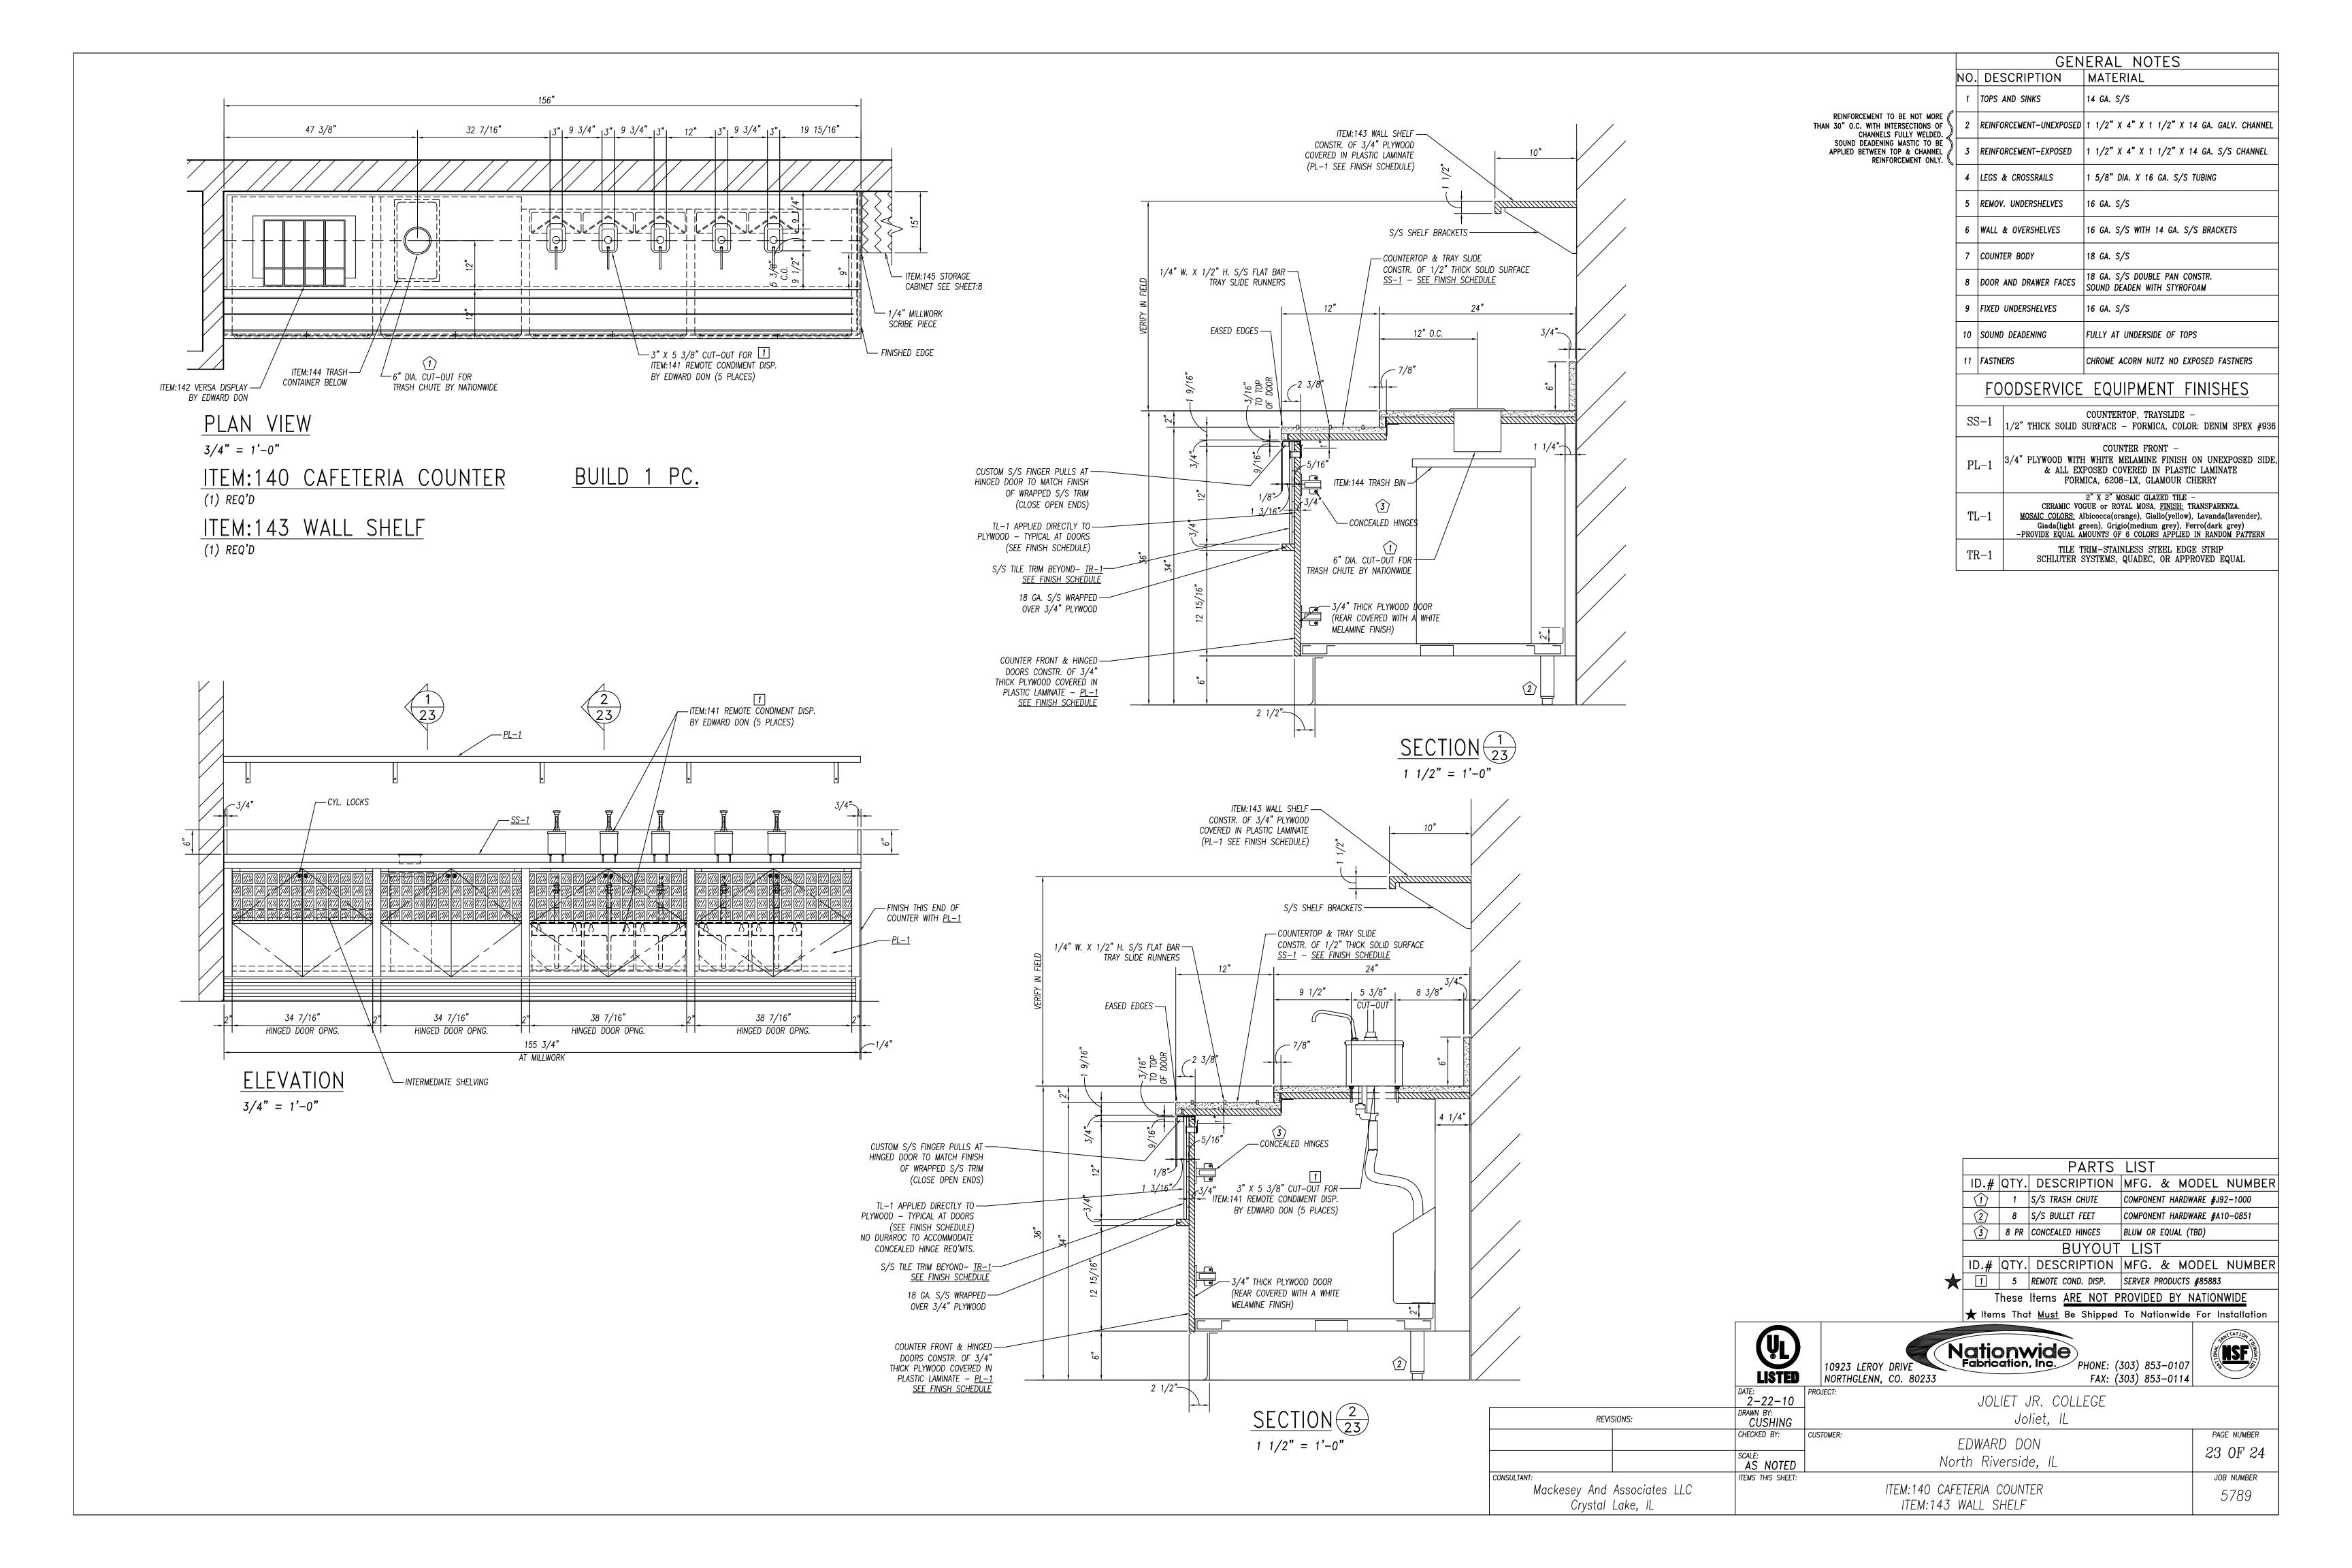
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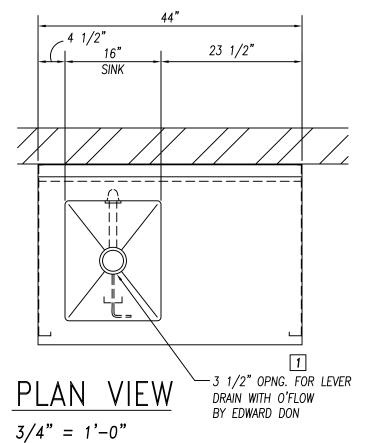
21 OF 24

JOB NUMBER

5789







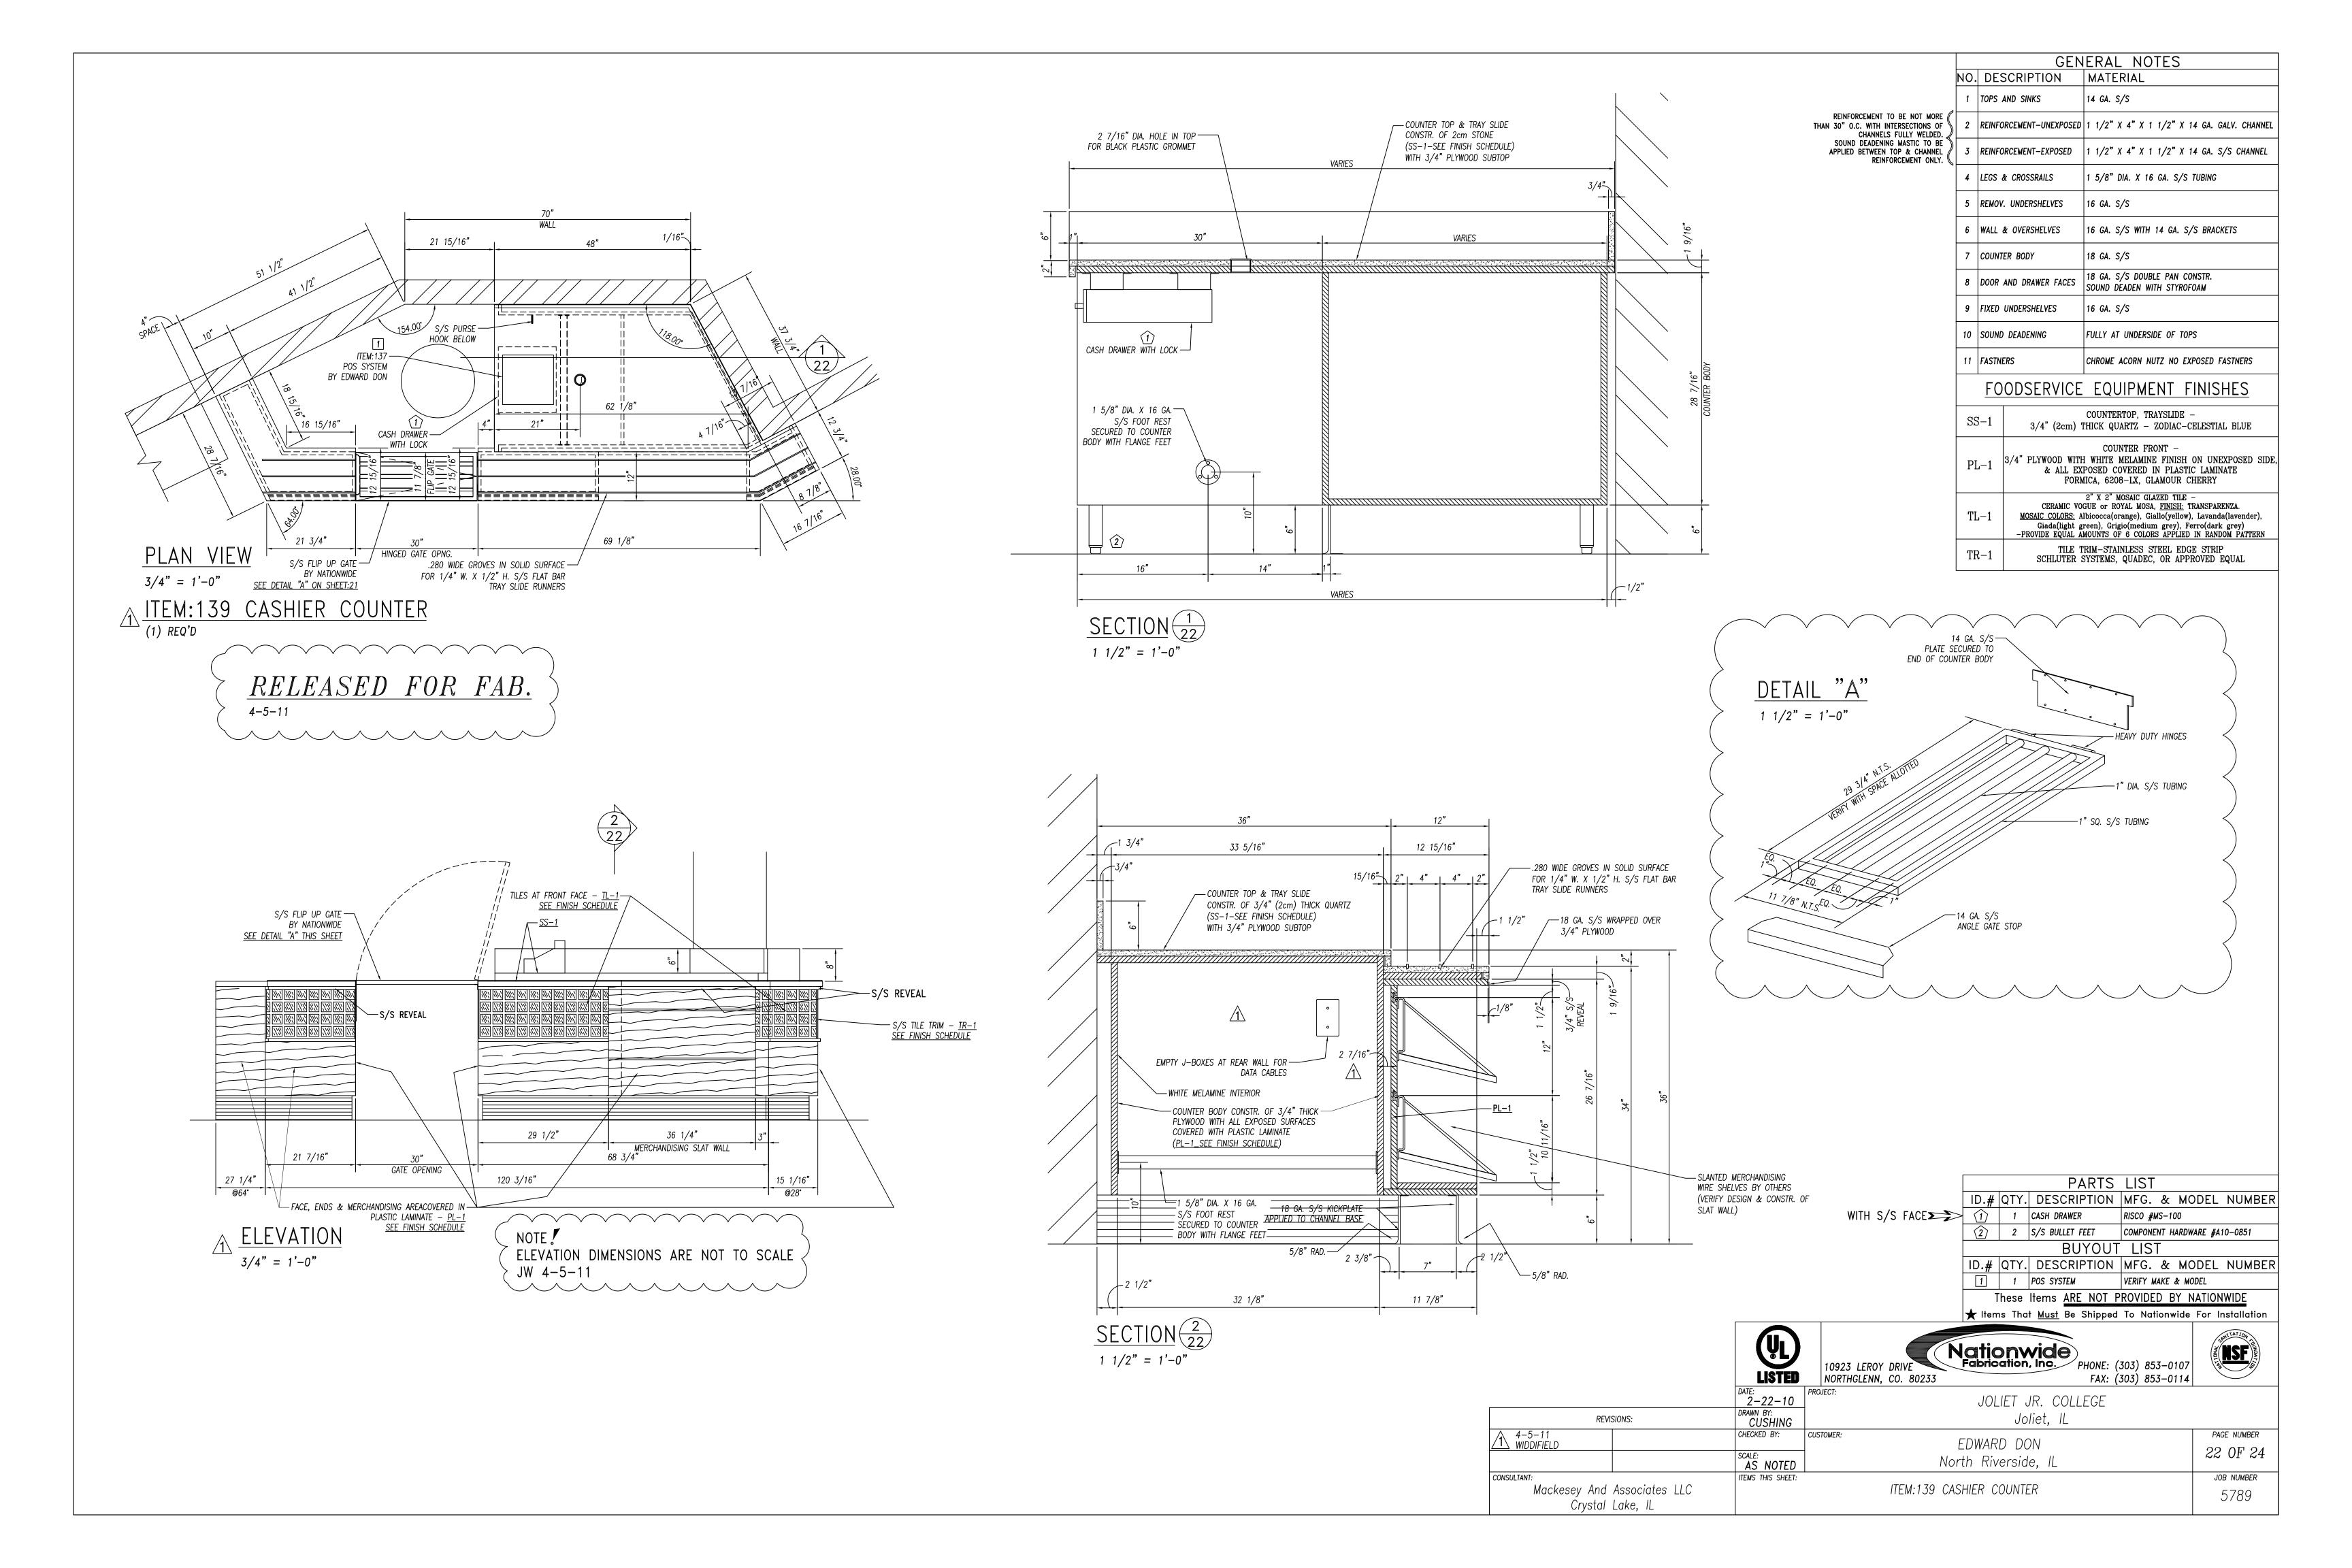



ITEM: 103 CAFETERIA COUNTER W/SINK (1) REQ'D.

> NOTE TO SHOP! > S/S HINGED DOOR HARDWARE CONSISTS OF S/S LIFT-OFF HINGES AND FRICTION CATCHES

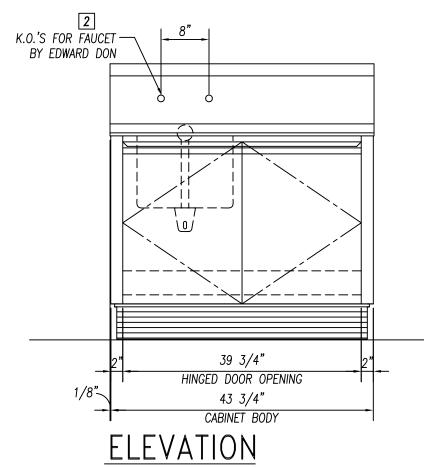

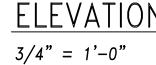

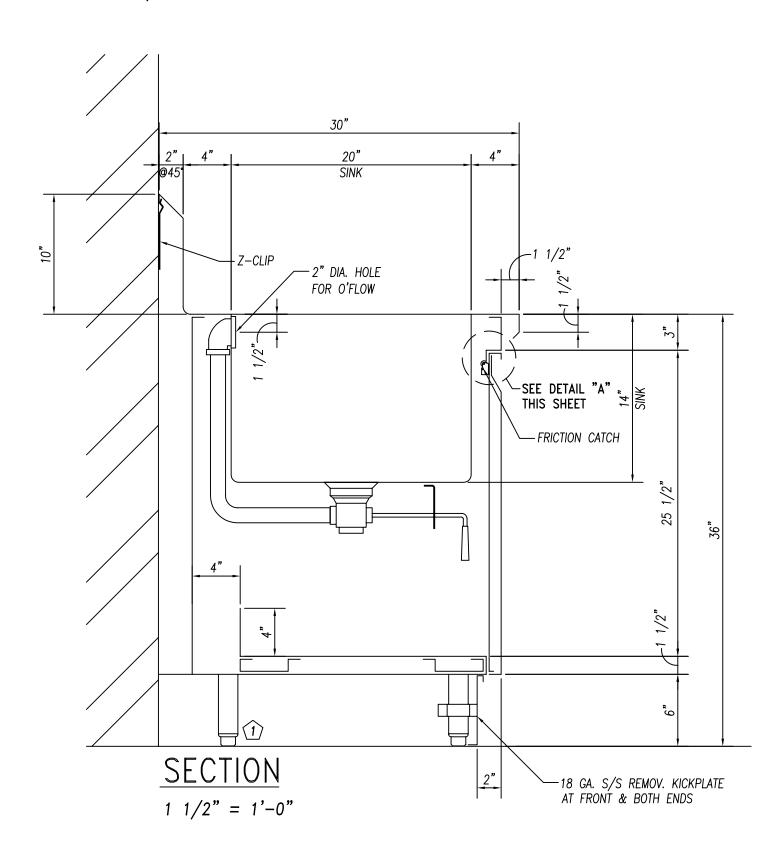

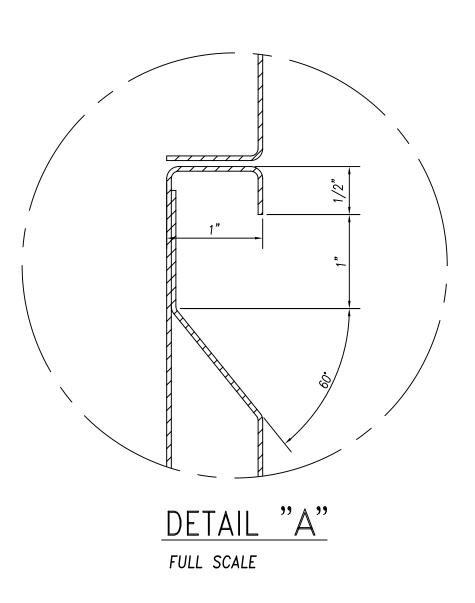

NOTE TO EDWARD DON! VERIFY DIMENSIONS FOR ITEM:115 S/S TRIM

ITEM:115 S/S TRIM (1) LOT REQ'D.

NOTE TO SHOP ! UPON VERIFYING DIMENSIONS FOR (ITEM:115 S/S TRIM. REFER TO STANDARD DETAIL ON SHT:FS6.1 OF THE CONTRACT DRAWINGS REINFORCEMENT TO BE NOT MORI THAN 30" O.C. WITH INTERSECTIONS OI CHANNELS FULLY WELDED SOUND DEADENING MASTIC TO BI APPLIED BETWEEN TOP & CHANNEI REINFORCEMENT ONLY

		GEN	ERAL NOTES
	NO.	DESCRIPTION	MATERIAL
4	1	TOPS AND SINKS	14 GA. S/S
MORE S OF DED.	2	REINFORCEMENT-UNEXPOSED	1 1/2" X 4" X 1 1/2" X 14 GA. GALV. CHANNEL
NNEL ONLY.	3	REINFORCEMENT-EXPOSED	1 1/2" X 4" X 1 1/2" X 14 GA. S/S CHANNEL
	4	LEGS & CROSSRAILS	1 5/8" DIA. X 16 GA. S/S TUBING
	5	REMOV. UNDERSHELVES	16 GA. S/S
	6	WALL & OVERSHELVES	16 GA. S/S WITH 14 GA. S/S BRACKETS
	7	COUNTER BODY	18 GA. S/S
	8	DOOR AND DRAWER FACES	18 GA. S/S DOUBLE PAN CONSTR. SOUND DEADEN WITH STYROFOAM
	9	FIXED UNDERSHELVES	16 GA. S/S
	10	SOUND DEADENING	FULLY AT UNDERSIDE OF TOPS
	11	FASTNERS	CHROME ACORN NUTZ NO EXPOSED FASTNERS

PARTS_LIST									
ID.#	QTY.	DESCRIPTION	MFG. & MODEL NUMBER						
1	4	S/S BULLET FEET	COMPONENT HARDWARE #A10-0851						
		BUYOUT	LIST						
ID.#	QTY.	DESCRIPTION	MFG. & MODEL NUMBER						
1	1	LEVER DRAIN W/O'FLOW	T & S #B-3970-01						
2	1	FAUCET	T & S #B-0231/B-0199-01 AERATOR						
T	These Items <u>ARE NOT PROVIDED BY NATIONWIDE</u>								

tlems That Must Be Shipped To Nationwide For Installation


		A neme man man man in the man in	
	LISTED	10923 LEROY DRIVE Fabrication, Inc. PHONE: (303) 853-010. NORTHGLENN, CO. 80233 FAX: (303) 853-0114	TATION CREATER TO THE PARTY OF
	DATE: 2-22-10	PROJECT: JOLIET JR. COLLEGE	-
REVISIONS:	DRAWN BY: CUSHING	Joliet, IL	
	CHECKED BY:	CUSTOMER:	PAGE NUMBER
		EDWARD DON	24 OF 24
	SCALE: AS NOTED	North Riverside, IL	24 01 24
CONSULTANT:	ITEMS THIS SHEET:		JOB NUMBER
Mackesey And Associates LLC		ITEM:103 CAFETERIA COUNTER W/SINK	F700
Crystal Lake, IL		ITEM:115 S/S TRIM	5789


Height 8'-6"

☐ 26 Ga. Stucco Embossed Galv. Steel


Interior (walls and ceiling)

□ .040 Stucco Aluminum

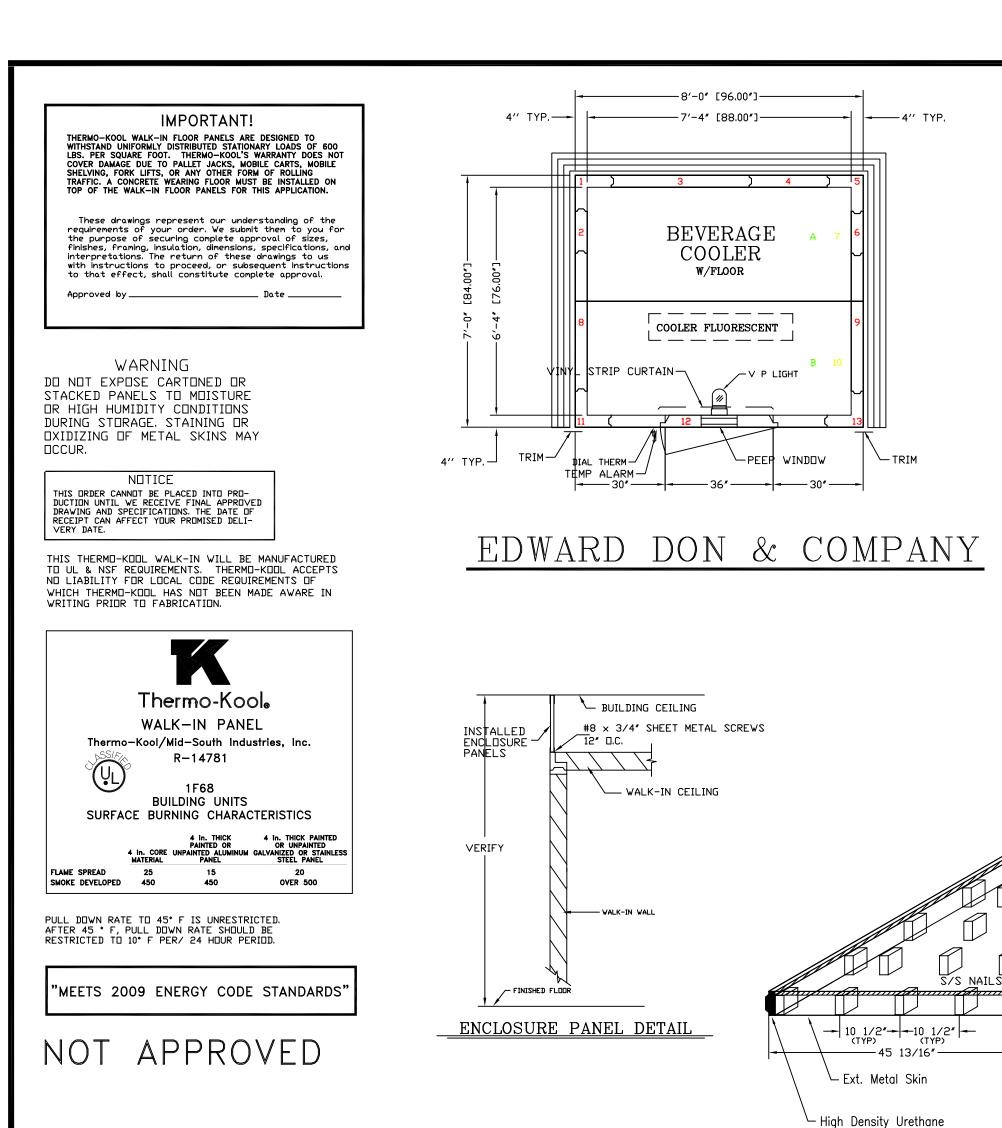

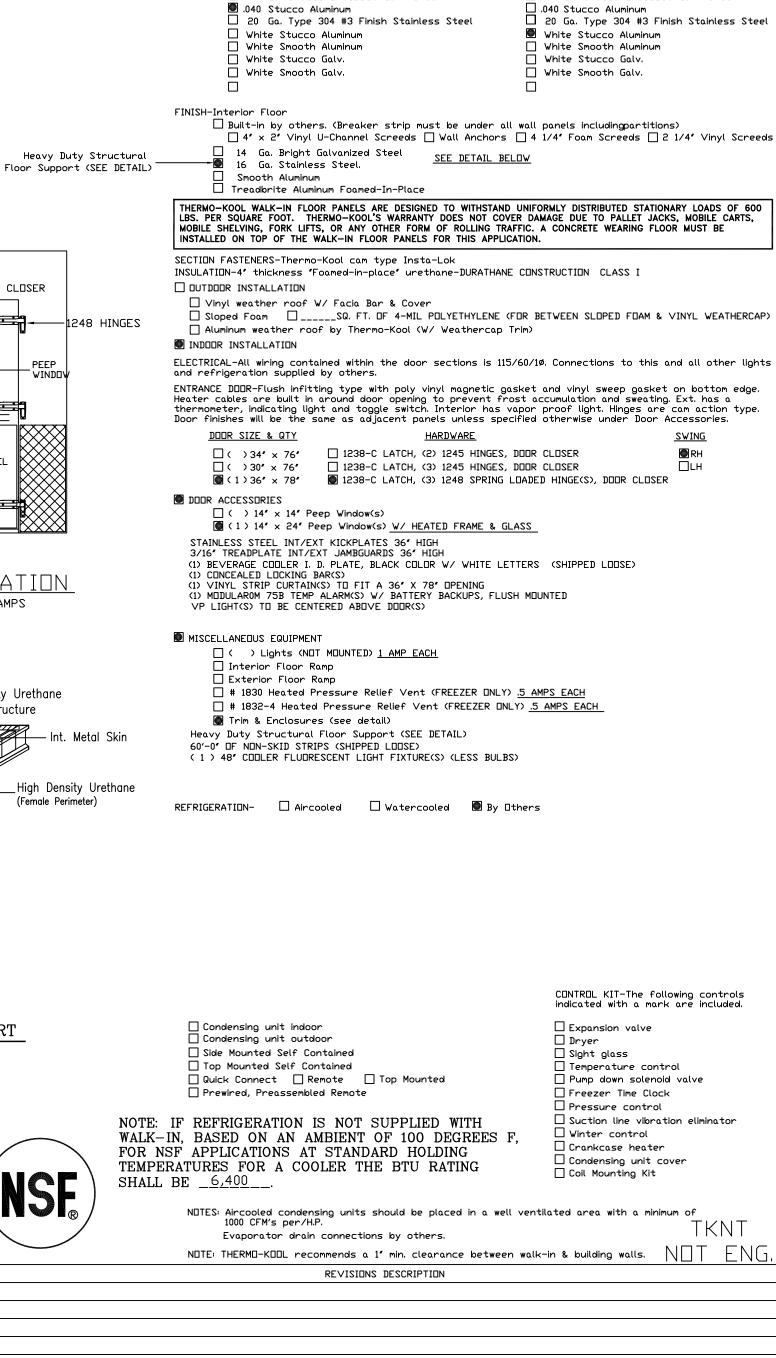

* SEE Heavy Duty Structural Floor Support DETAIL

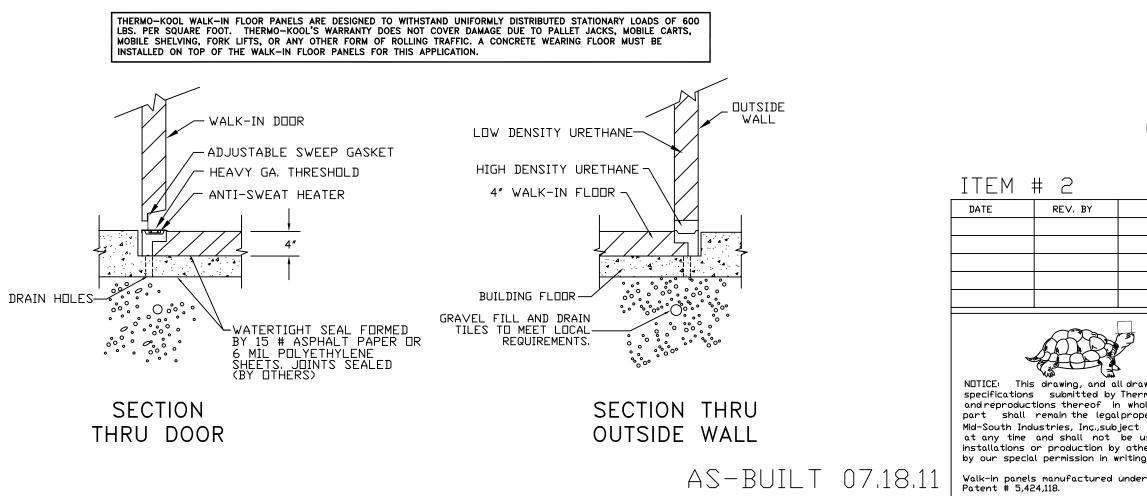

ITEM # 2 DATE REV. BY NOTICE: This drawing, and all drawings or specifications submitted by Thermo-Kool, and reproductions thereof in whole or in part shall remain the legal property of Mid-South Industries, Inc., subject to recall at any time and shall not be used for installations or production by others except by our special permission in writing.

NSF

Thermo-Kool。

Mid-South Industries, Inc. ● P.D. Box 989 Laurel Mississippi 39441 • Phone 601/649-4600 FAX 601/649-0558

OVERALL DIMENSIONS

FINISH-Exterior

Heavy Duty Structural

1248 HINGES

— DOOR CLOSER

PEEP

///

STAINLESS STEEL

DOOR ELEVATION

High Density Urethane

Int. Metal Skin

High Density Urethane

(Female Perimeter)

Support Structure

DOOR SECTION 4 AMPS

3/4" Plywood Subfloor

Low Density Urethane

(Core Foam)

HEAVY DUTY STRUCTURAL FLOOR SUPPORT

(Male Perimeter)

TEMP ALAR

HAZARD PLACARD

TREADPLATE

DIAL THEIRM -

LIGHT SWITCH —— 1238-C LATCH ---

CONCEALED LOCKING BAR ------

Length 8'-0"

☐ 26 Ga. Stucco Embossed Galv. Steel

Depth 7'-0"

WALK-IN REFRIGERATION FOR JOLIET JR. COLLEGE JOLIET, IL DR. BY CH. BY DWG. N□. 52939 DW DATE HEET NO. SCALE 3/8"=1'-0" 1 OF 1




These drawings represent our understanding of the requirements of your order. We submit them to you for the purpose of securing complete approval of sizes, finishes, framing, insulation, dimensions, specifications, and interpretations. The return of these drawings to us with instructions to proceed, or subsequent instructions to that effect, shall constitute complete approval.

WARNING DO NOT EXPOSE CARTONED OR STACKED PANELS TO MOISTURE OR HIGH HUMIDITY CONDITIONS DURING STORAGE, STAINING OR DXIDIZING OF METAL SKINS MAY □CCUR.

THIS ORDER CANNOT BE PLACED INTO PRODUCTION UNTIL WE RECEIVE FINAL APPROVED DRAWING AND SPECIFICATIONS. THE DATE OF RECEIPT CAN AFFECT YOUR PROMISED DELIVERY DATE


THIS THERMO-KOOL WALK-IN WILL BE MANUFACTURED TO UL & NSF REQUIREMENTS. THERMO-KOOL ACCEPTS NO LIABILITY FOR LOCAL CODE REQUIREMENTS OF WHICH THERMO-KOOL HAS NOT BEEN MADE AWARE IN WRITING PRIOR TO FABRICATION.

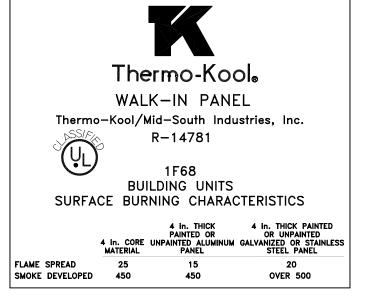


PULL DOWN RATE TO 45° F IS UNRESTRICTED. AFTER 45 ° F, PULL DOWN RATE SHOULD BE RESTRICTED TO 10° F PER/ 24 HOUR PERIOD.


"MEETS 2009 ENERGY CODE STANDARDS"


NOT APPROVED REVISED

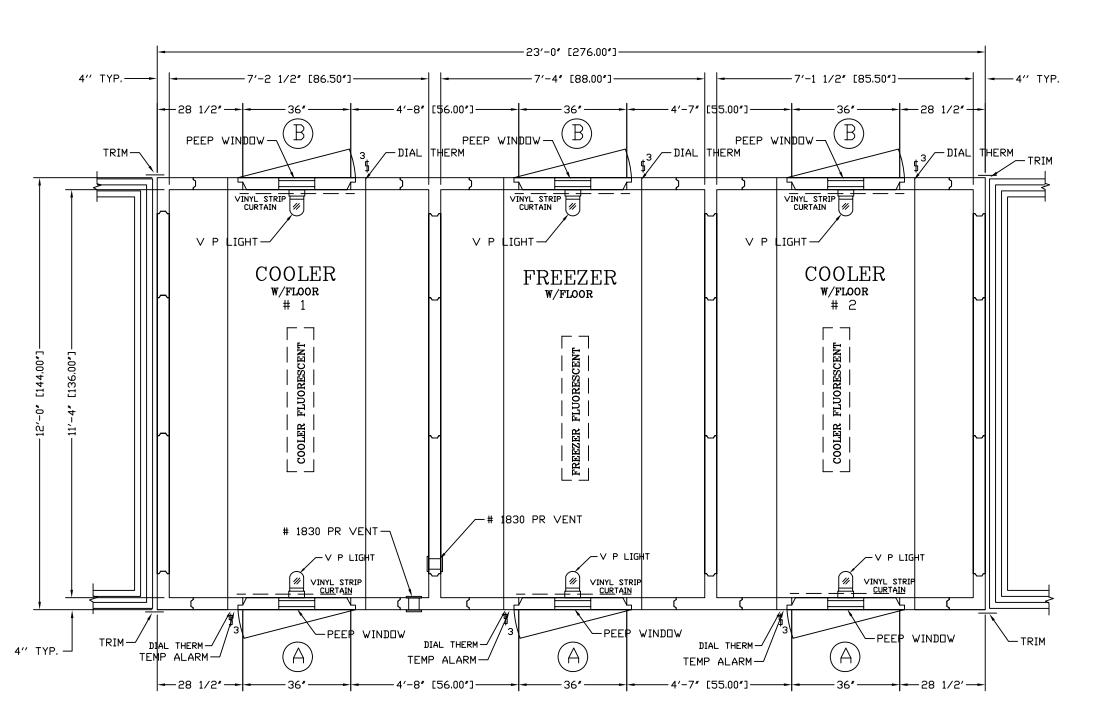


EDWARD DON & COMPANY

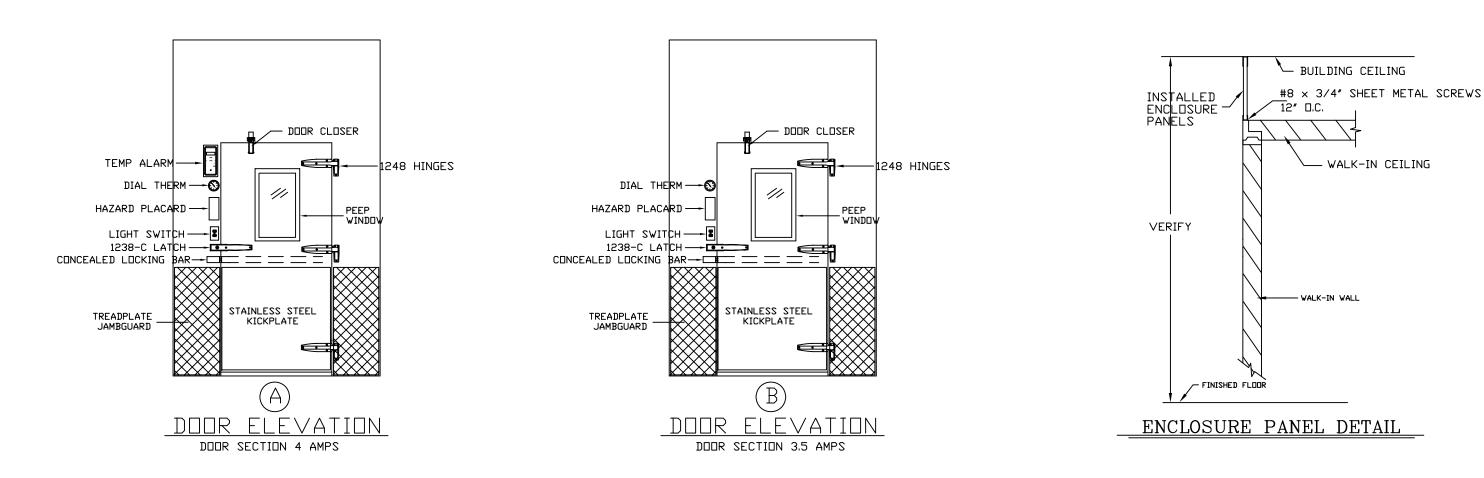

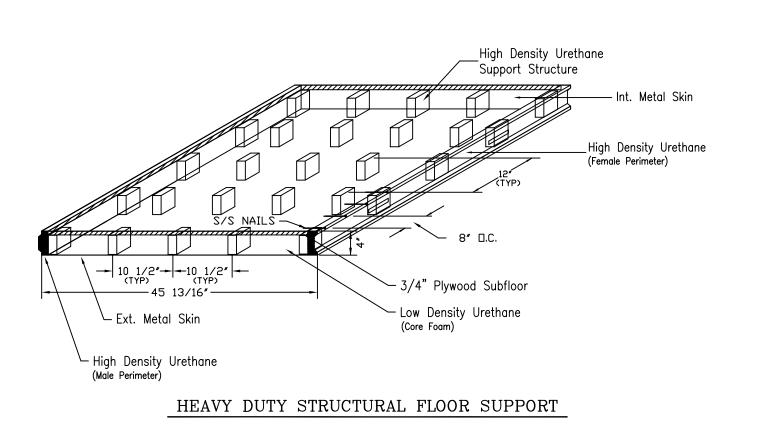

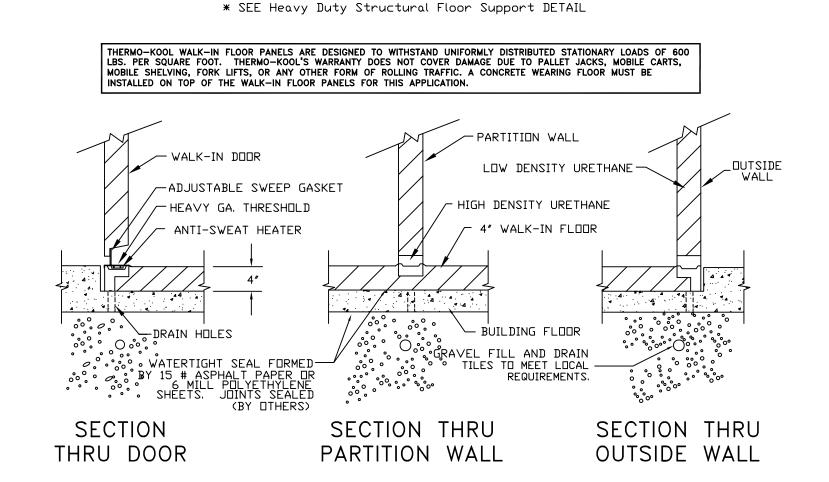

AS-BUILT 07.18.11

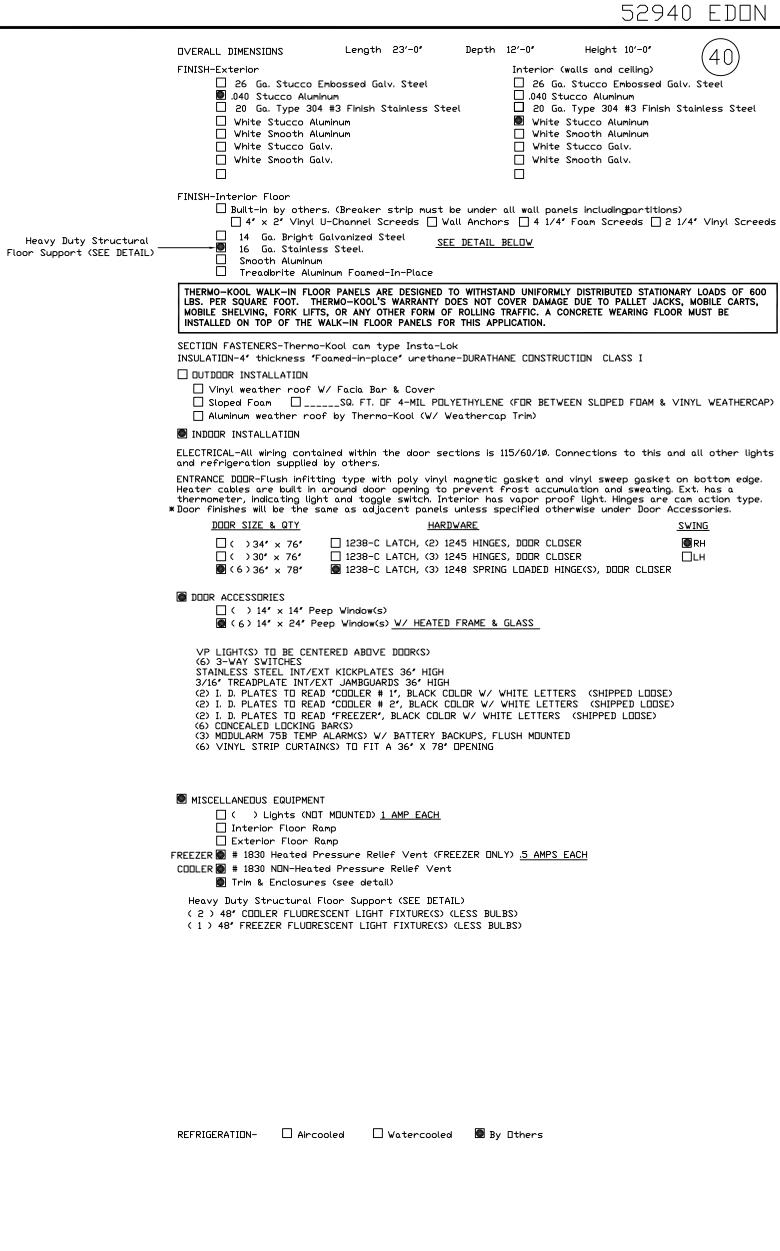

CONTROL KIT-The following controls indicated with a mark are included.

☐ Expansion valve

Sight glass


☐ Condensing unit indoor☐ Condensing unit outdoor ☐ Side Mounted Self Contained ☐ Top Mounted Self Contained ☐ Prewired, Preassembled Remote

☐ Temperature control ☐ Pump down solenoid valve ☐ Freezer Time Clock ☐ Pressure control ☐ Suction line vibration eliminator NOTE: IF REFRIGERATION IS NOT SUPPLIED WITH \square Winter control WALK-IN, BASED ON AN AMBIENT OF 100 DEGREES F, ☐ Crankcase heater FOR NSF APPLICATIONS AT STANDARD HOLDING \square Condensing unit cover TEMPERATURES FOR COOLER # 1 THE BTU RATING SHALL ☐ Coil Mounting Kit BE _9,300 __ AND FOR COOLER # 2 THE BTU RATING SHALL

BE _9,300 __ AND SHALL BE _10,200 NOTES: Aircooled condensing units should be placed in a well ventilated area with a minimum of 1000 CFM's per/H.P.

Evaporator drain connections by others. ITEMS # 9, 11 & 13 NOTE: THERMO-KOOL recommends a 1' min. clearance between walk-in & building walls. REVISIONS DESCRIPTION RE∨. BY DW ADDED (6) VINYL STRIP CURTAINS.

AND FOR A FREEZËR THE BTU RATING

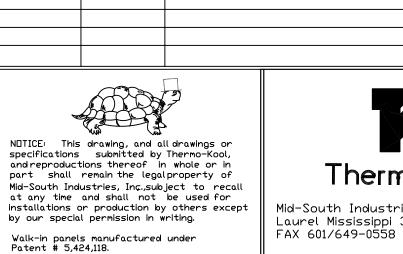

DATE

1-15-10


Thermo-Kool Mid-South Industries, Inc. ● P.D. Box 989

WALK-IN REFRIGERATION JOLIET JR. COLLEGE JOLIET, IL.

52940 Laurel Mississippi 39441 • Phone 601/649-4600 1 OF 1 3/8"=1'-0" 1-15-10



ITEM: 4 ALUMINUM TRIM ANGLES
(6) TOTAL REQ'D.

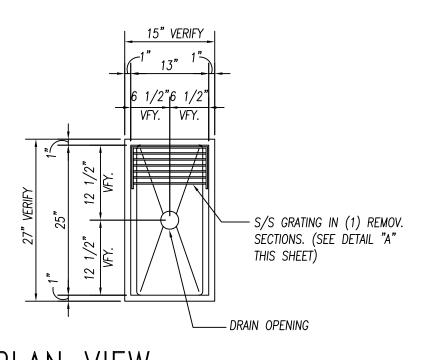



PLAN VIEW


3/4" = 1'-0"

ITEM:8 FLOOR TROUGH

(1) REQ'D.

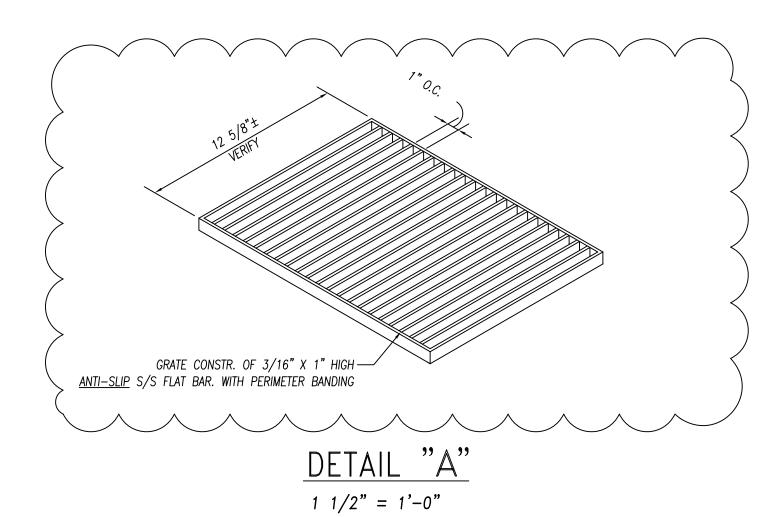

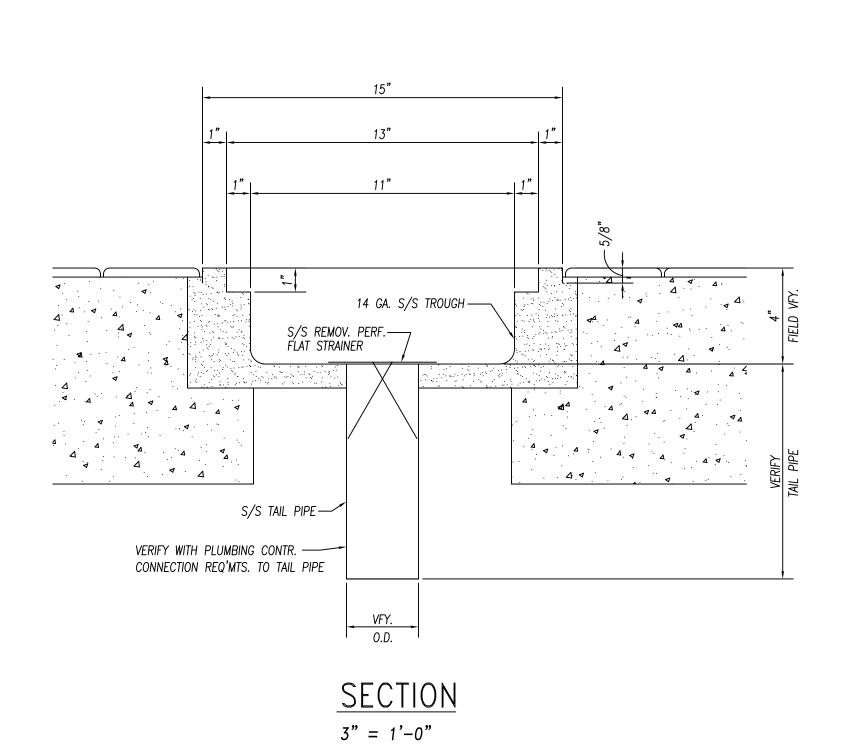


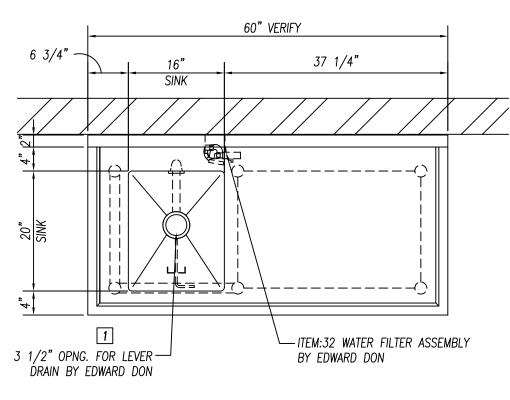


 $\frac{\text{PLAN VIEW}}{3/4" = 1'-0"}$

ITEM:31 WORKTABLE

(1) REQ'D.

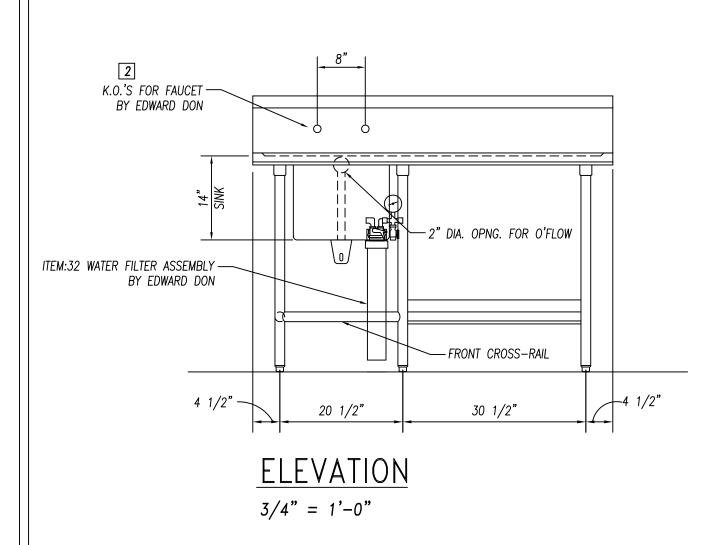

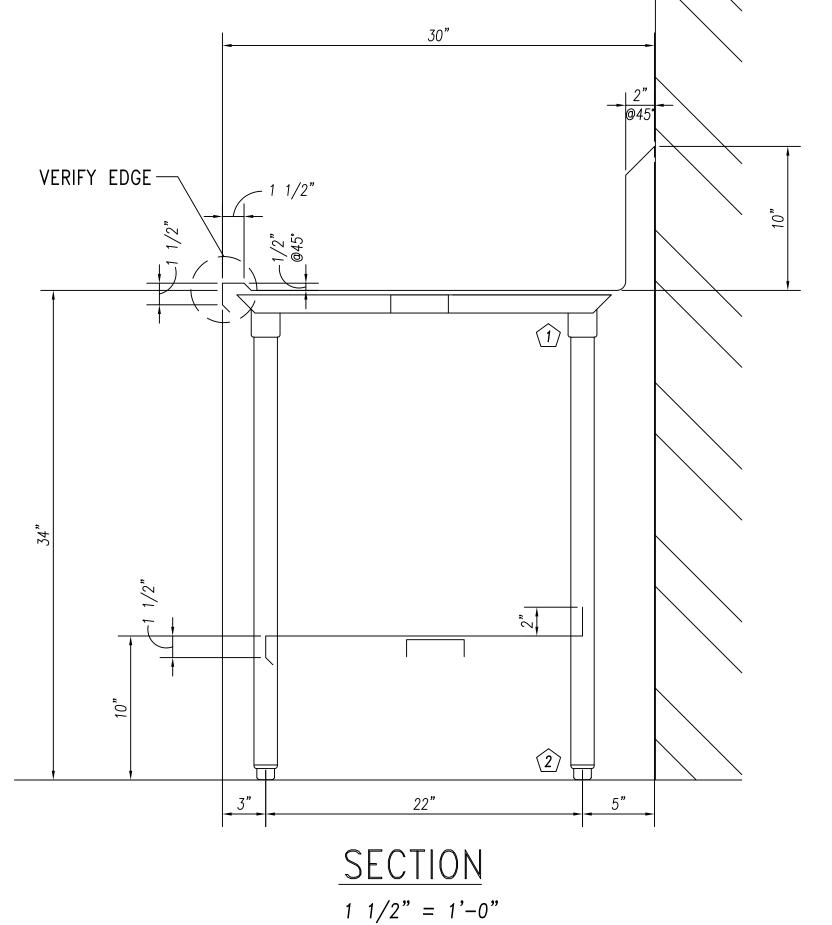

		PARTS	LIST		
ID.#	QTY.	DESCRIPTION	MFG. & MODEL NUMBER		
$ \overline{\Box}\rangle$	6	S/S GUSSETS	COMPONENT HARDWARE #A18-0206		
2	6	S/S BULLET FEET	COMPONENT HARDWARE #A10-0851		
		BUYOUT	LIST		
ID.#	QTY.	DESCRIPTION	MFG. & MODEL NUMBER		
1	1	LEVER DRAIN W/O'FLOW	T & S #B-3970-01		
2	1	SPLASH MTD. FAUCET	T & S #B-0231/B-0199-01 AERATOR		

GENERAL NOTES

14 GA. S/S

18 GA. S/S

16 GA. S/S

2 REINFORCEMENT-UNEXPOSED 1 1/2" X 4" X 1 1/2" X 14 GA. GALV. CHANNEL

1 1/2" X 4" X 1 1/2" X 14 GA. S/S CHANNEL

1 5/8" DIA. X 16 GA. S/S TUBING

16 GA. S/S WITH 14 GA. S/S BRACKETS

18 GA. S/S DOUBLE PAN CONSTR. SOUND DEADEN WITH STYROFOAM

FULLY AT UNDERSIDE OF TOPS

CHROME ACORN NUTZ NO EXPOSED FASTNERS

NO. DESCRIPTION MATERIAL

1 TOPS AND SINKS

3 REINFORCEMENT-EXPOSED

4 LEGS & CROSSRAILS

5 REMOV. UNDERSHELVES

6 WALL & OVERSHELVES

8 DOOR AND DRAWER FACES

9 FIXED UNDERSHELVES

10 SOUND DEADENING

11 FASTNERS

7 COUNTER BODY


REINFORCEMENT TO BE NOT MORE


THAN 30" O.C. WITH INTERSECTIONS OF
CHANNELS FULLY WELDED.
SOUND DEADENING MASTIC TO BE
APPLIED BETWEEN TOP & CHANNEL
REINFORCEMENT ONLY.

These Items ARE NOT PROVIDED BY NATIONWIDE

★ Items That Must Be Shipped To Nationwide For Installation


	UL LISTED	10923 LEROY DRIVE Fabrication, Inc. PHONE: (303) 853-0107 NORTHGLENN, CO. 80233 FAX: (303) 853-0114	TATION COLUMN TO THE PART OF T
AS-BUILT 07.18.11	DATE: 2-22-10	PROJECT: JOLIET JR. COLLEGE	
REVISIONS:	DRAWN BY: CUSHING	Joliet, IL	
	CHECKED BY:	CUSTOMER: EDWARD DON	PAGE NUMBER
	SCALE: AS NOTED	North Riverside, IL	1 OF 24
CONSULTANT:	ITEMS THIS SHEET:	ITEM A ALLIMANUM TOWN AND TO STEM OF TOOLION	JOB NUMBER
Mackesey And Associates LLC		ITEM:4 ALUMINUM TRIM ANGLES, ITEM:8 FLOOR TROUGH	5789
Crystal Lake, IL		ITEM:31 WORKTABLE	

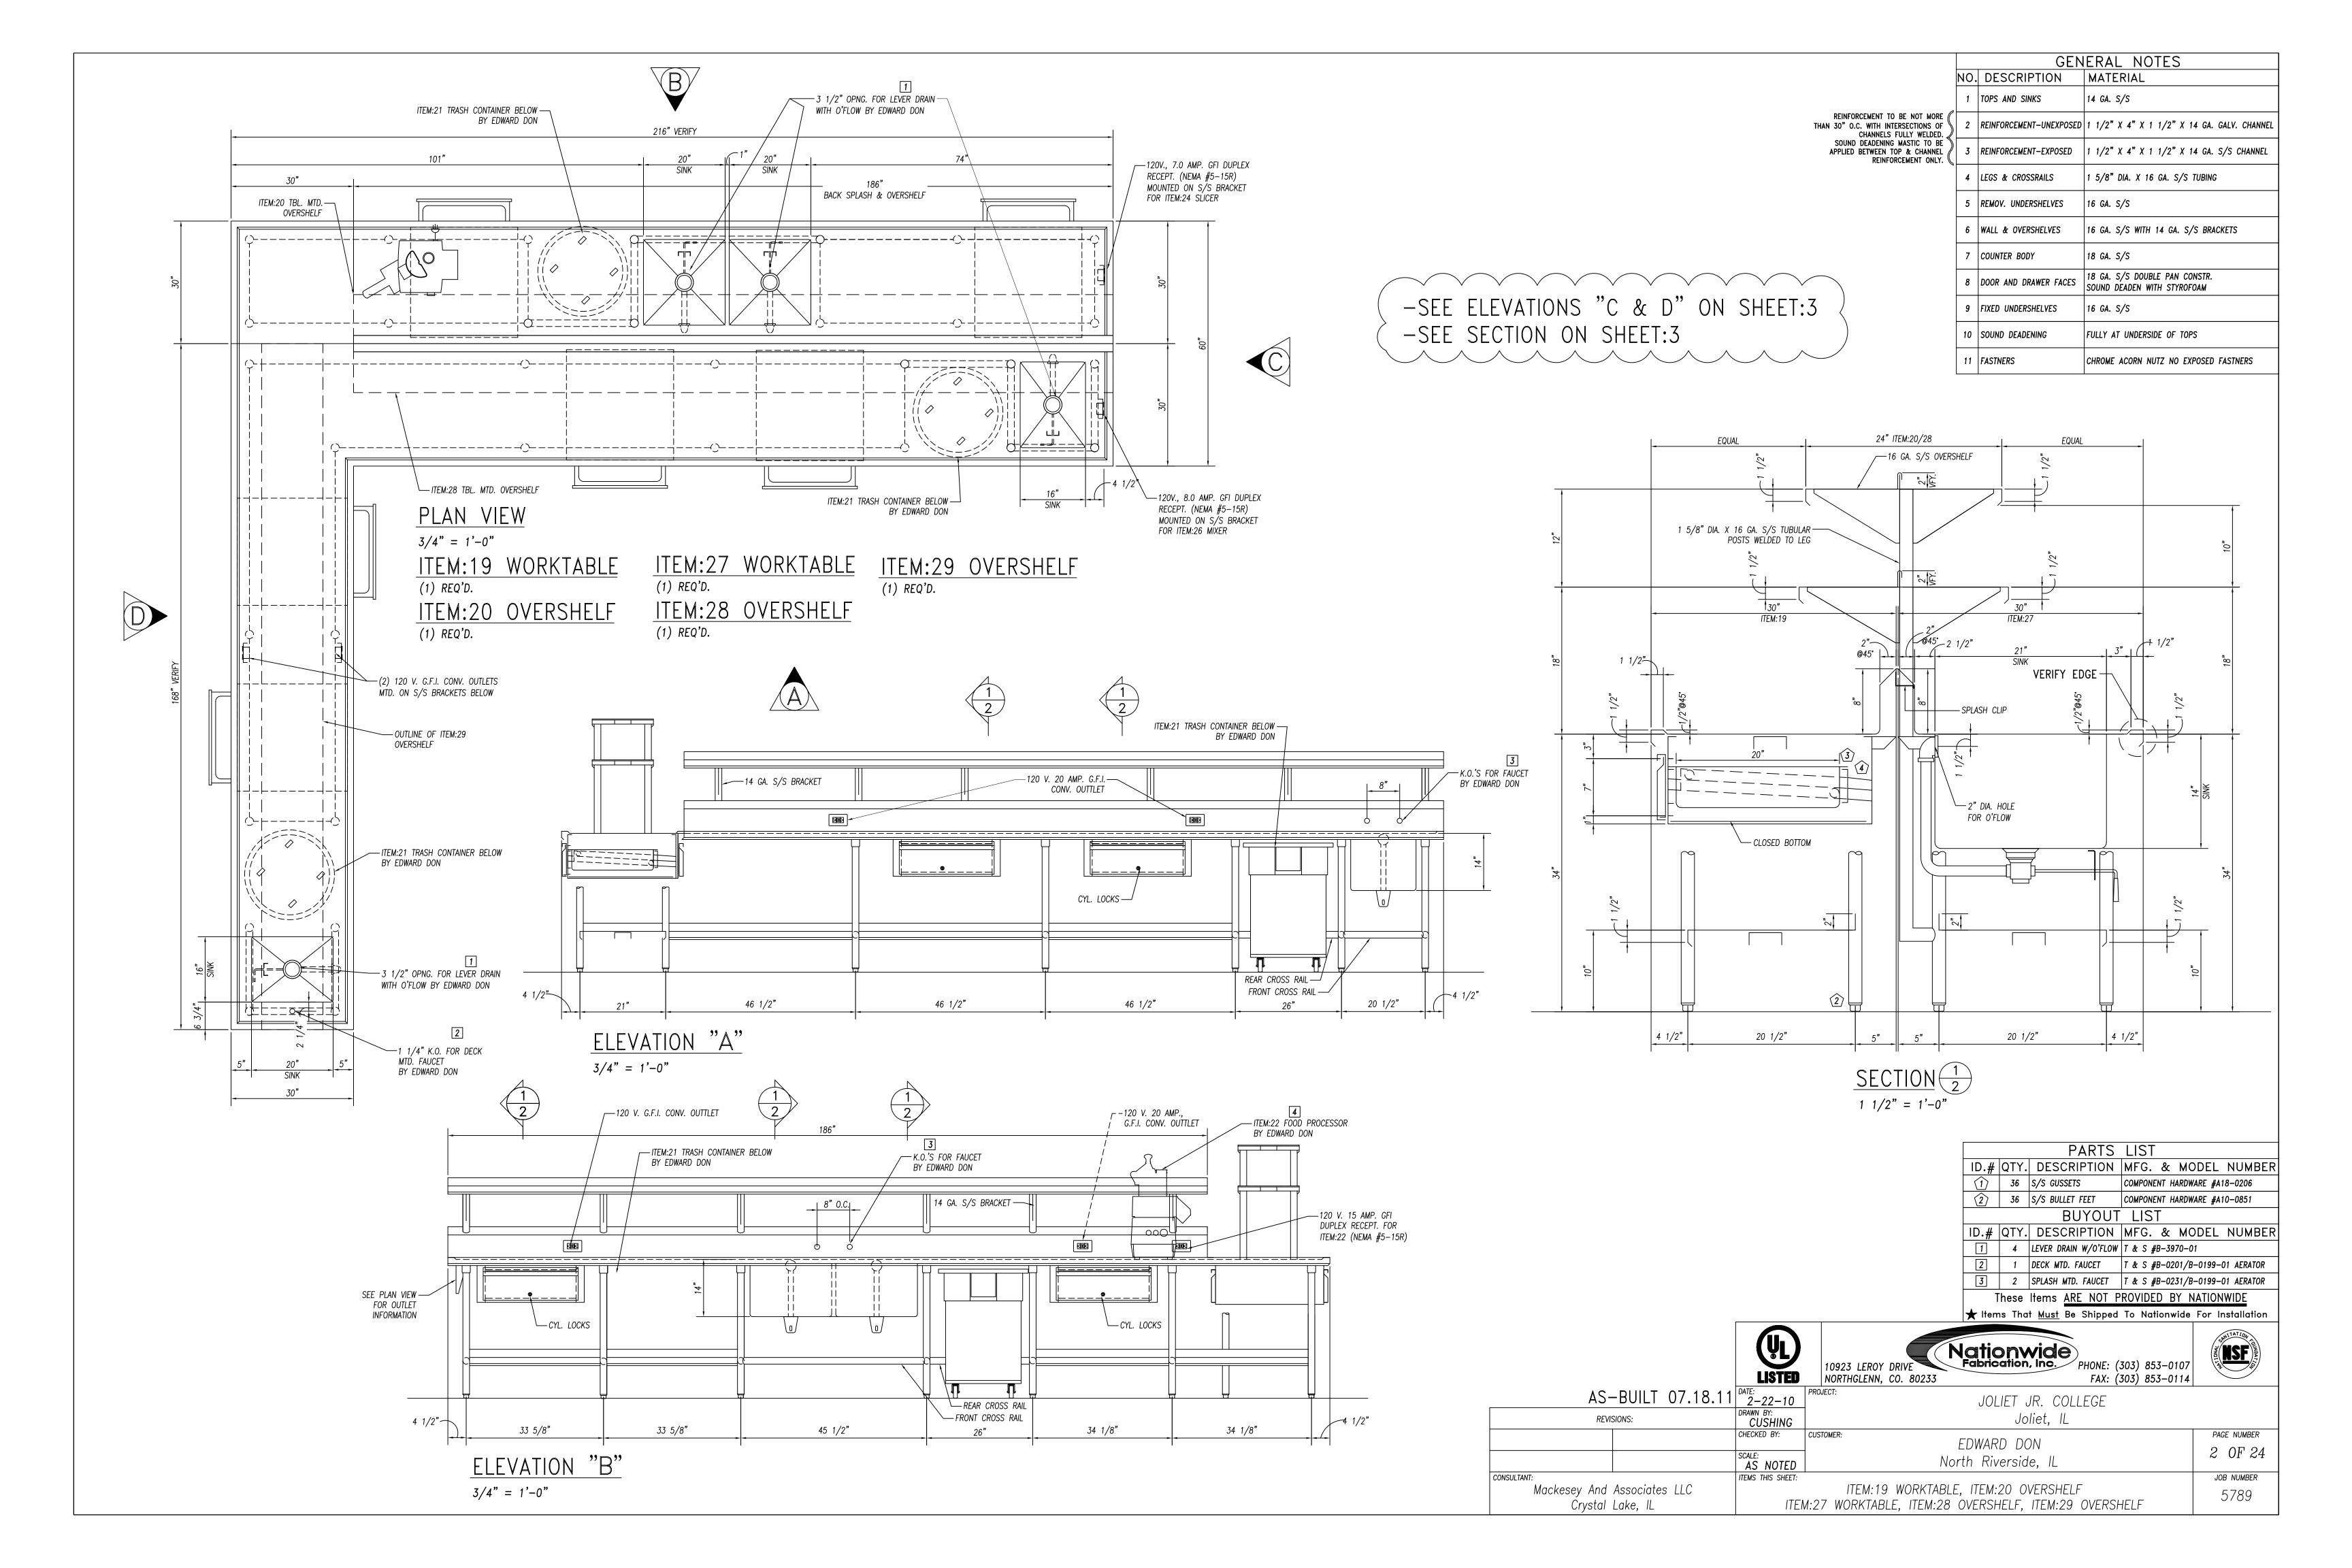


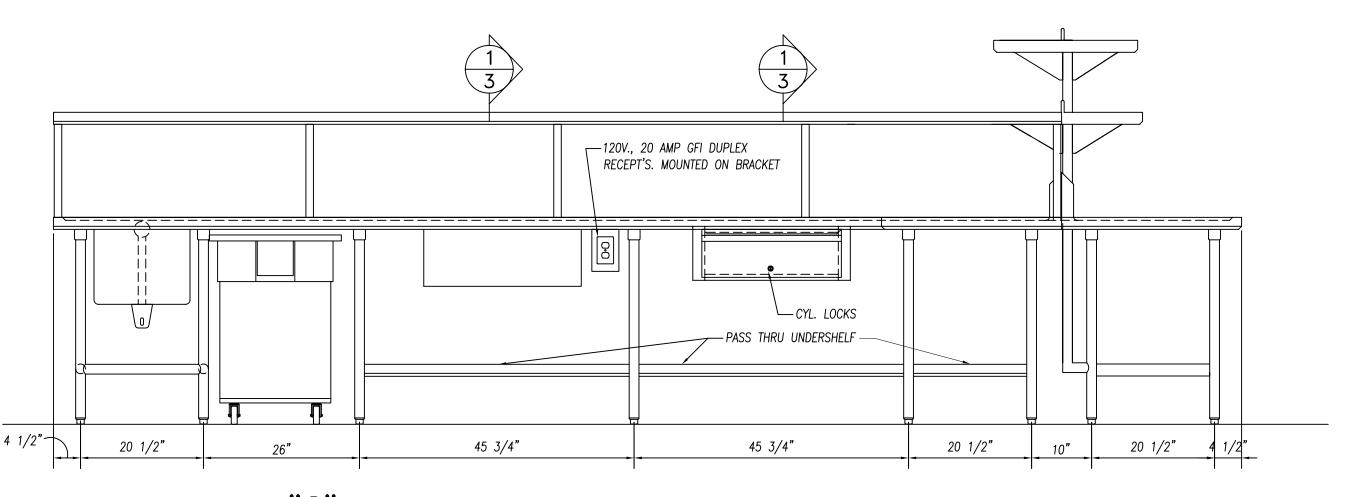



 $\frac{\text{ELEVATION "C"}}{3/4" = 1'-0"}$

3/4" = 1'-0"

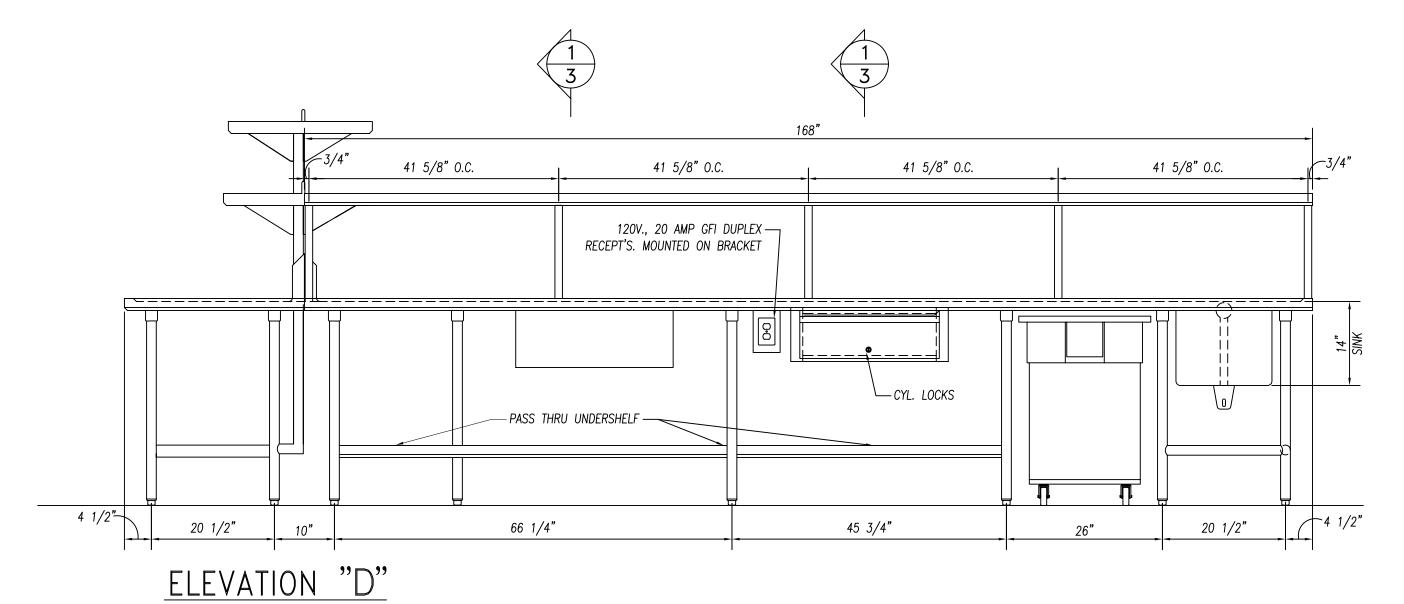

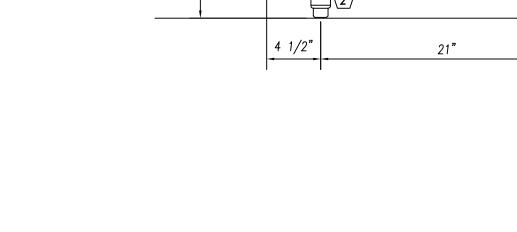


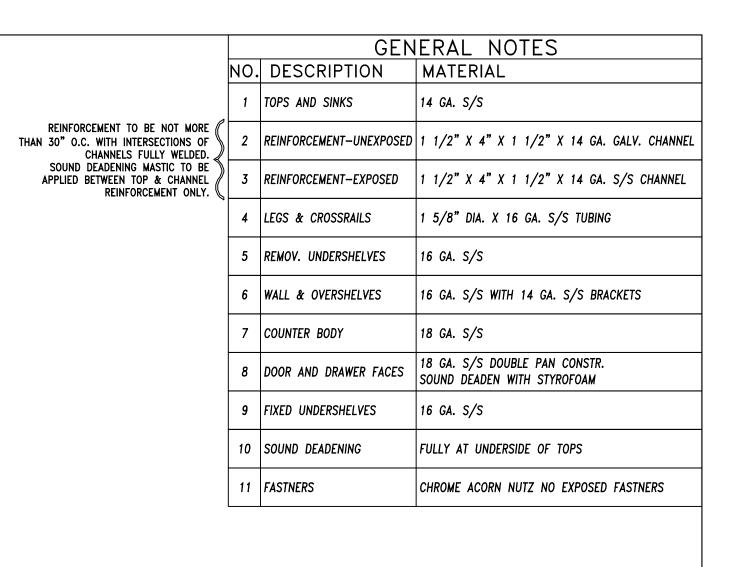


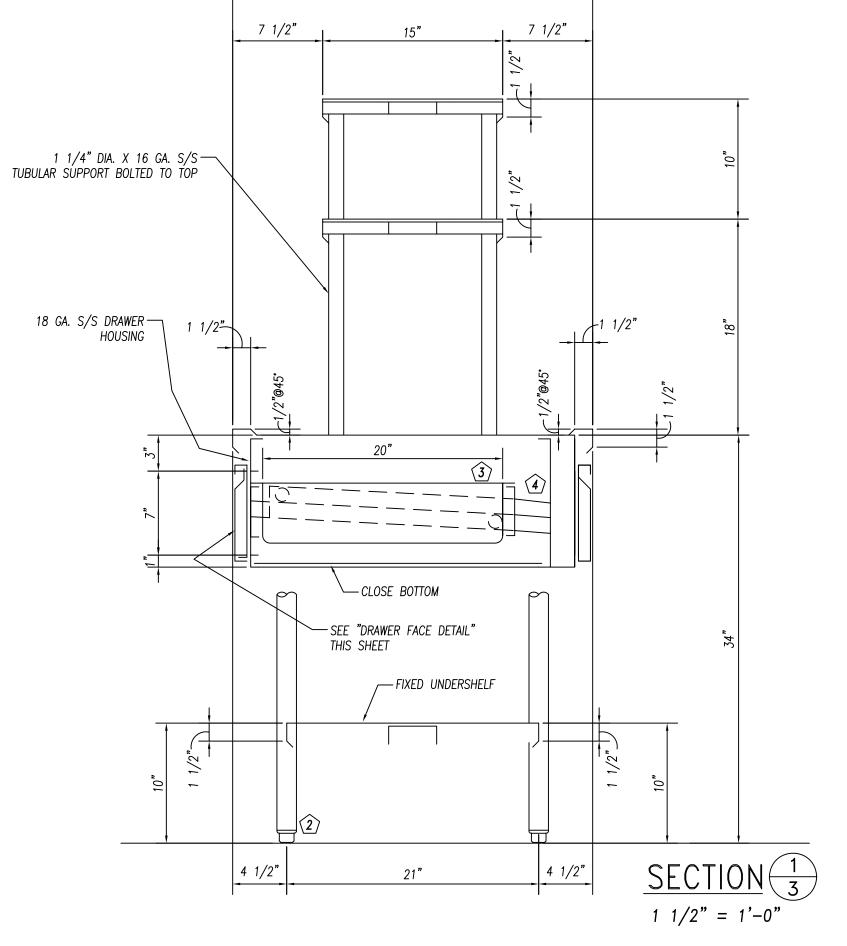



		PARTS	LIST		
ID.#	QTY.	DESCRIPTION	MFG. & MODEL NUMBE		
1	36	S/S GUSSETS	COMPONENT HARDWARE #A18-0206		
2	36	S/S BULLET FEET	COMPONENT HARDWARE #A10-0851		
		BUYOUT	LIST		
ID.#	QTY.	DESCRIPTION	MFG. & MODEL NUMBE		
1	4	LEVER DRAIN W/O'FLOW	T & S #B-3970-01		
2	1	DECK MTD. FAUCET	T & S #B-0201/B-0199-01 AERATOR		
3	2	SPLASH MTD. FAUCET	T & S #B-0231/B-0199-01 AERATOR		
These Items <u>ARE NOT PROVIDED BY NATIONWIDE</u>					
🛨 Item	ns Tha	t <u>Must</u> Be Shipped	To Nationwide For Installation		


			★ Items That <u>Must</u> Be Shipped To Nationwide F	or Installation
		UL LISTED	10923 LEROY DRIVE Fabrication, Inc. PHONE: (303) 853-0107 NORTHGLENN, CO. 80233 FAX: (303) 853-0114	THE PARTY OF THE P
	AS-BUILT 07.18.11	DATE: 2-22-10	PROJECT: JOLIET JR. COLLEGE	
	REVISIONS:	DRAWN BY: CUSHING	Joliet, IL	
		CHECKED BY:	CUSTOMER: EDWARD DON	PAGE NUMBER
		SCALE: AS NOTED	North Riverside, IL	3 OF 24
ŀ	CONSULTANT:	ITEMS THIS SHEET:	, and the second	JOB NUMBER
	Mackesey And Associates LLC		ITEM:19 WORKTABLE, ITEM:20 OVERSHELF	5789
	Crystal Lake, IL	ITEI	M:27 WORKTABLE, ITEM:28 OVERSHELF, ITEM:29 OVERSHELF	

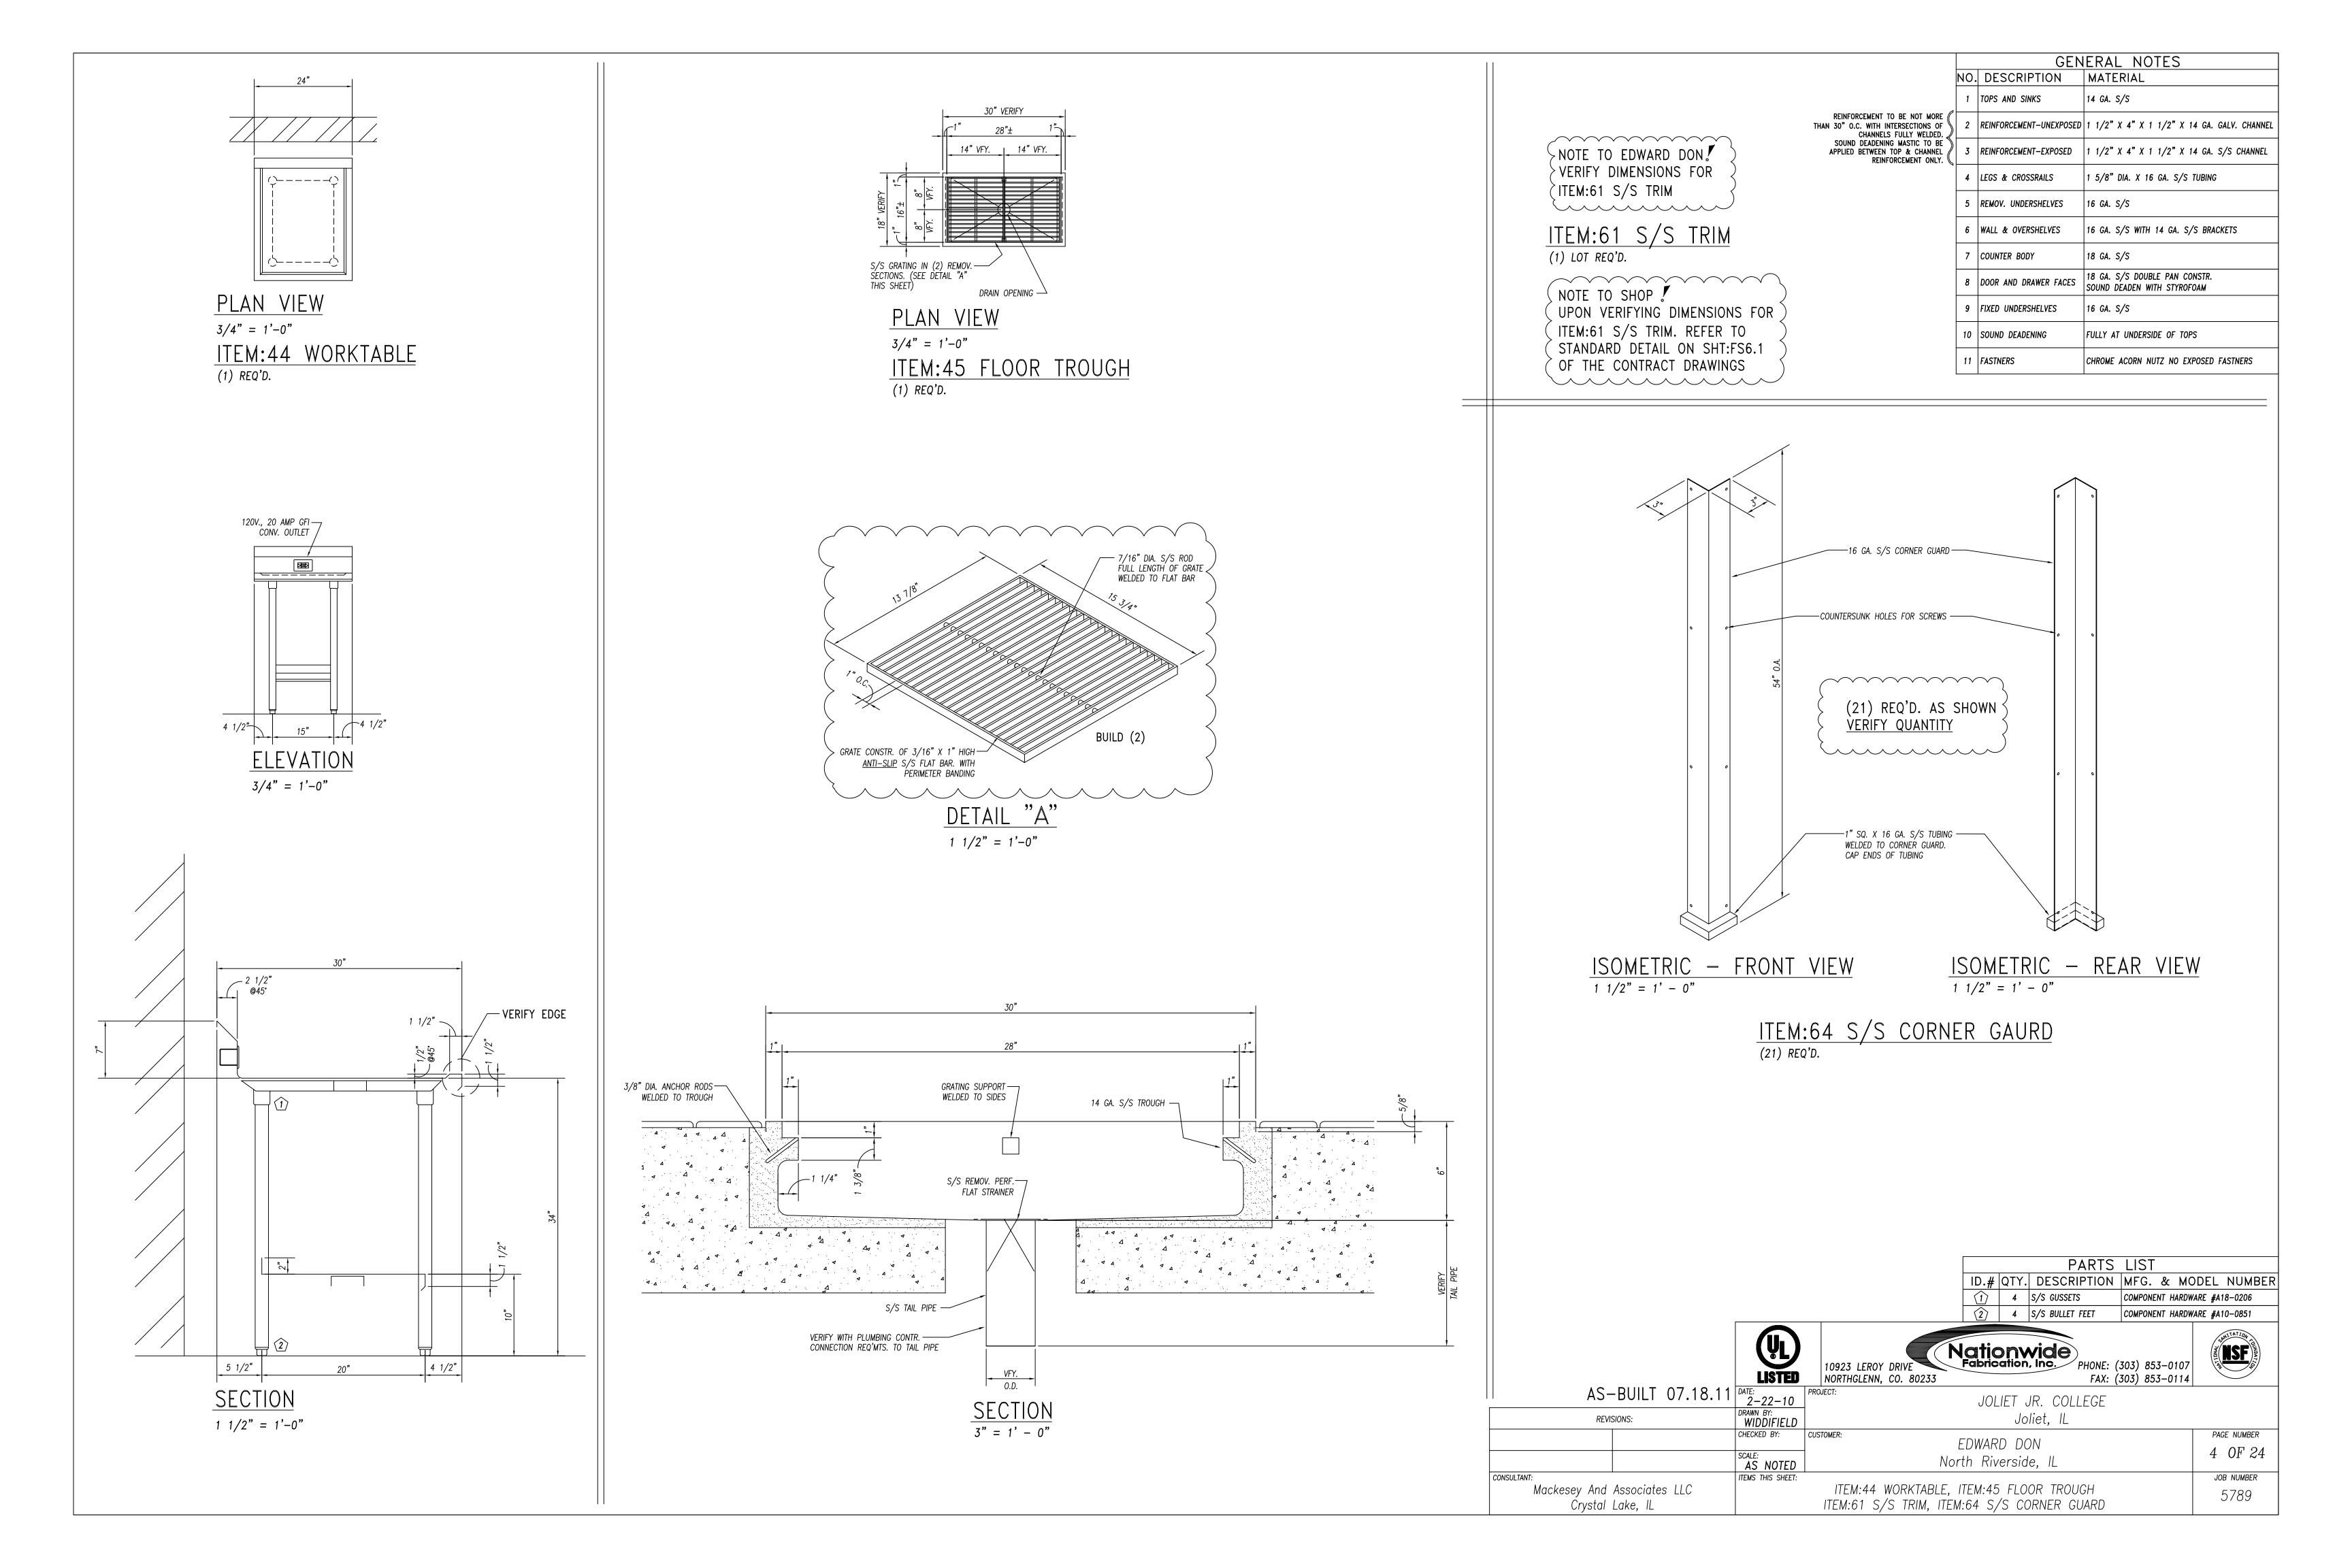


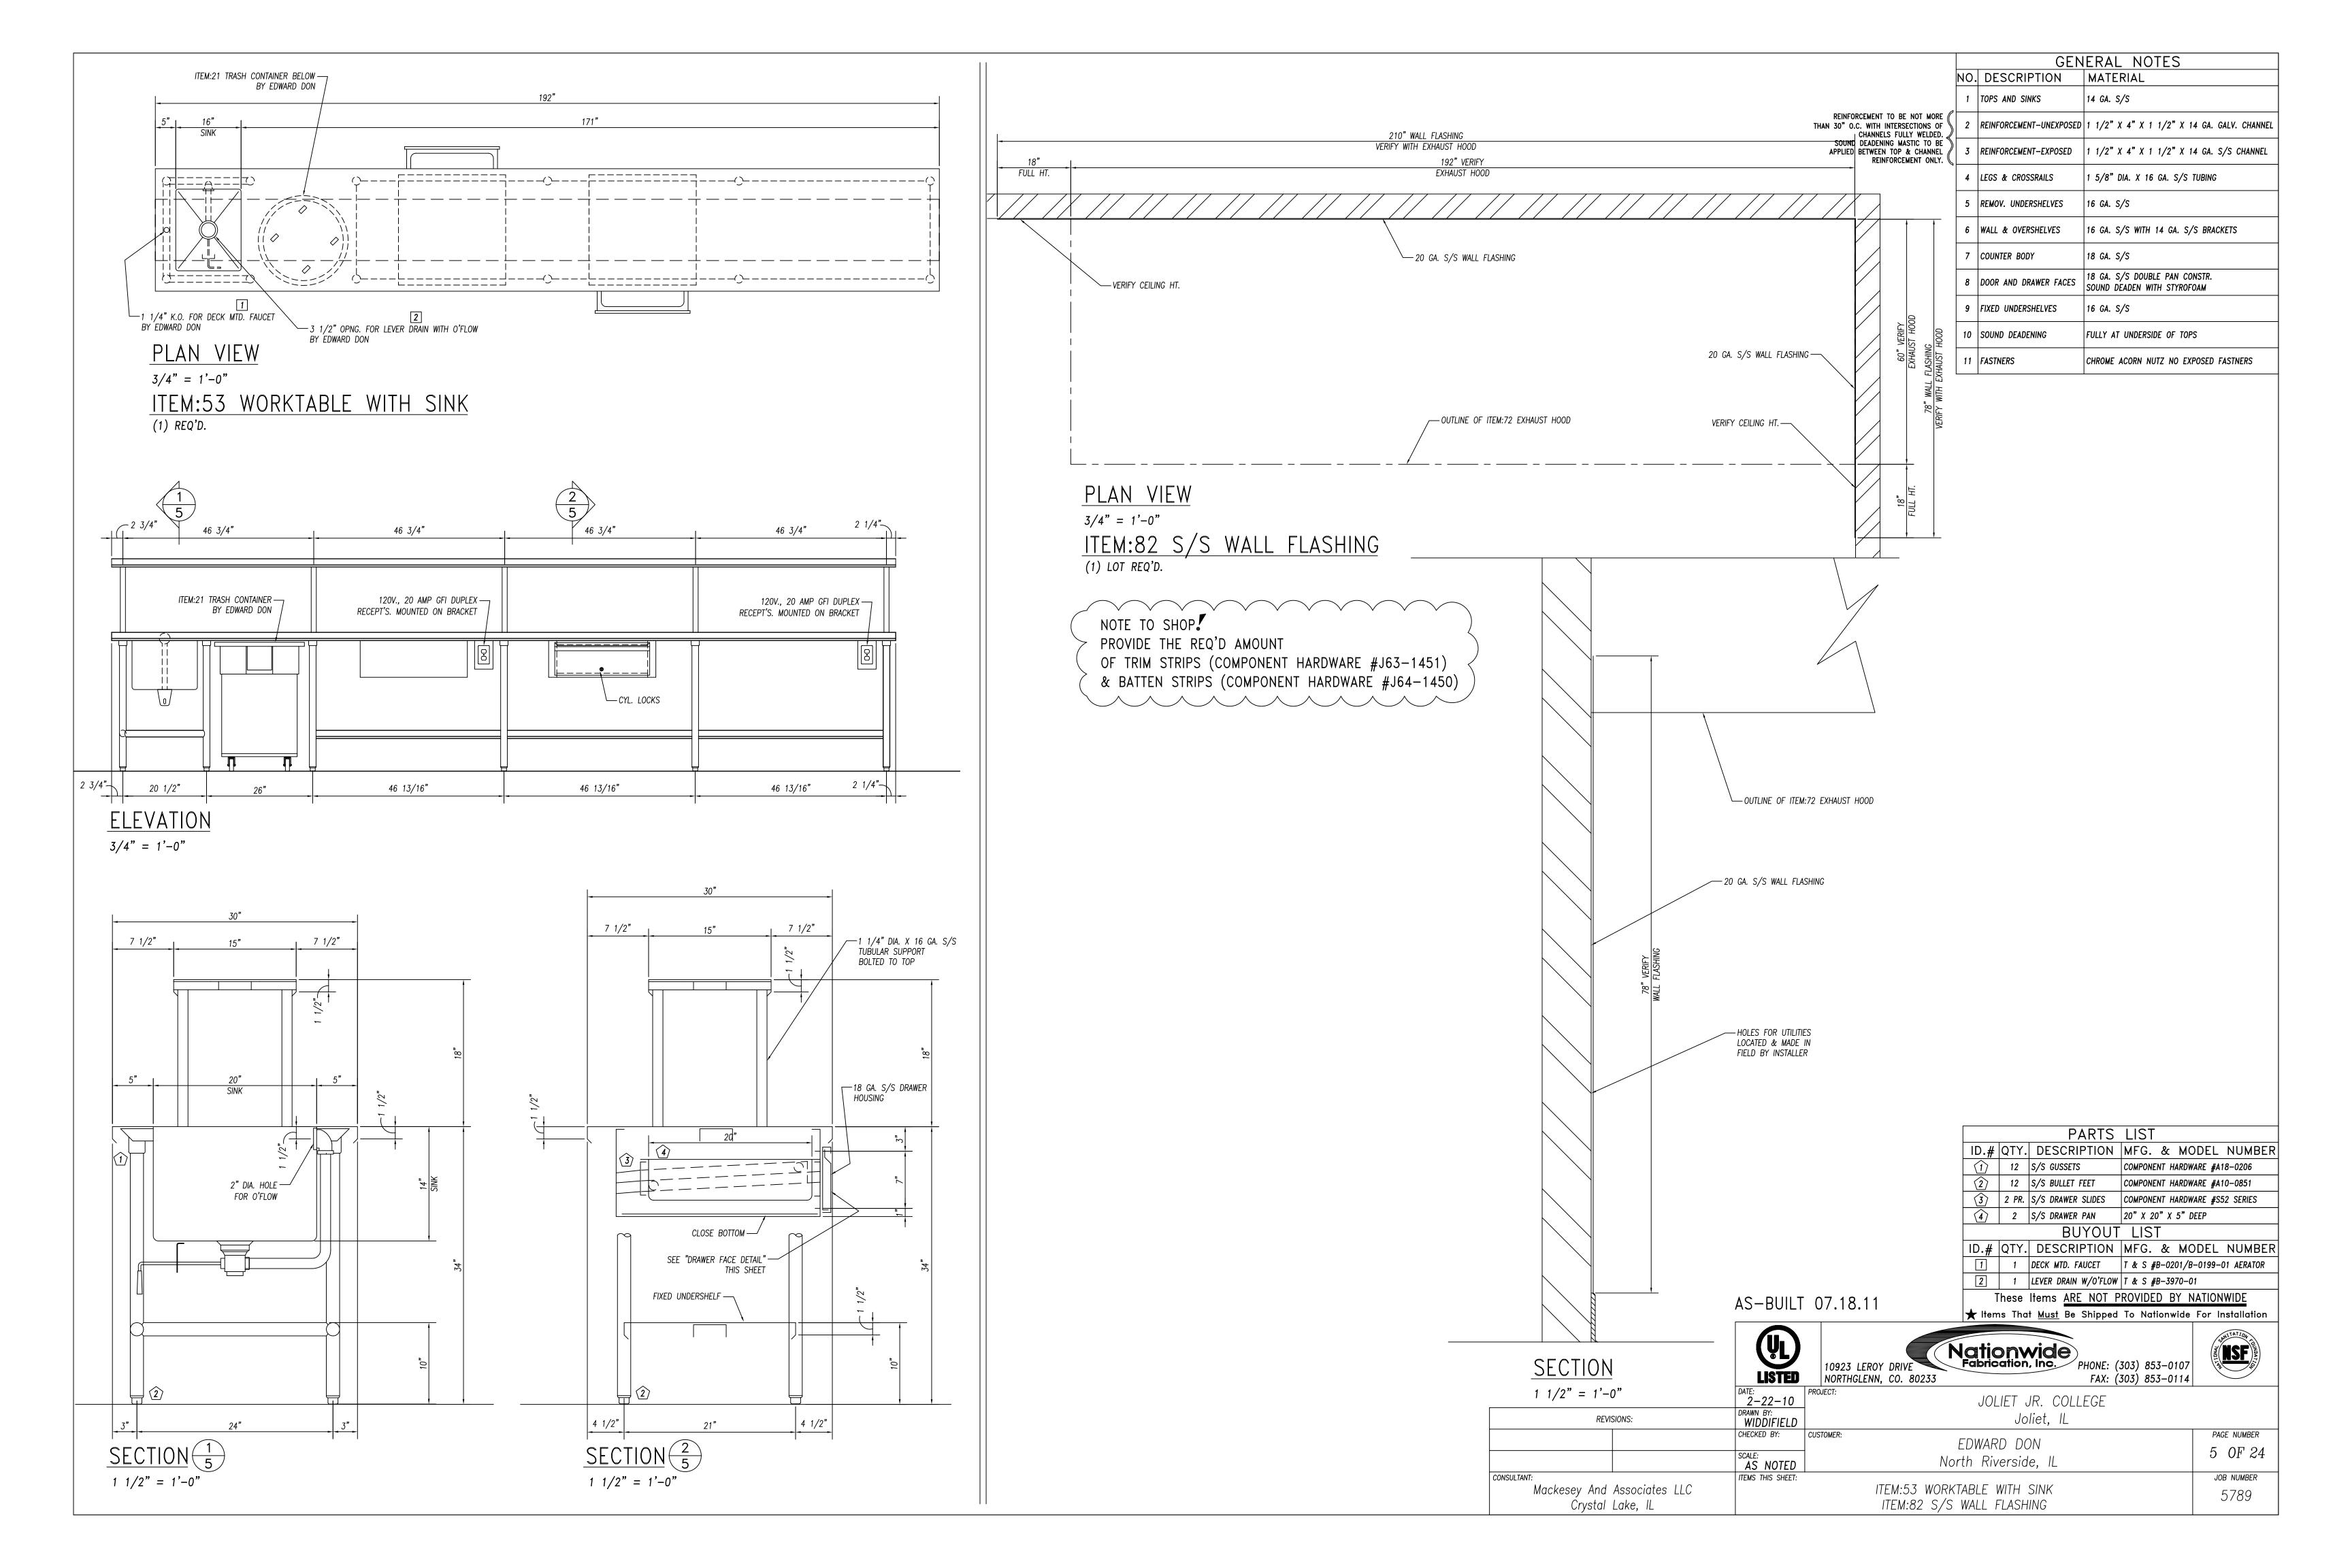


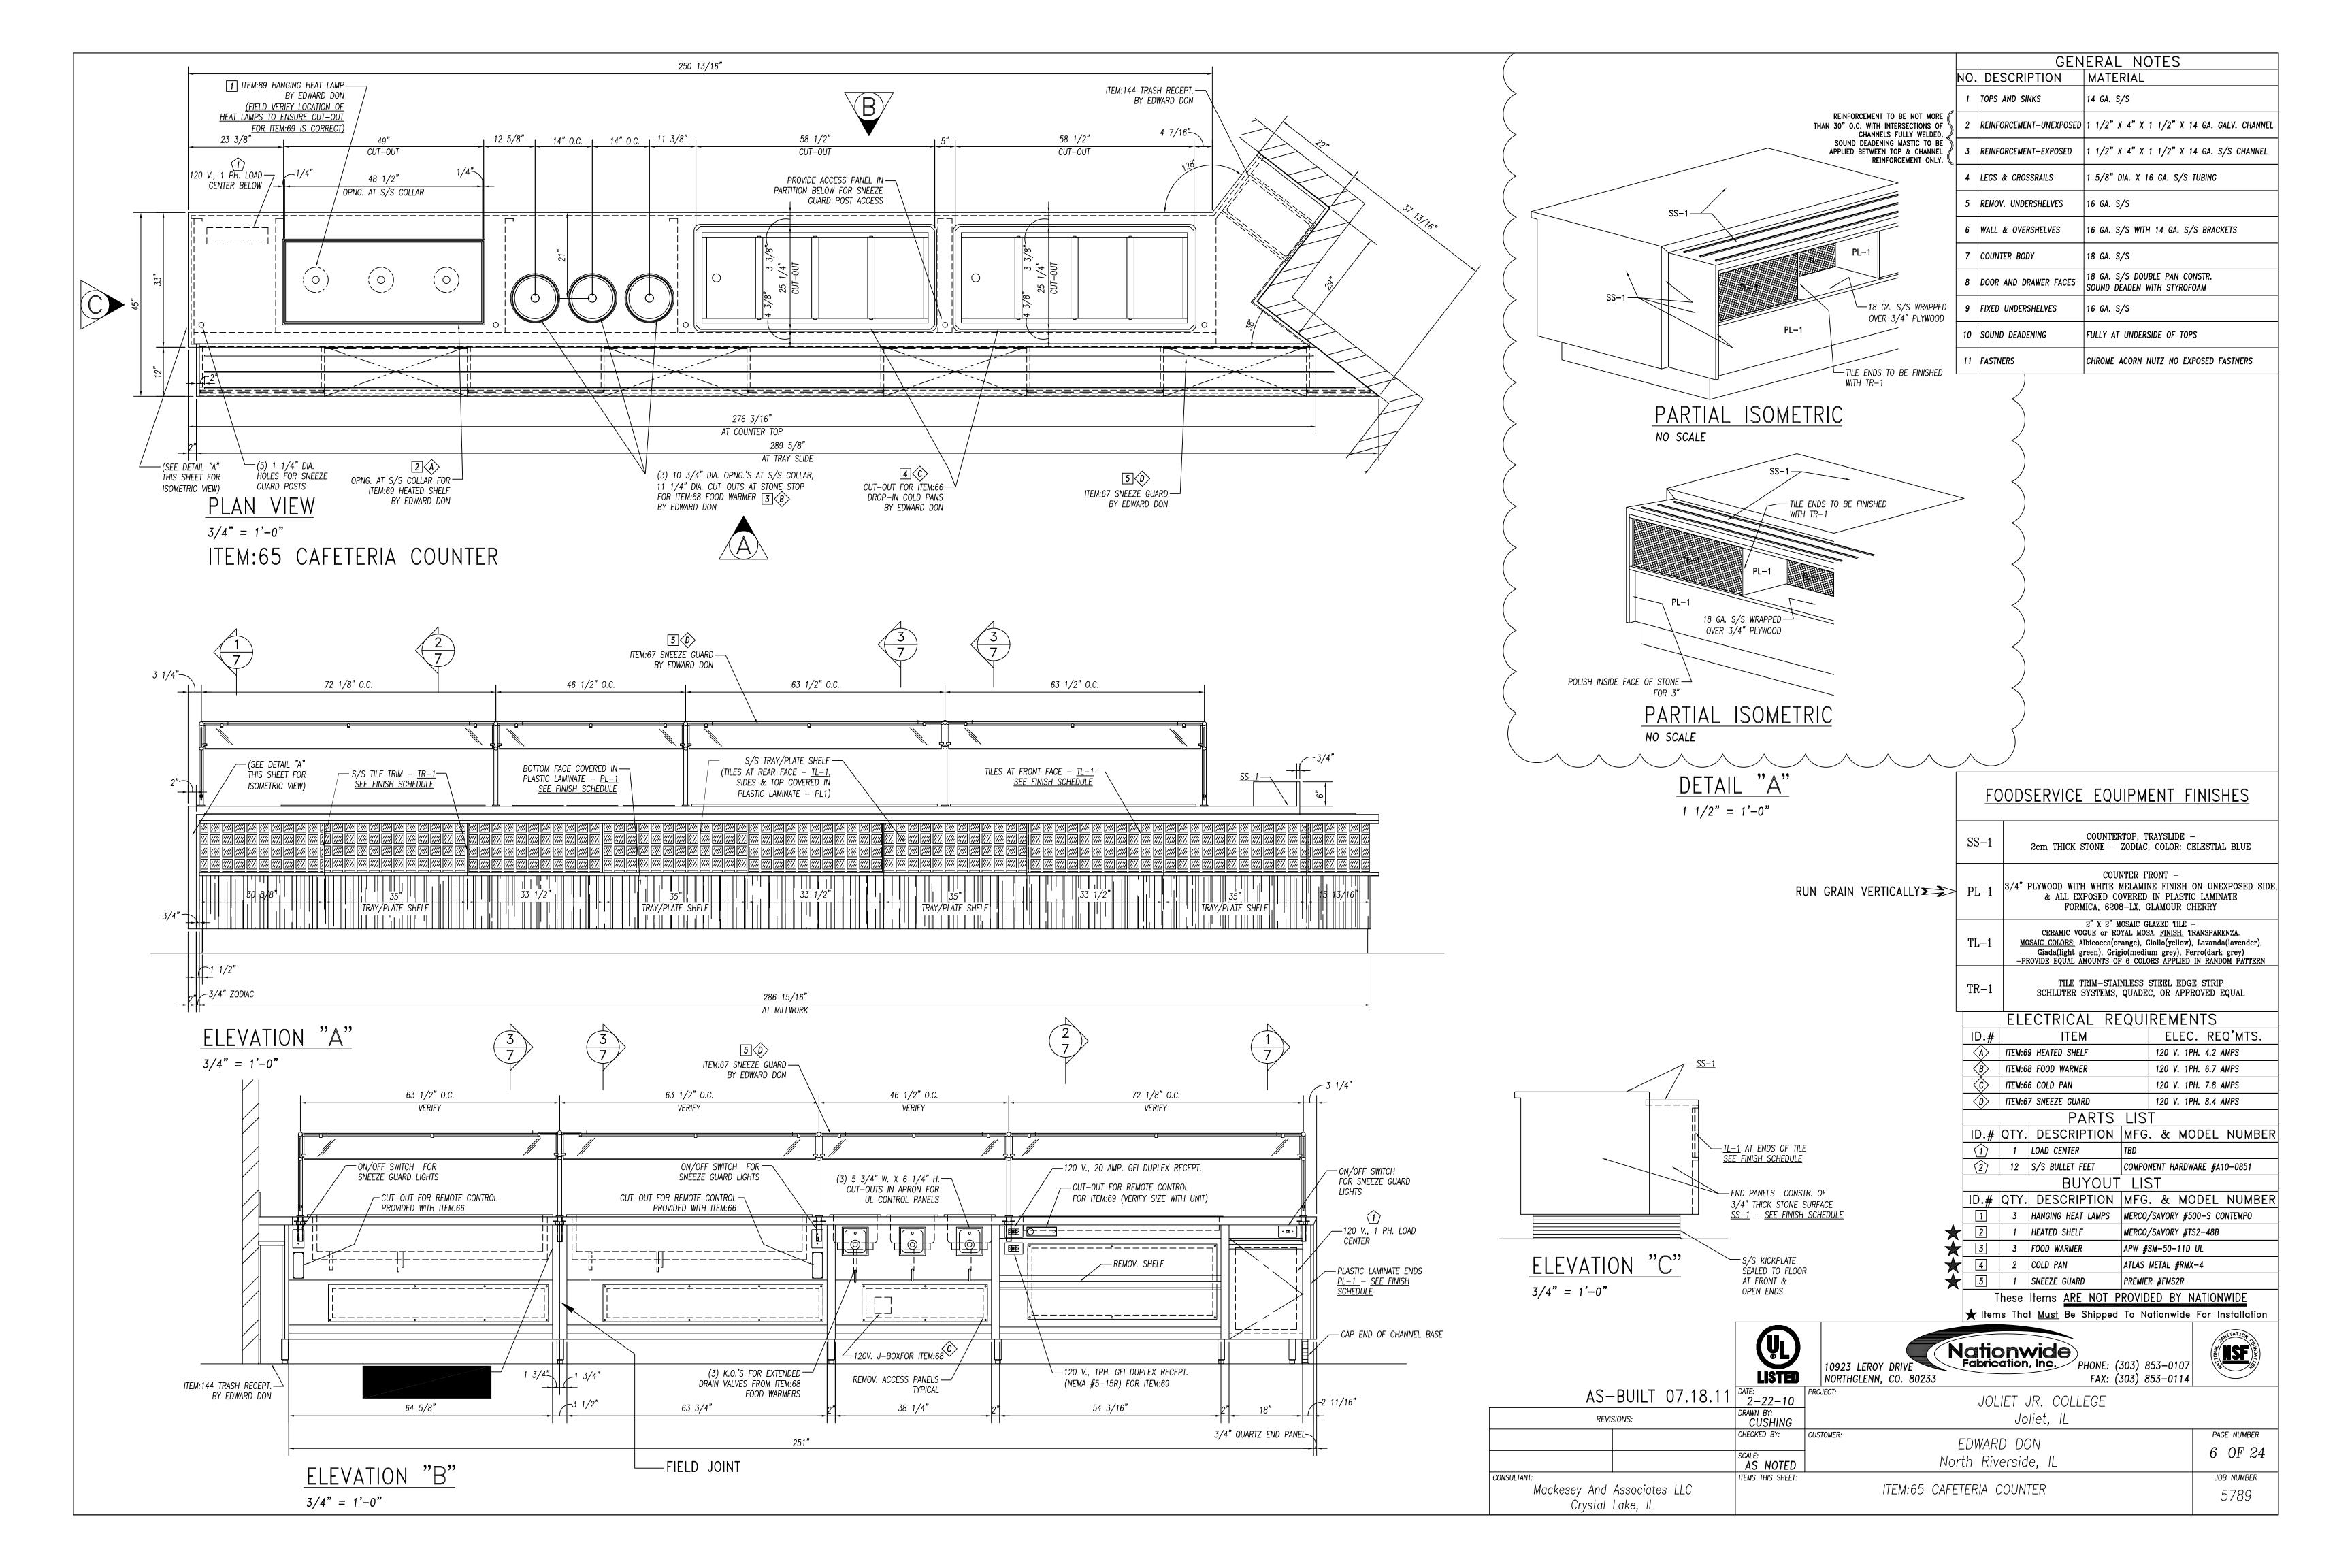


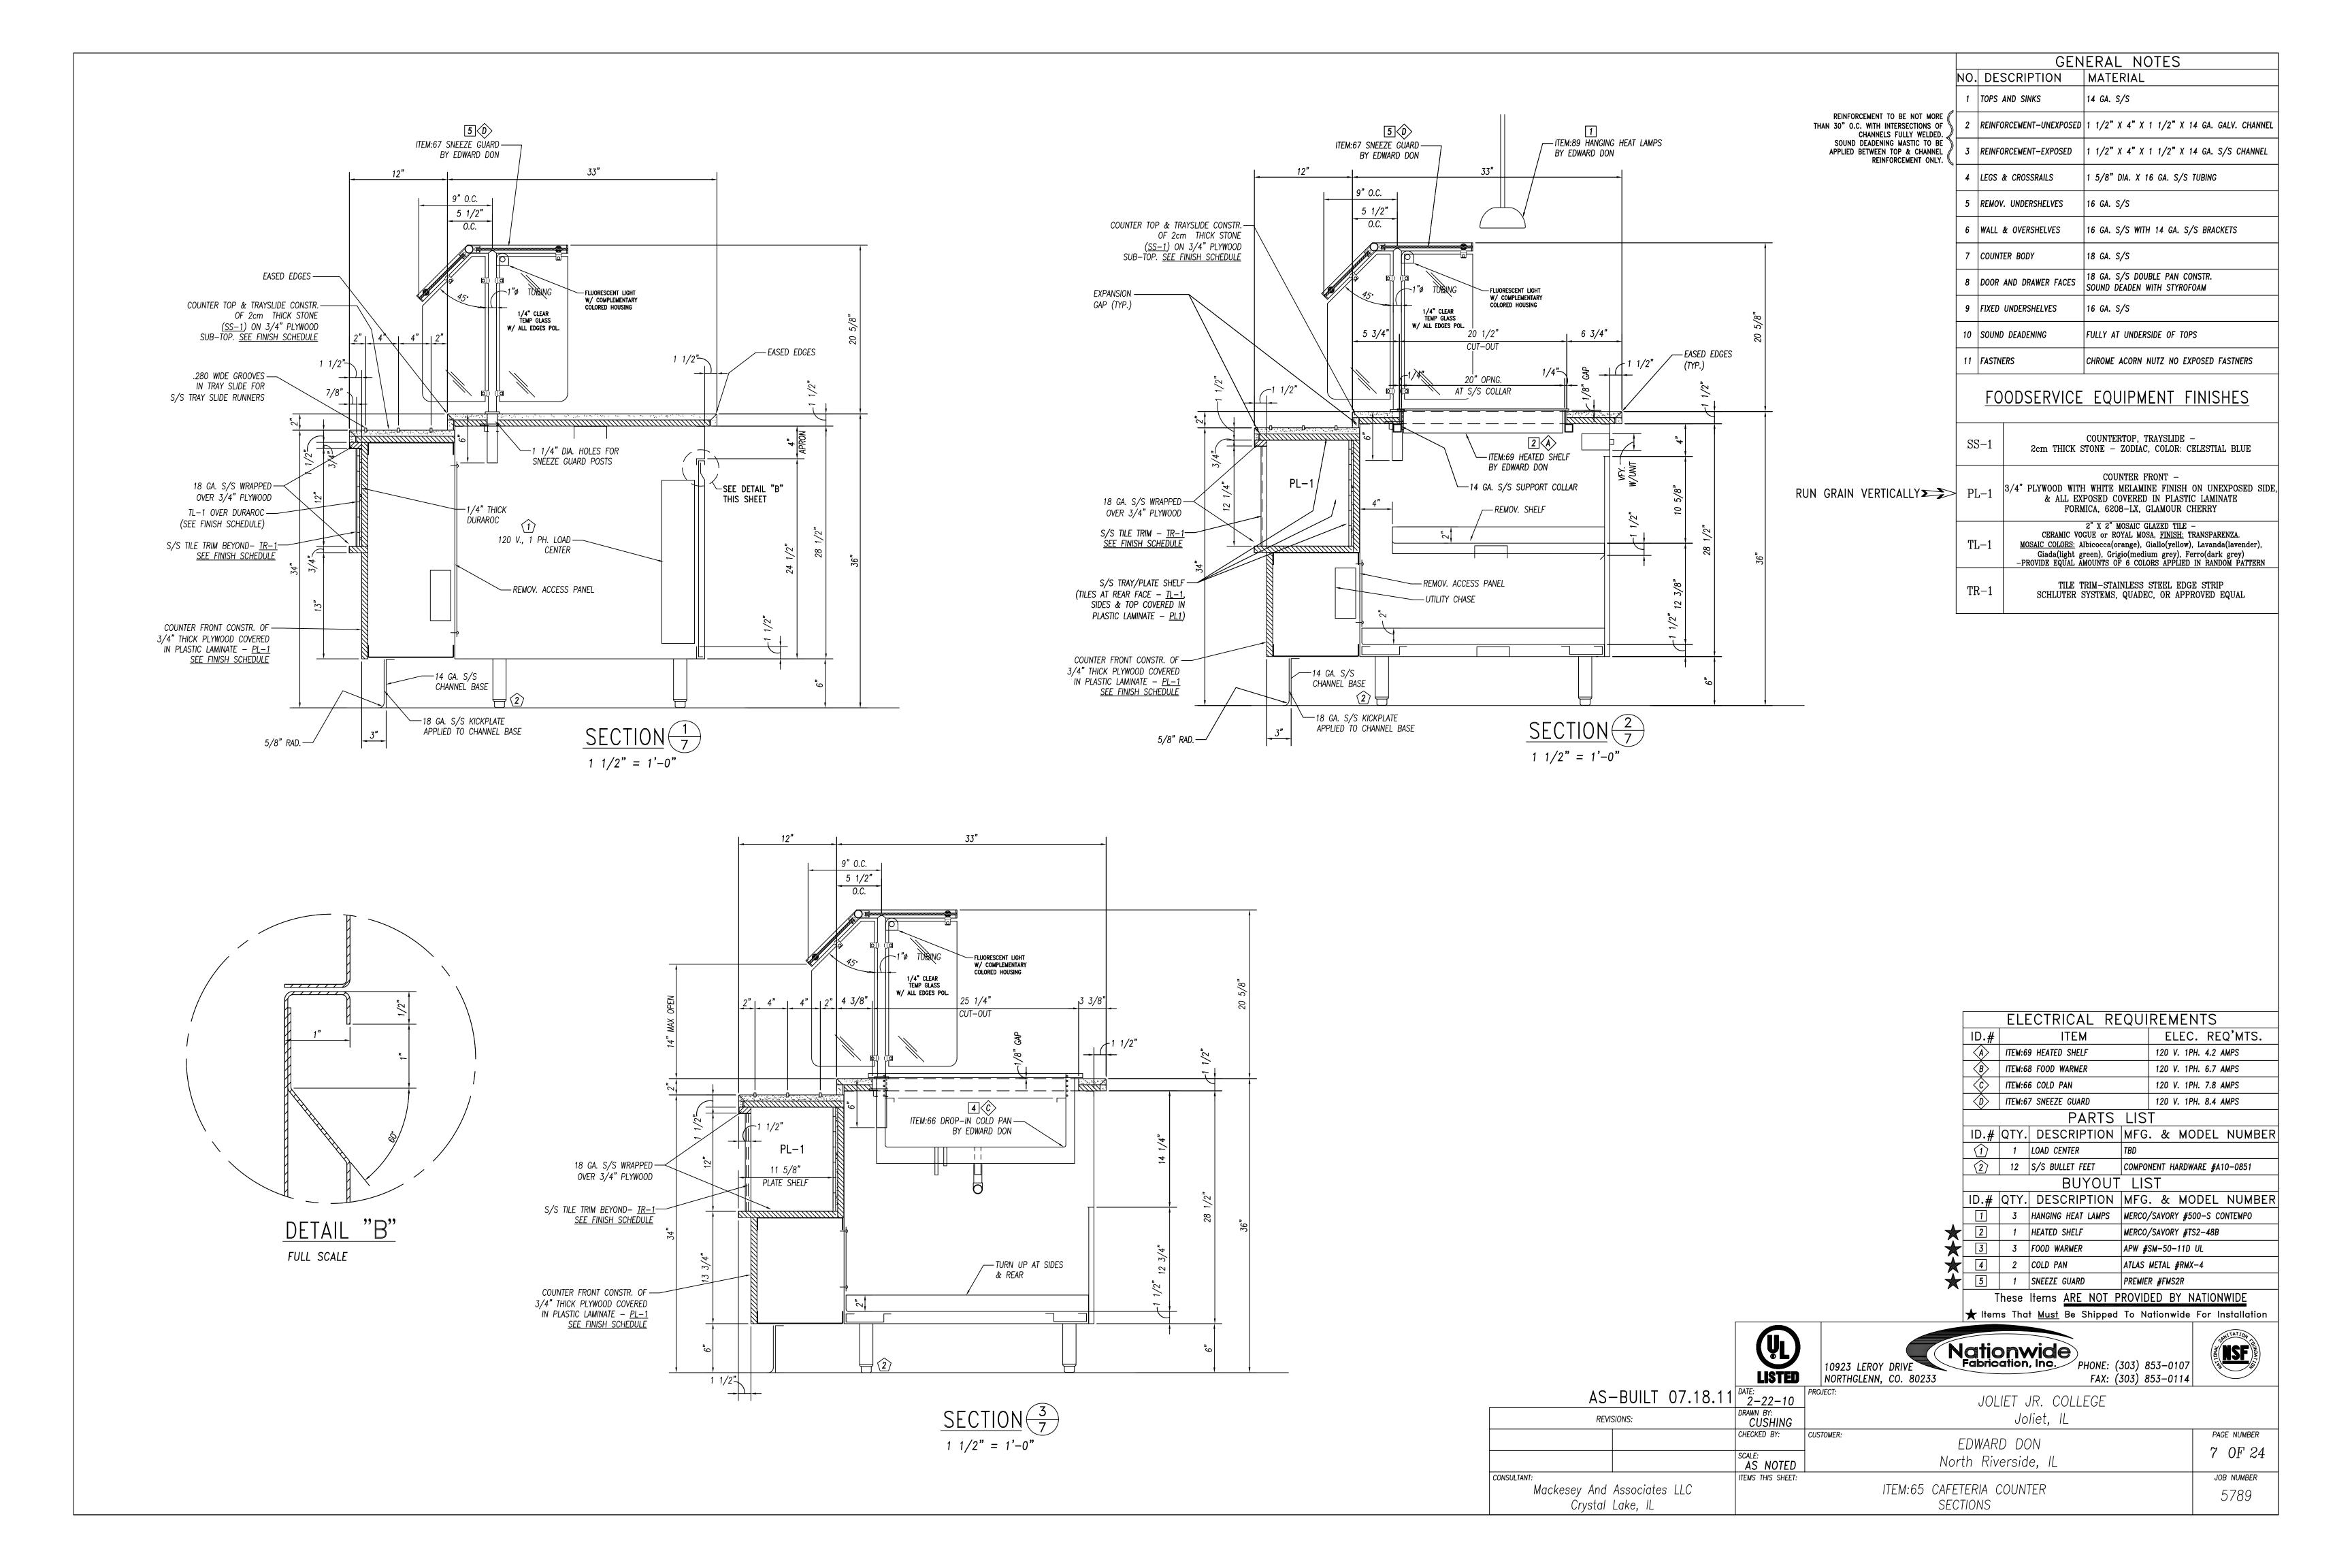


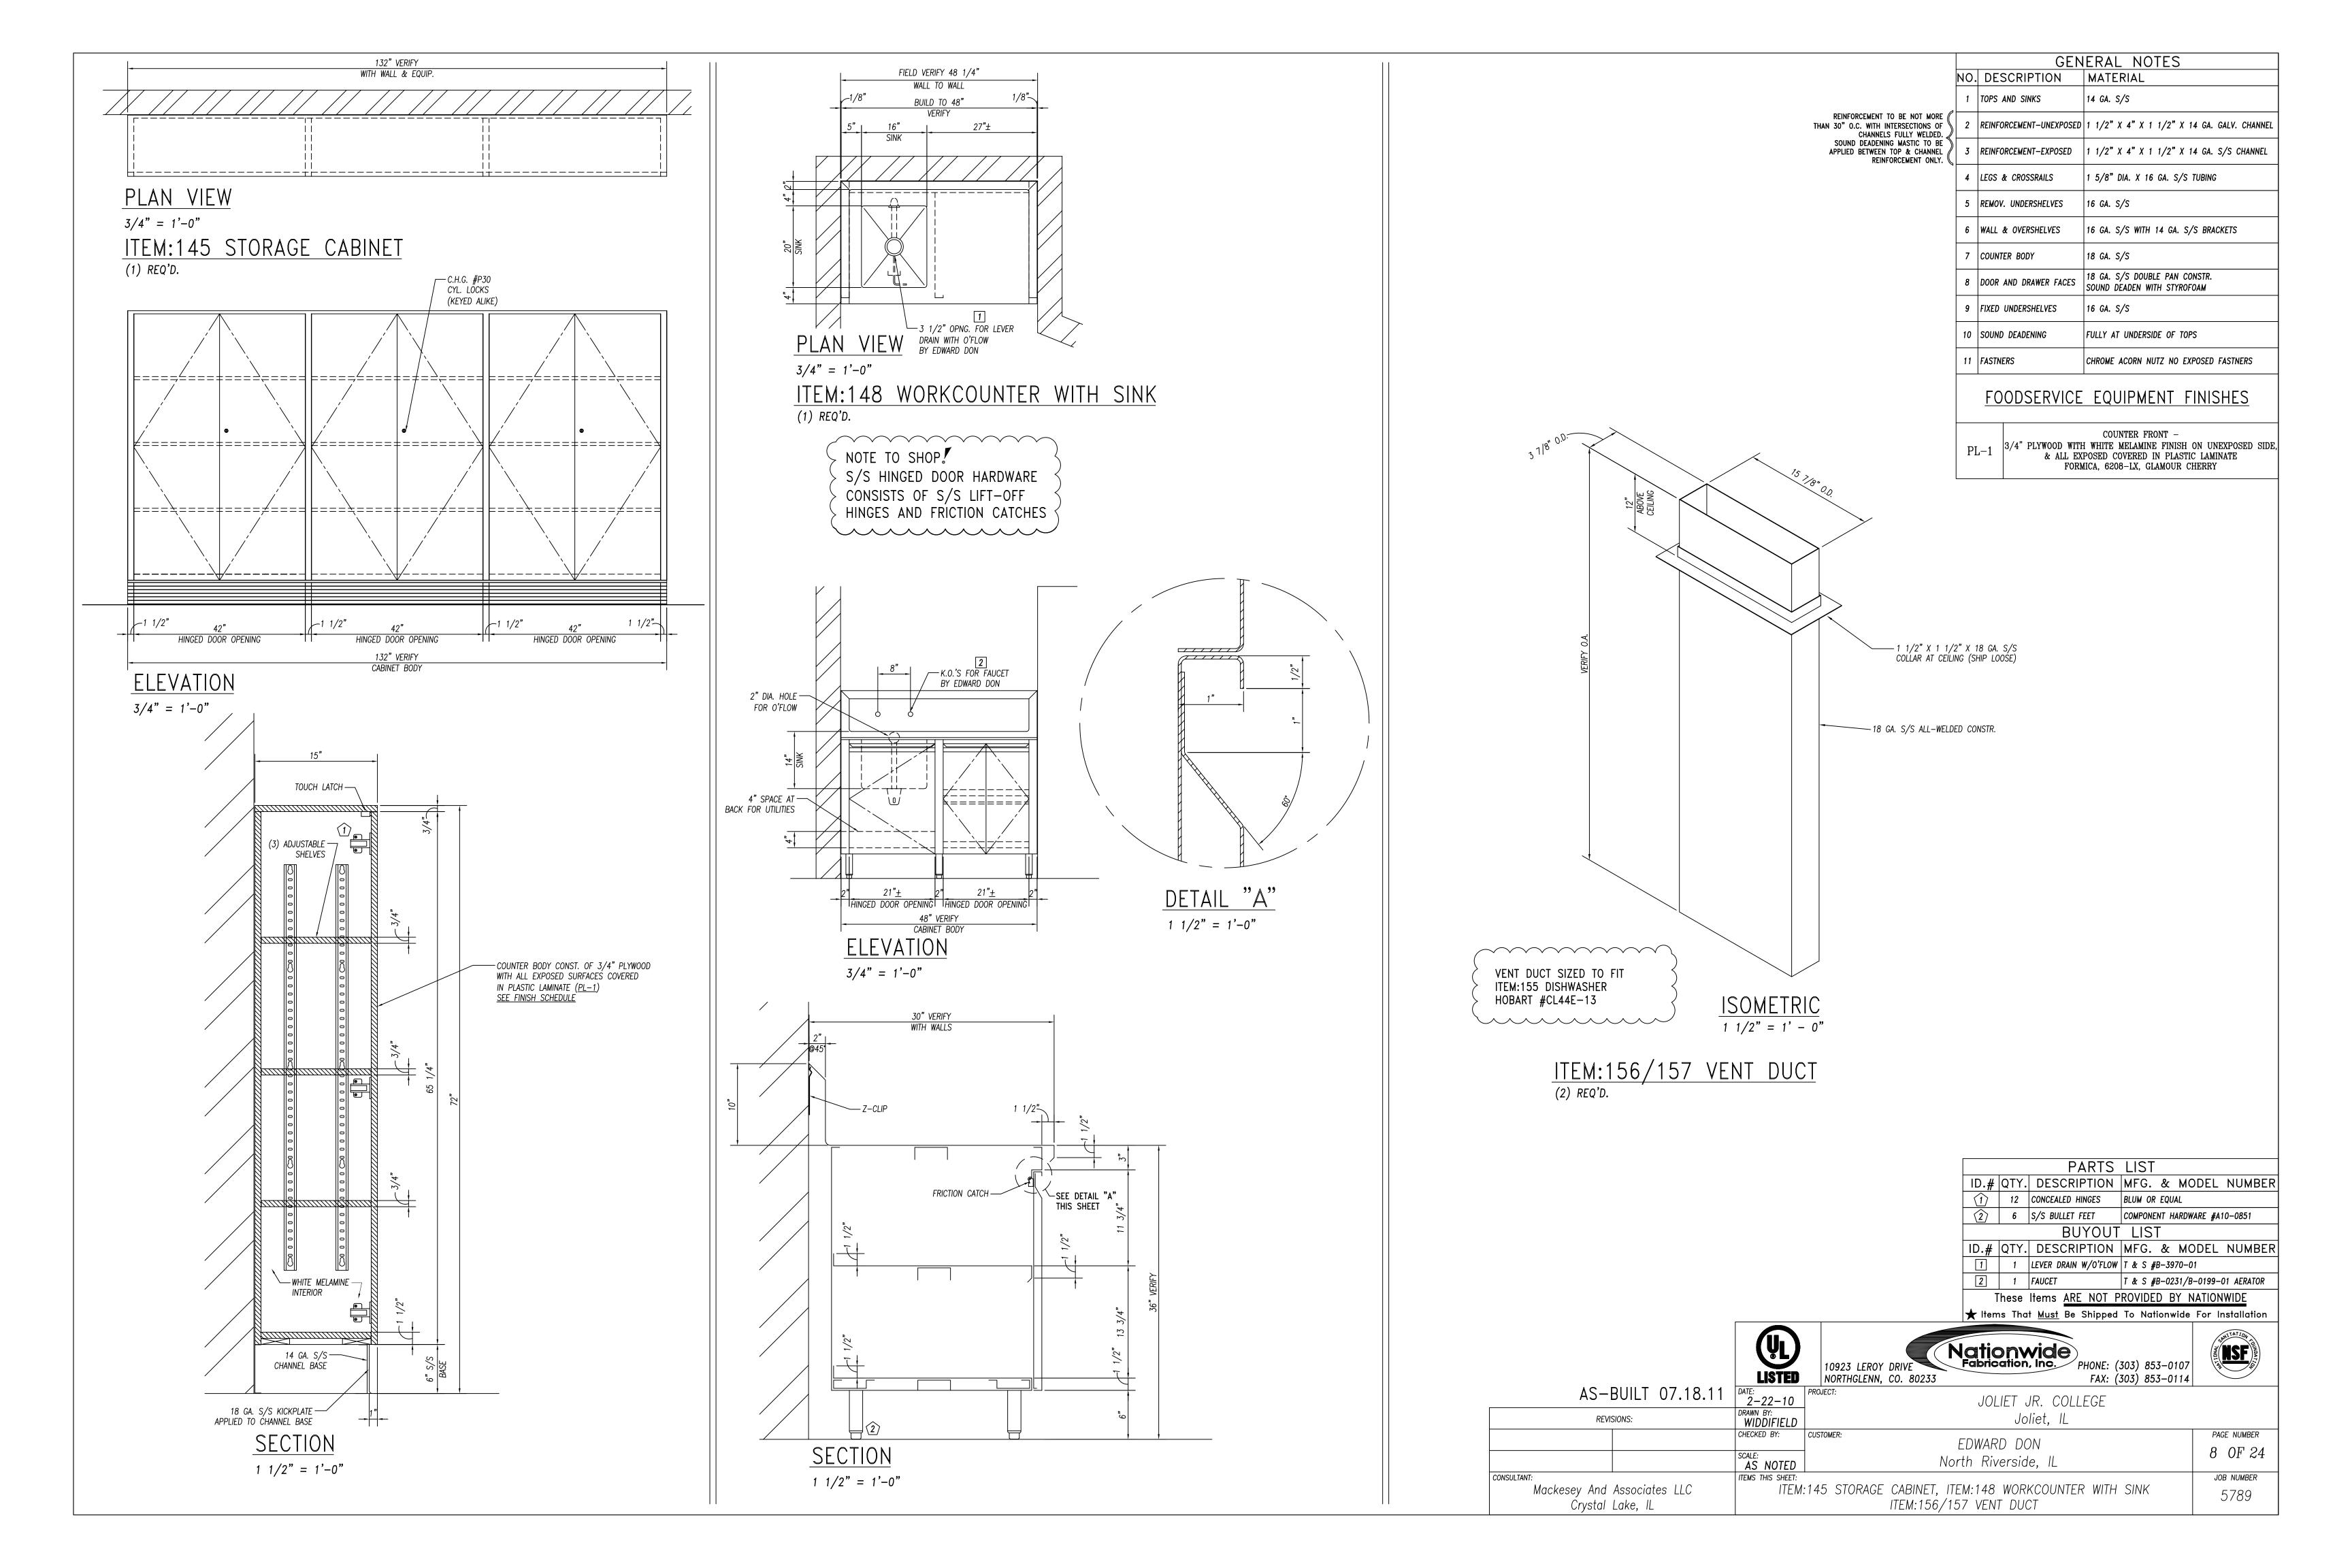


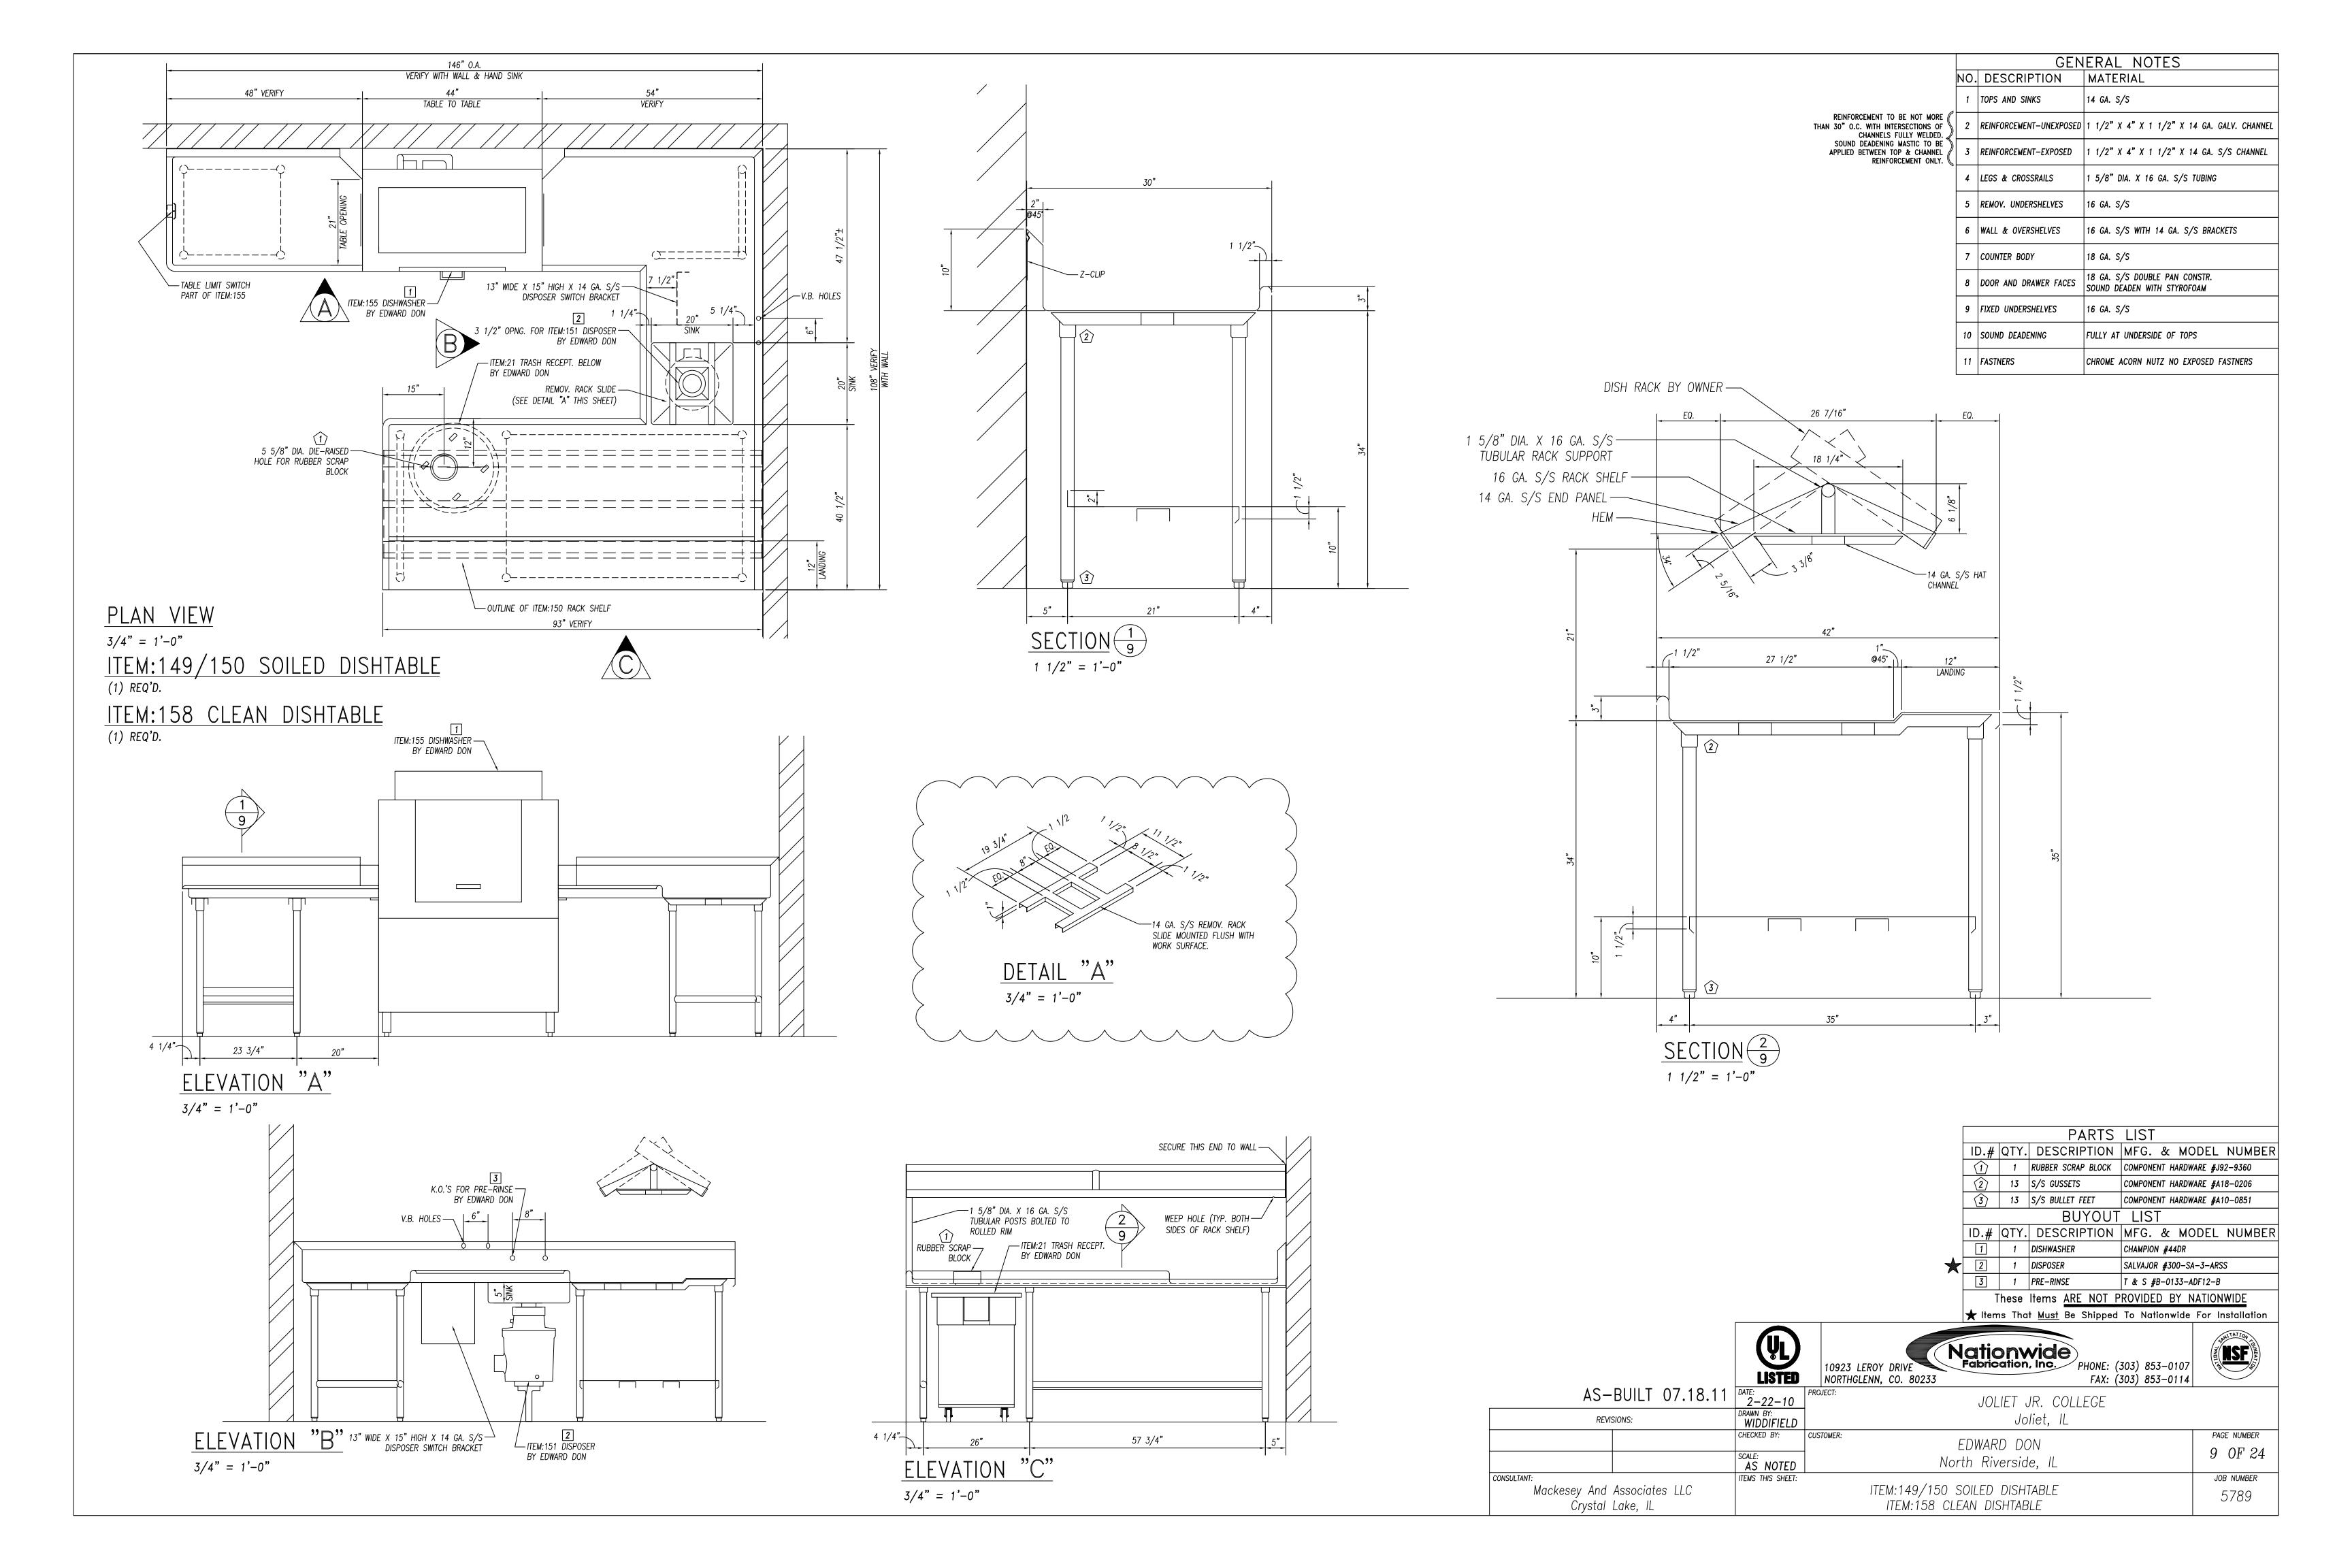


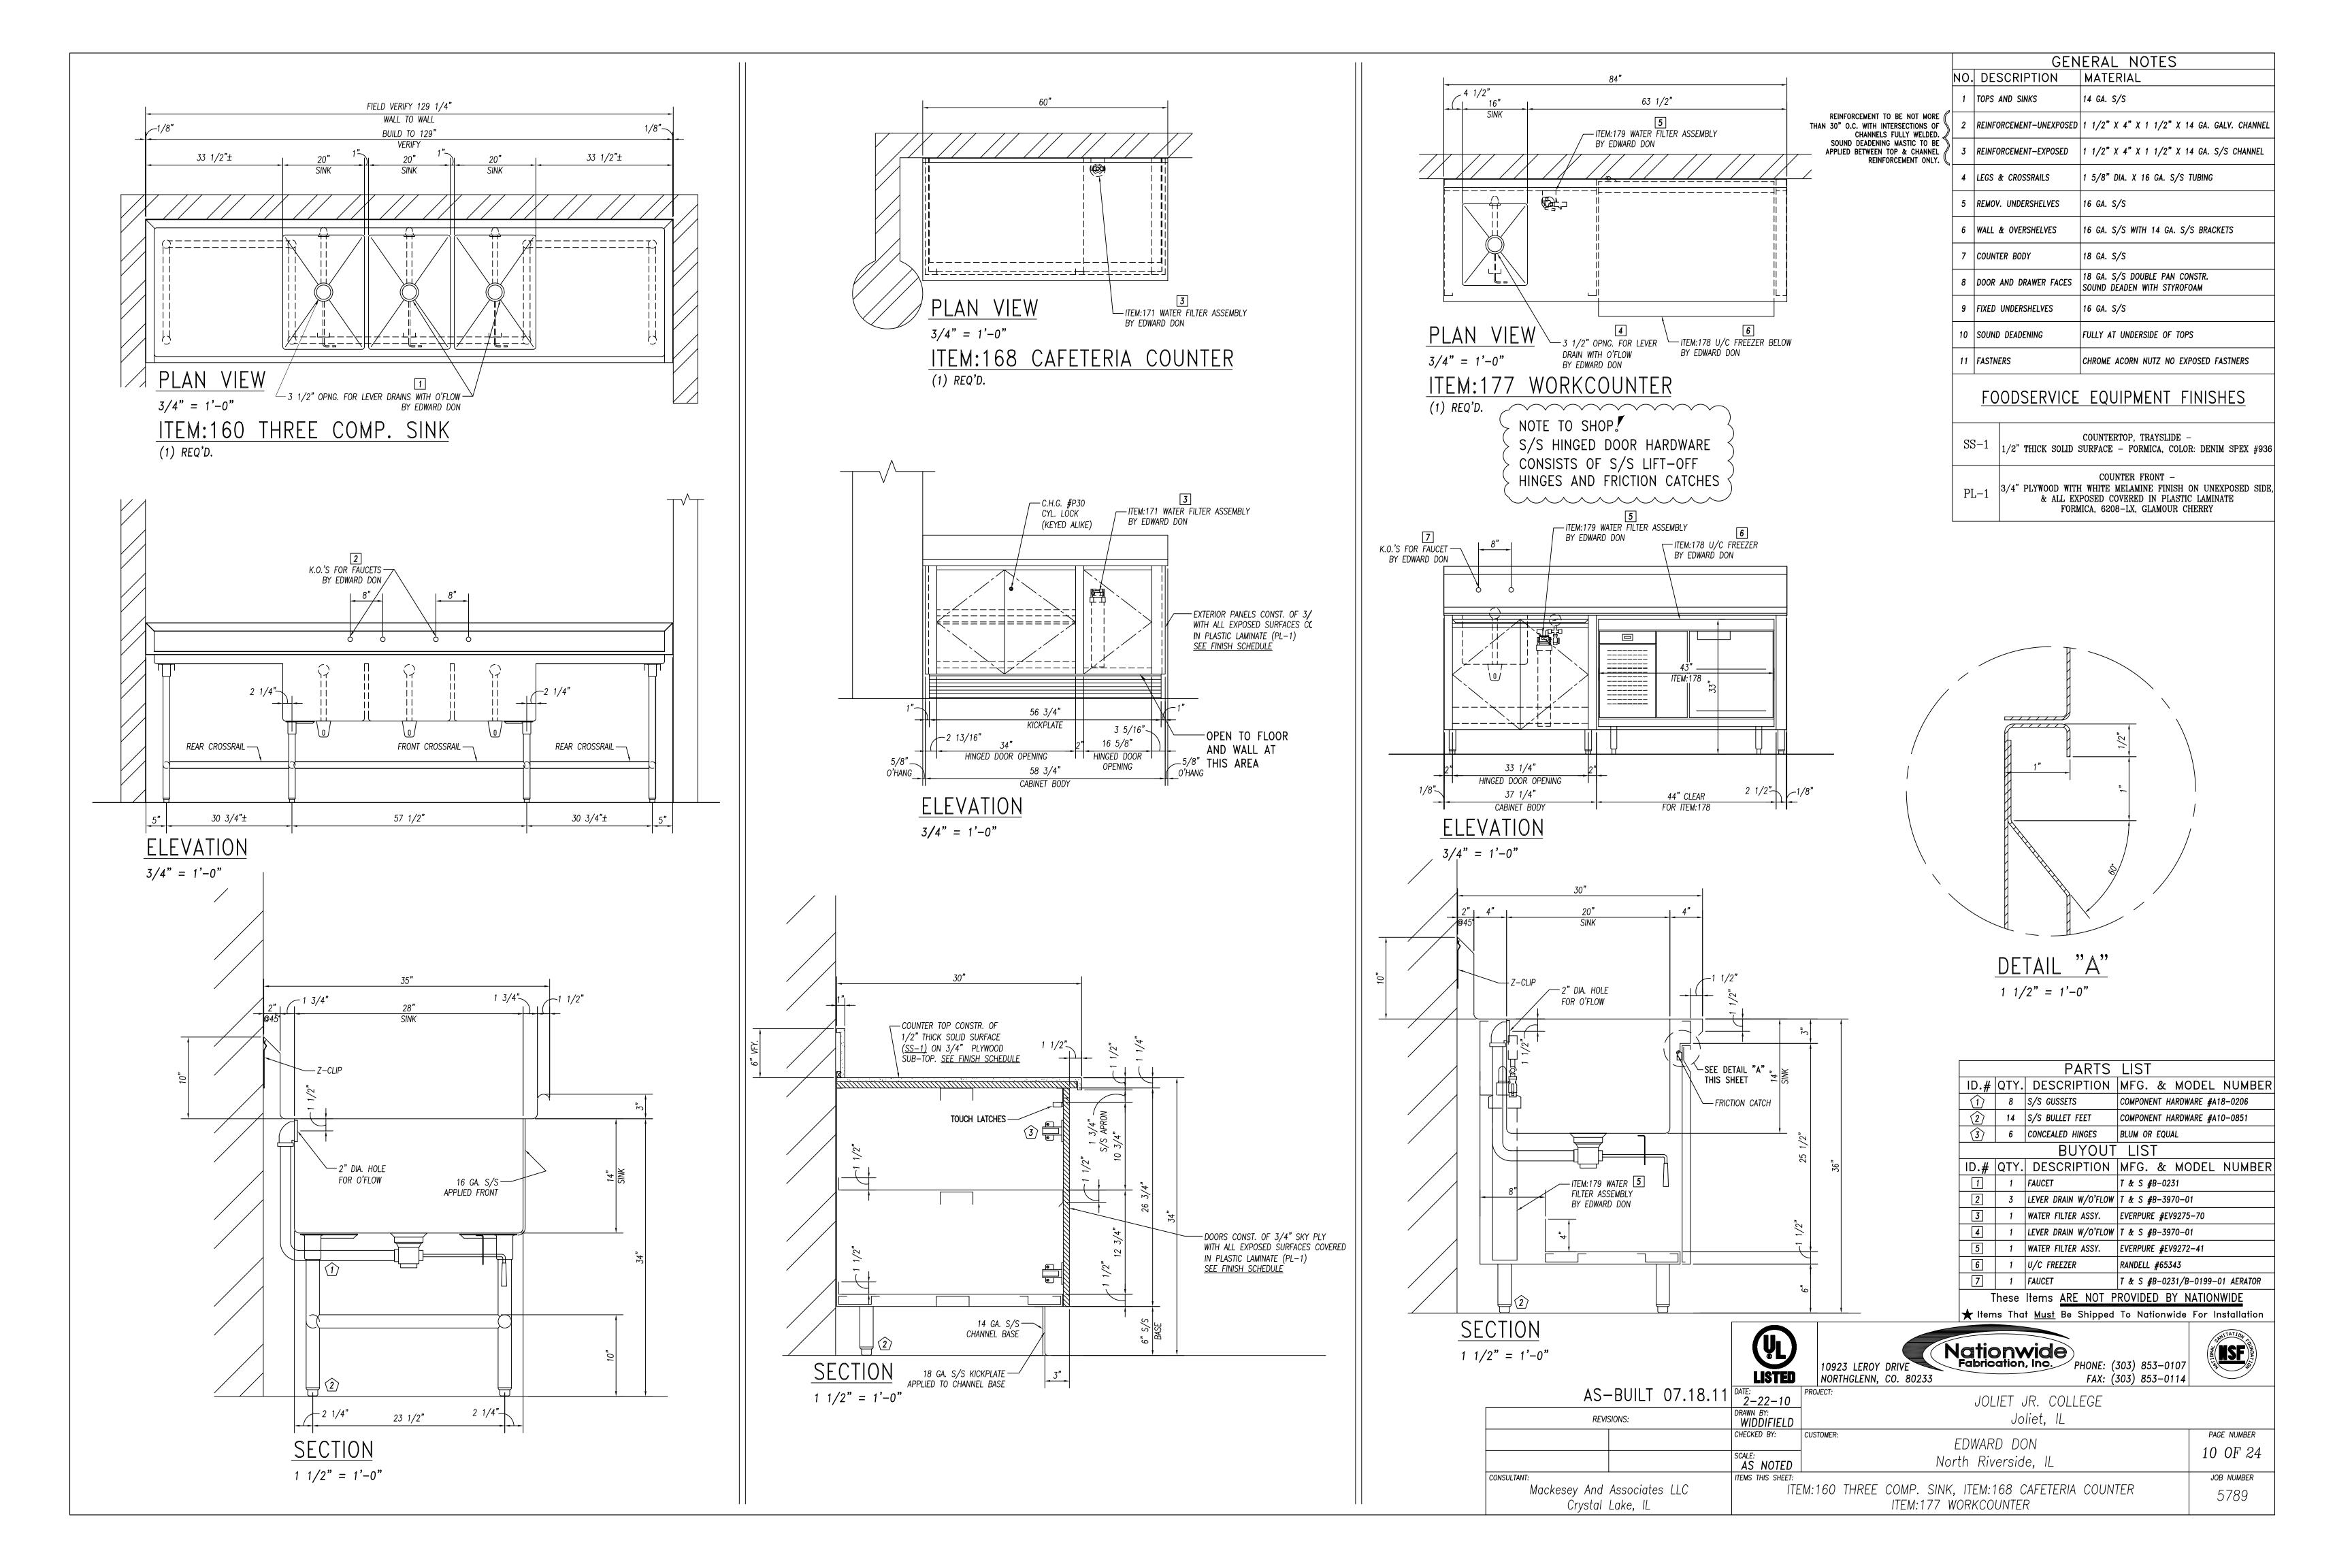


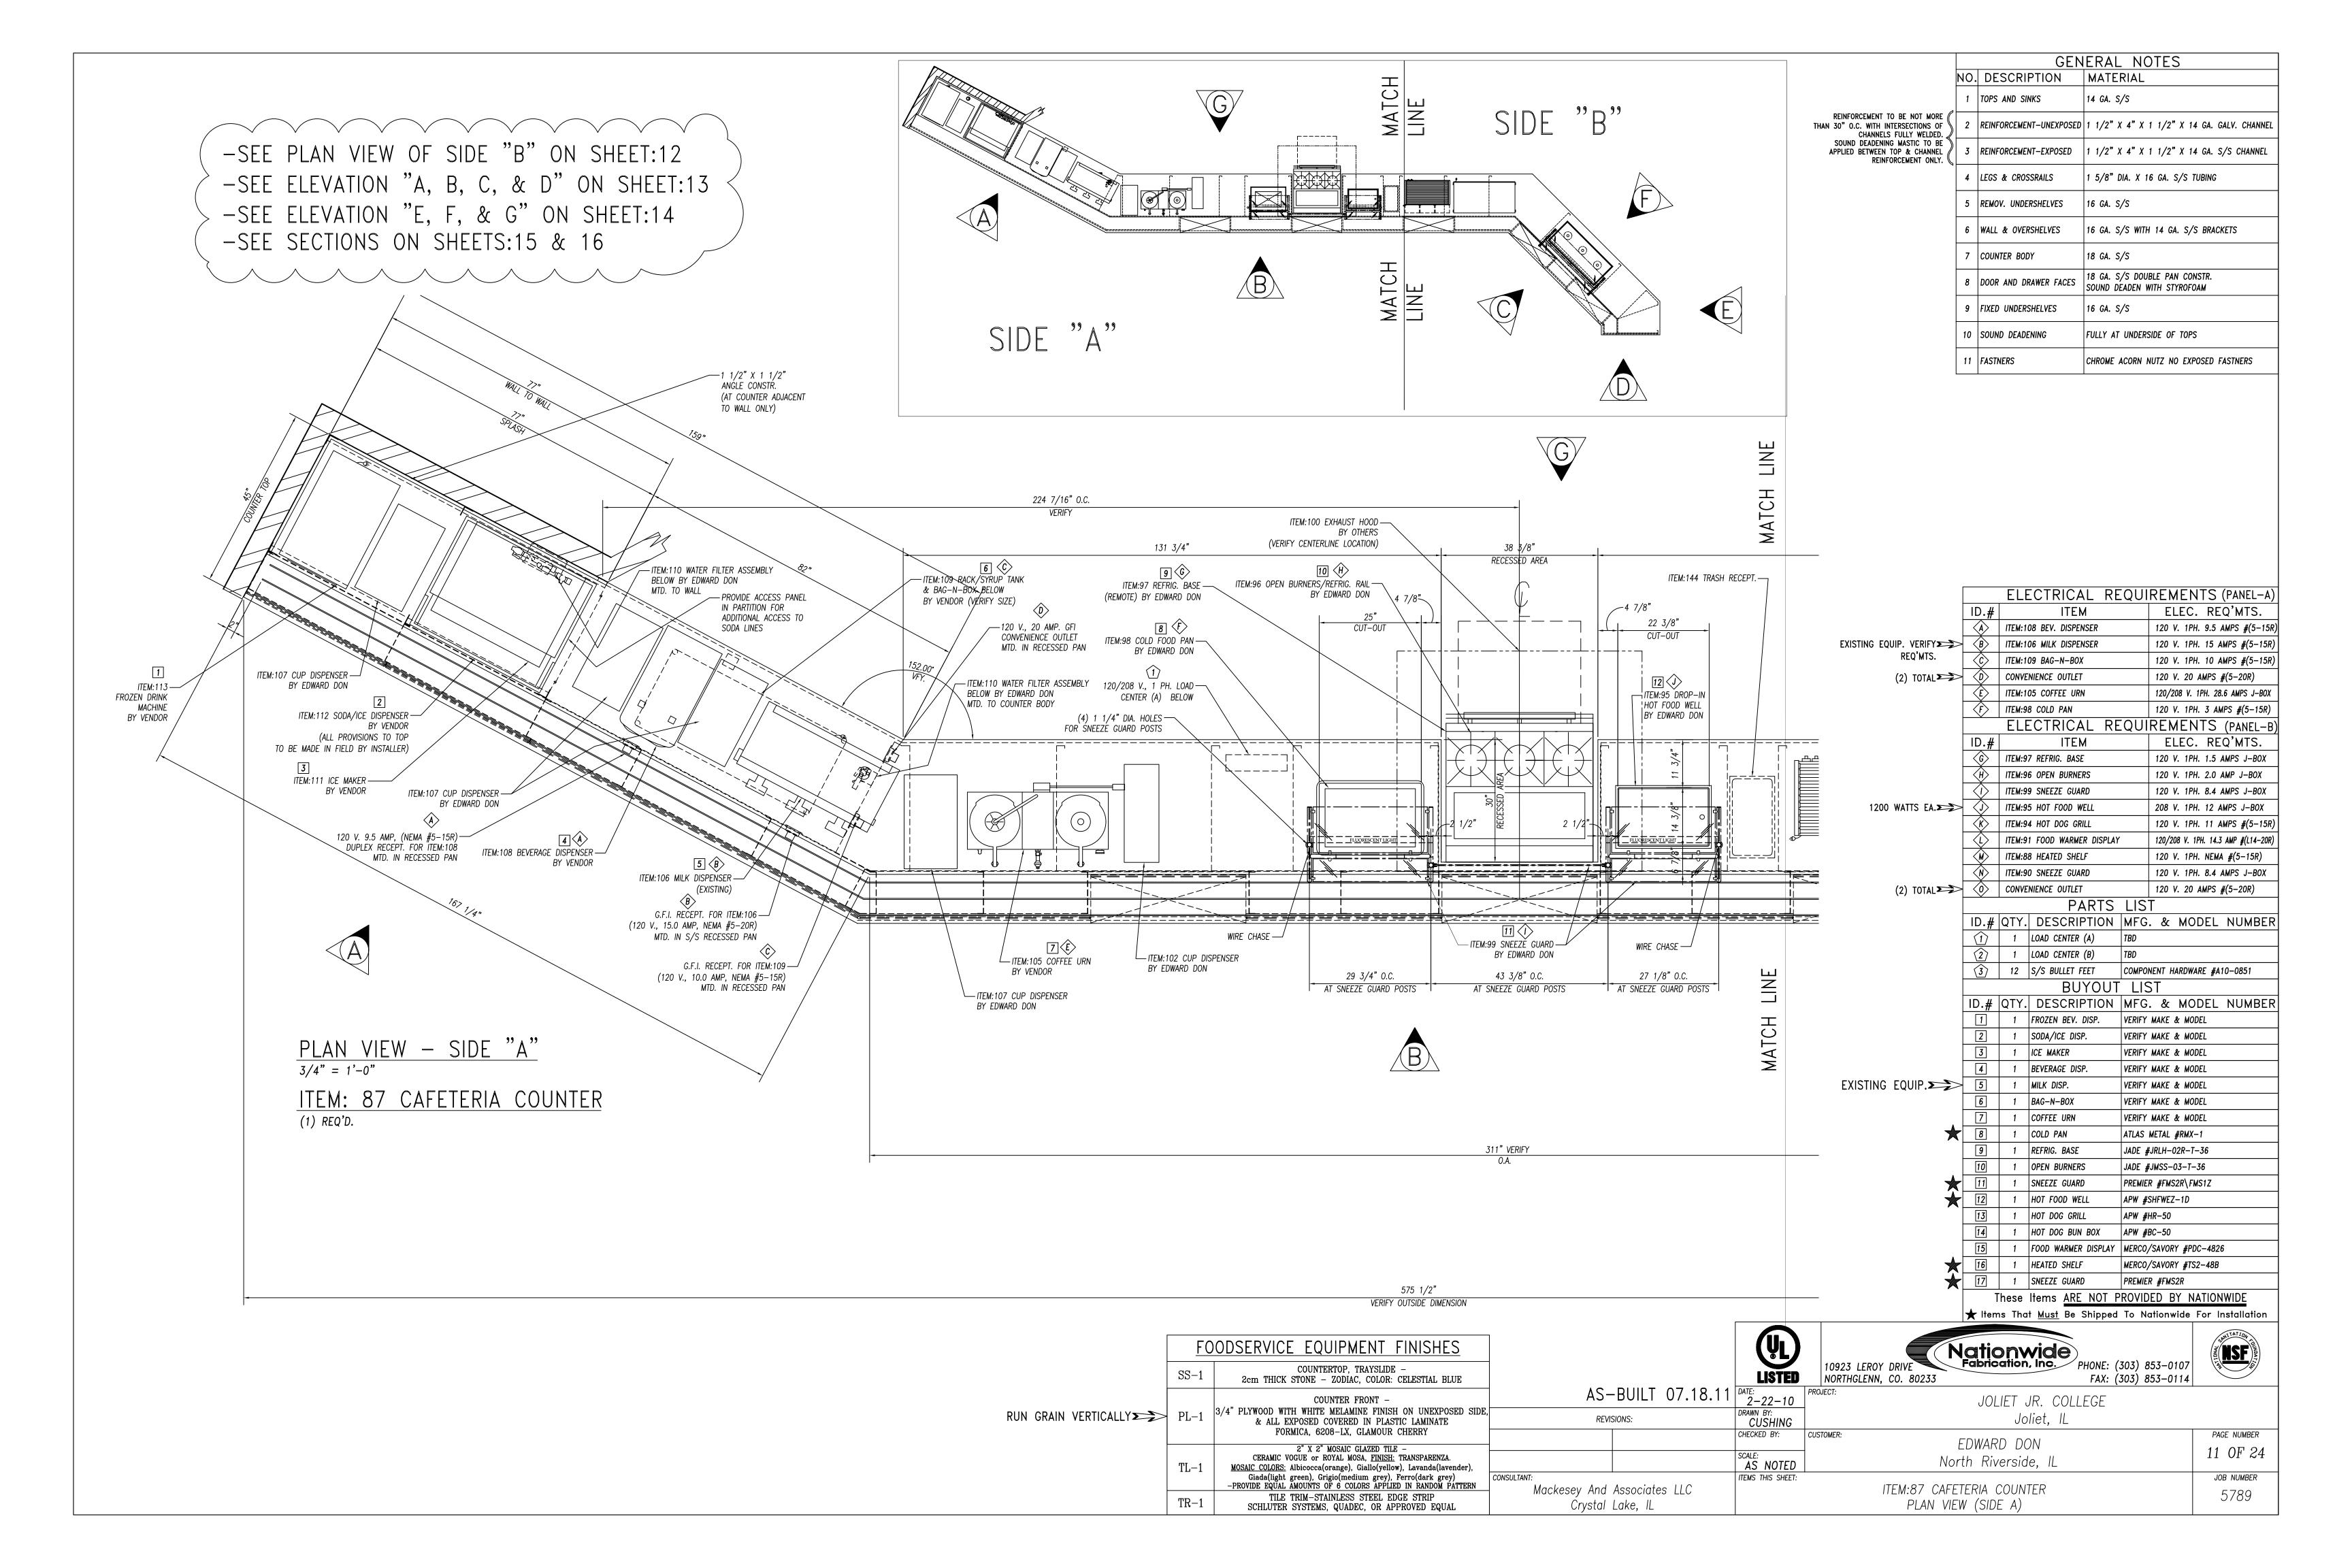


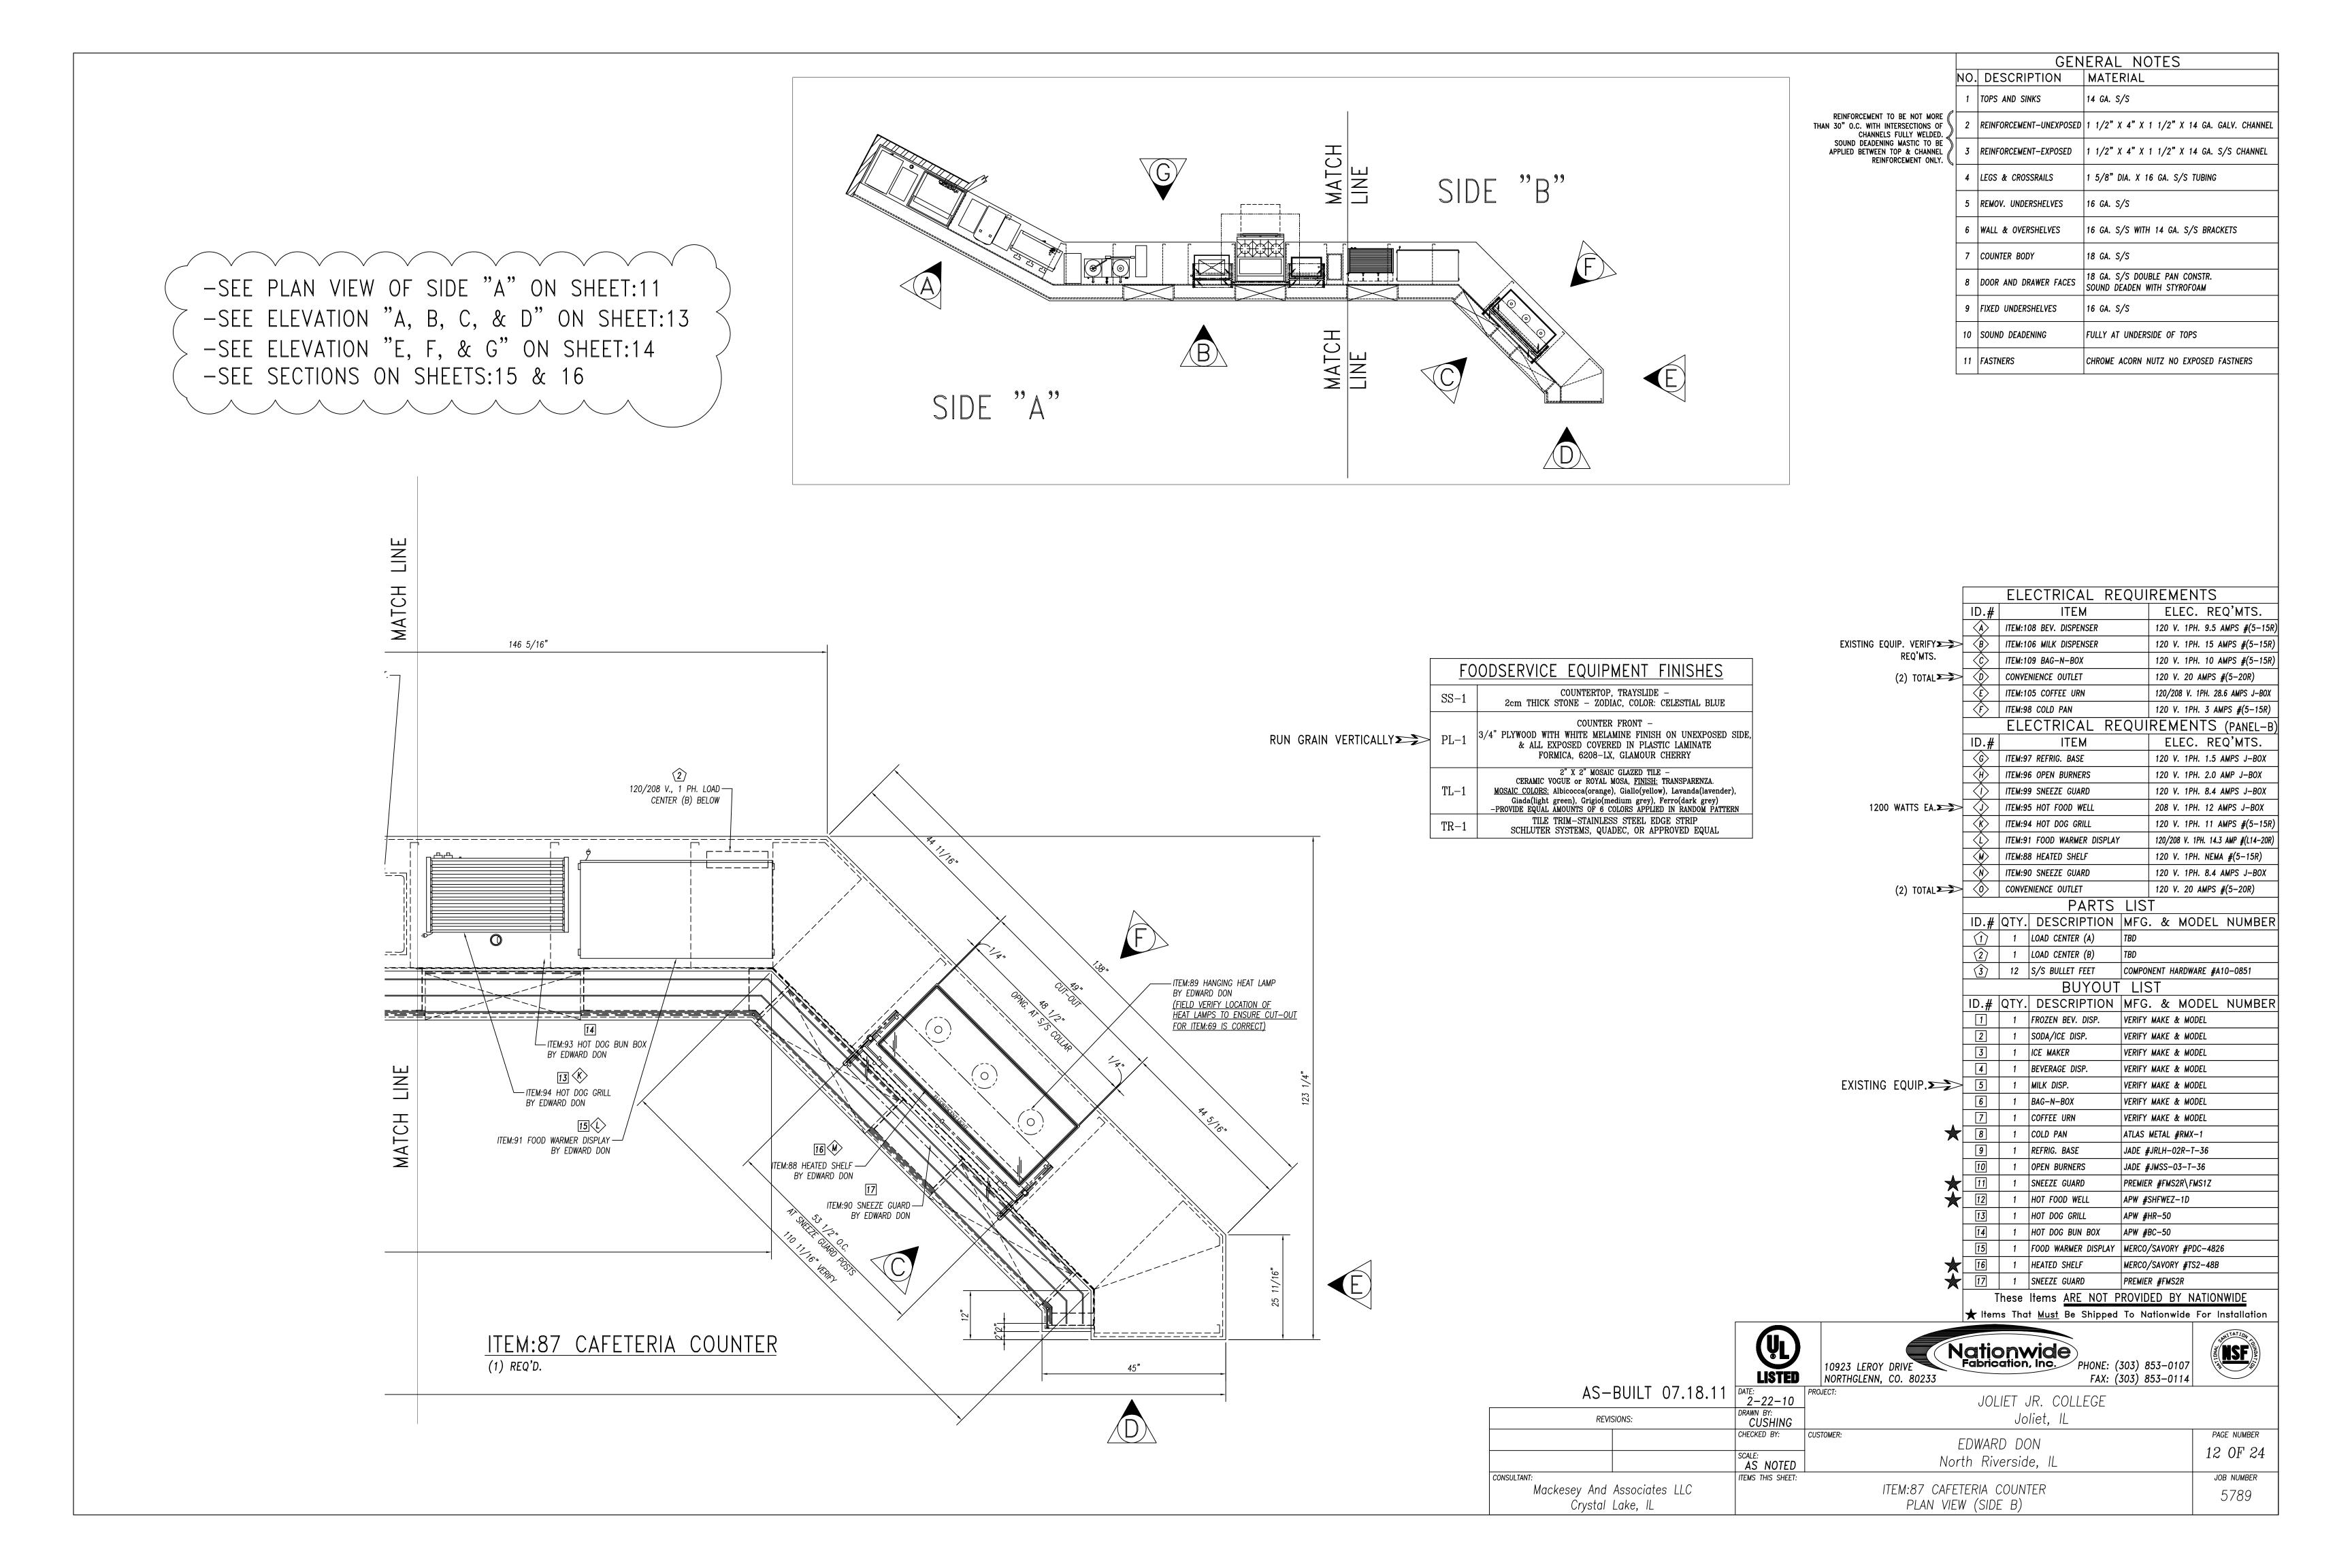


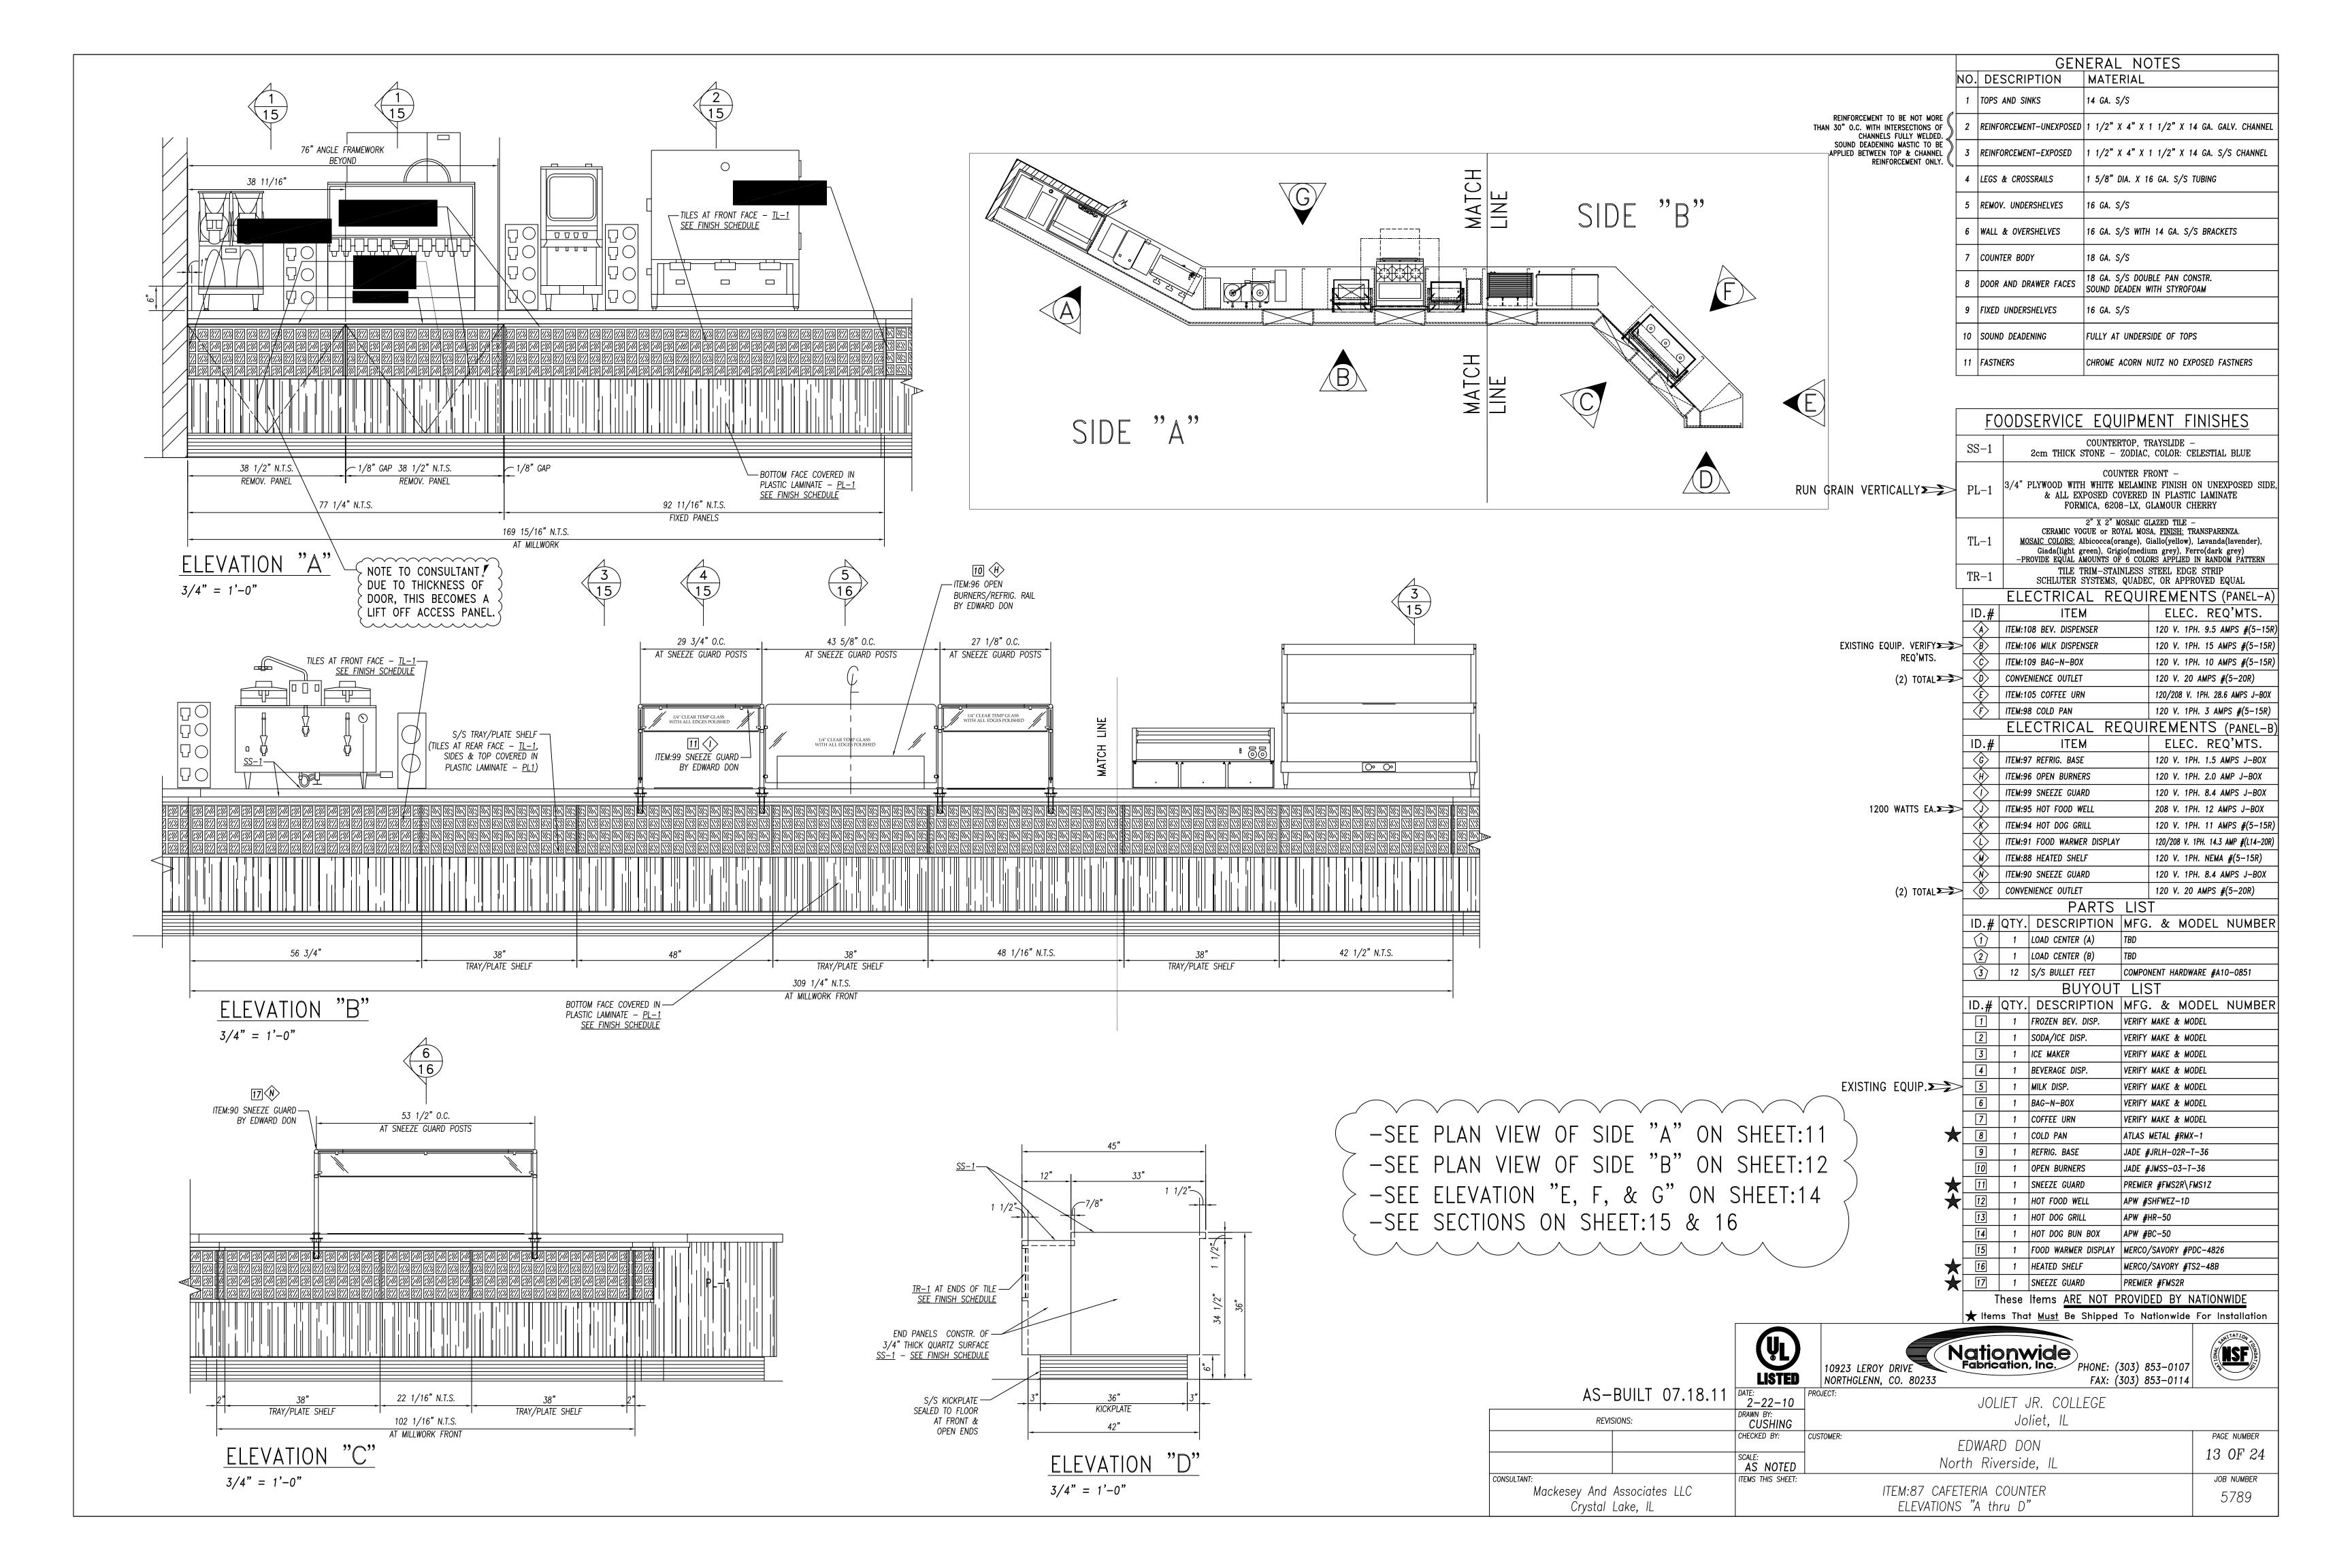


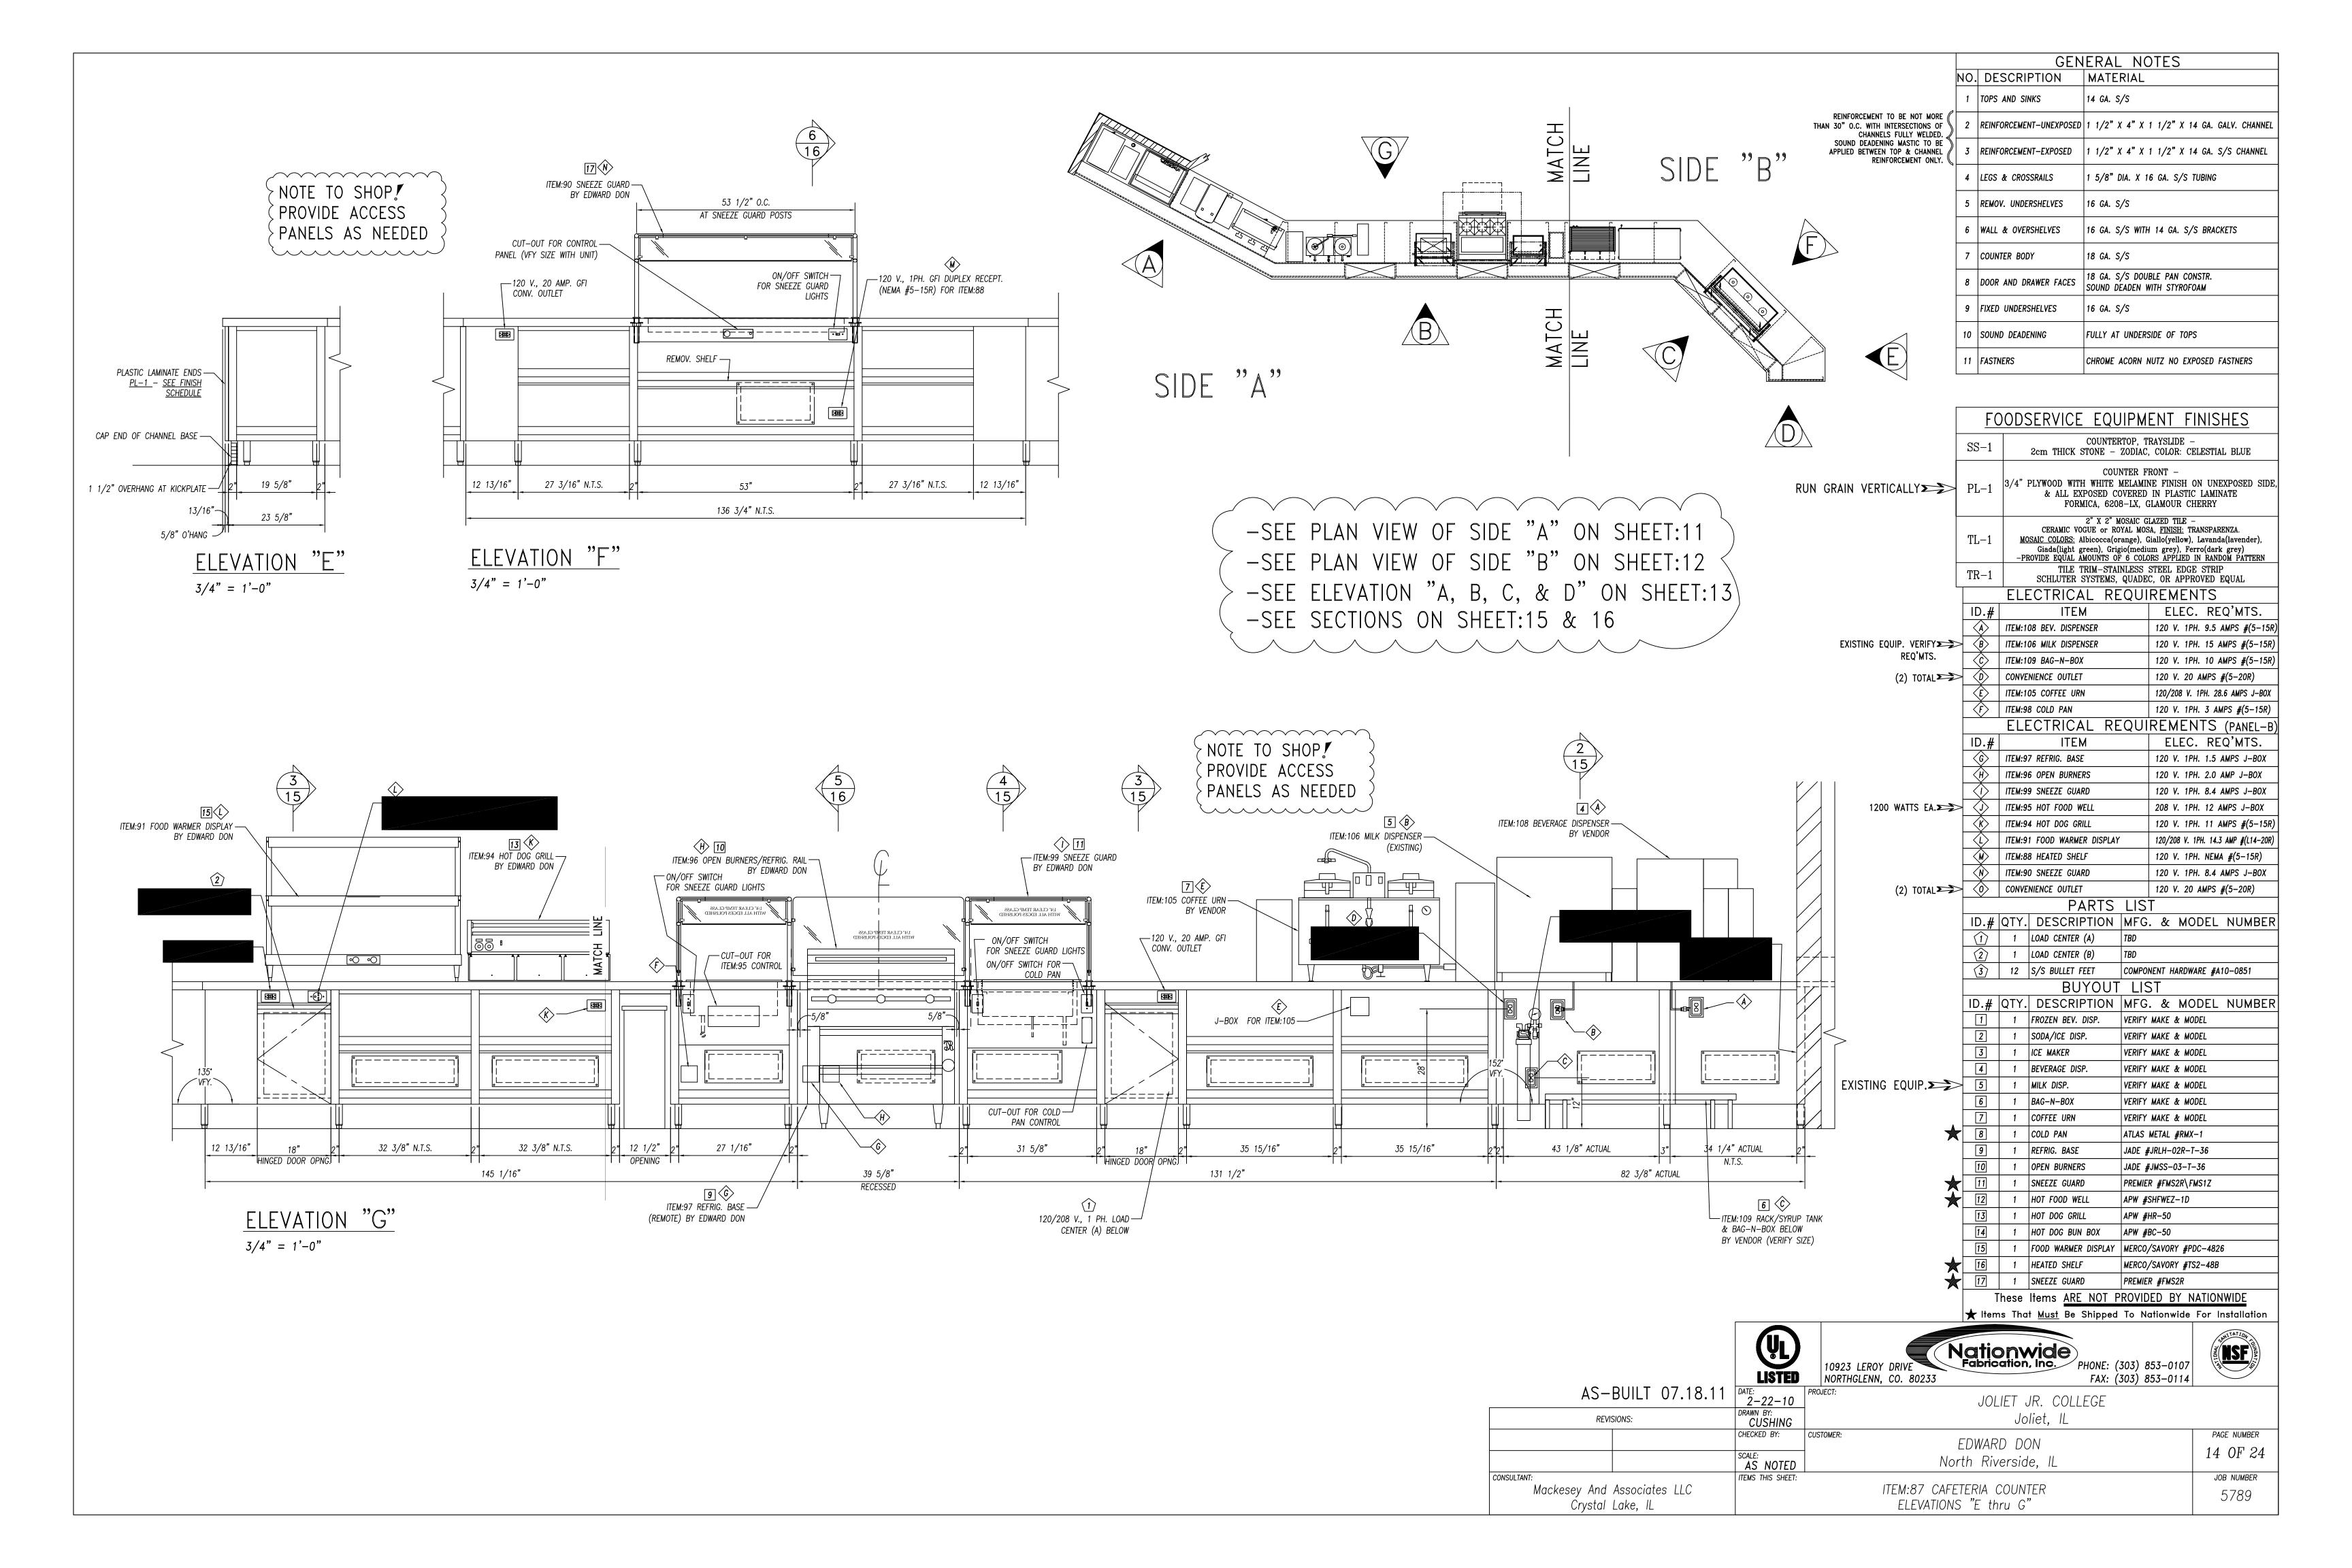


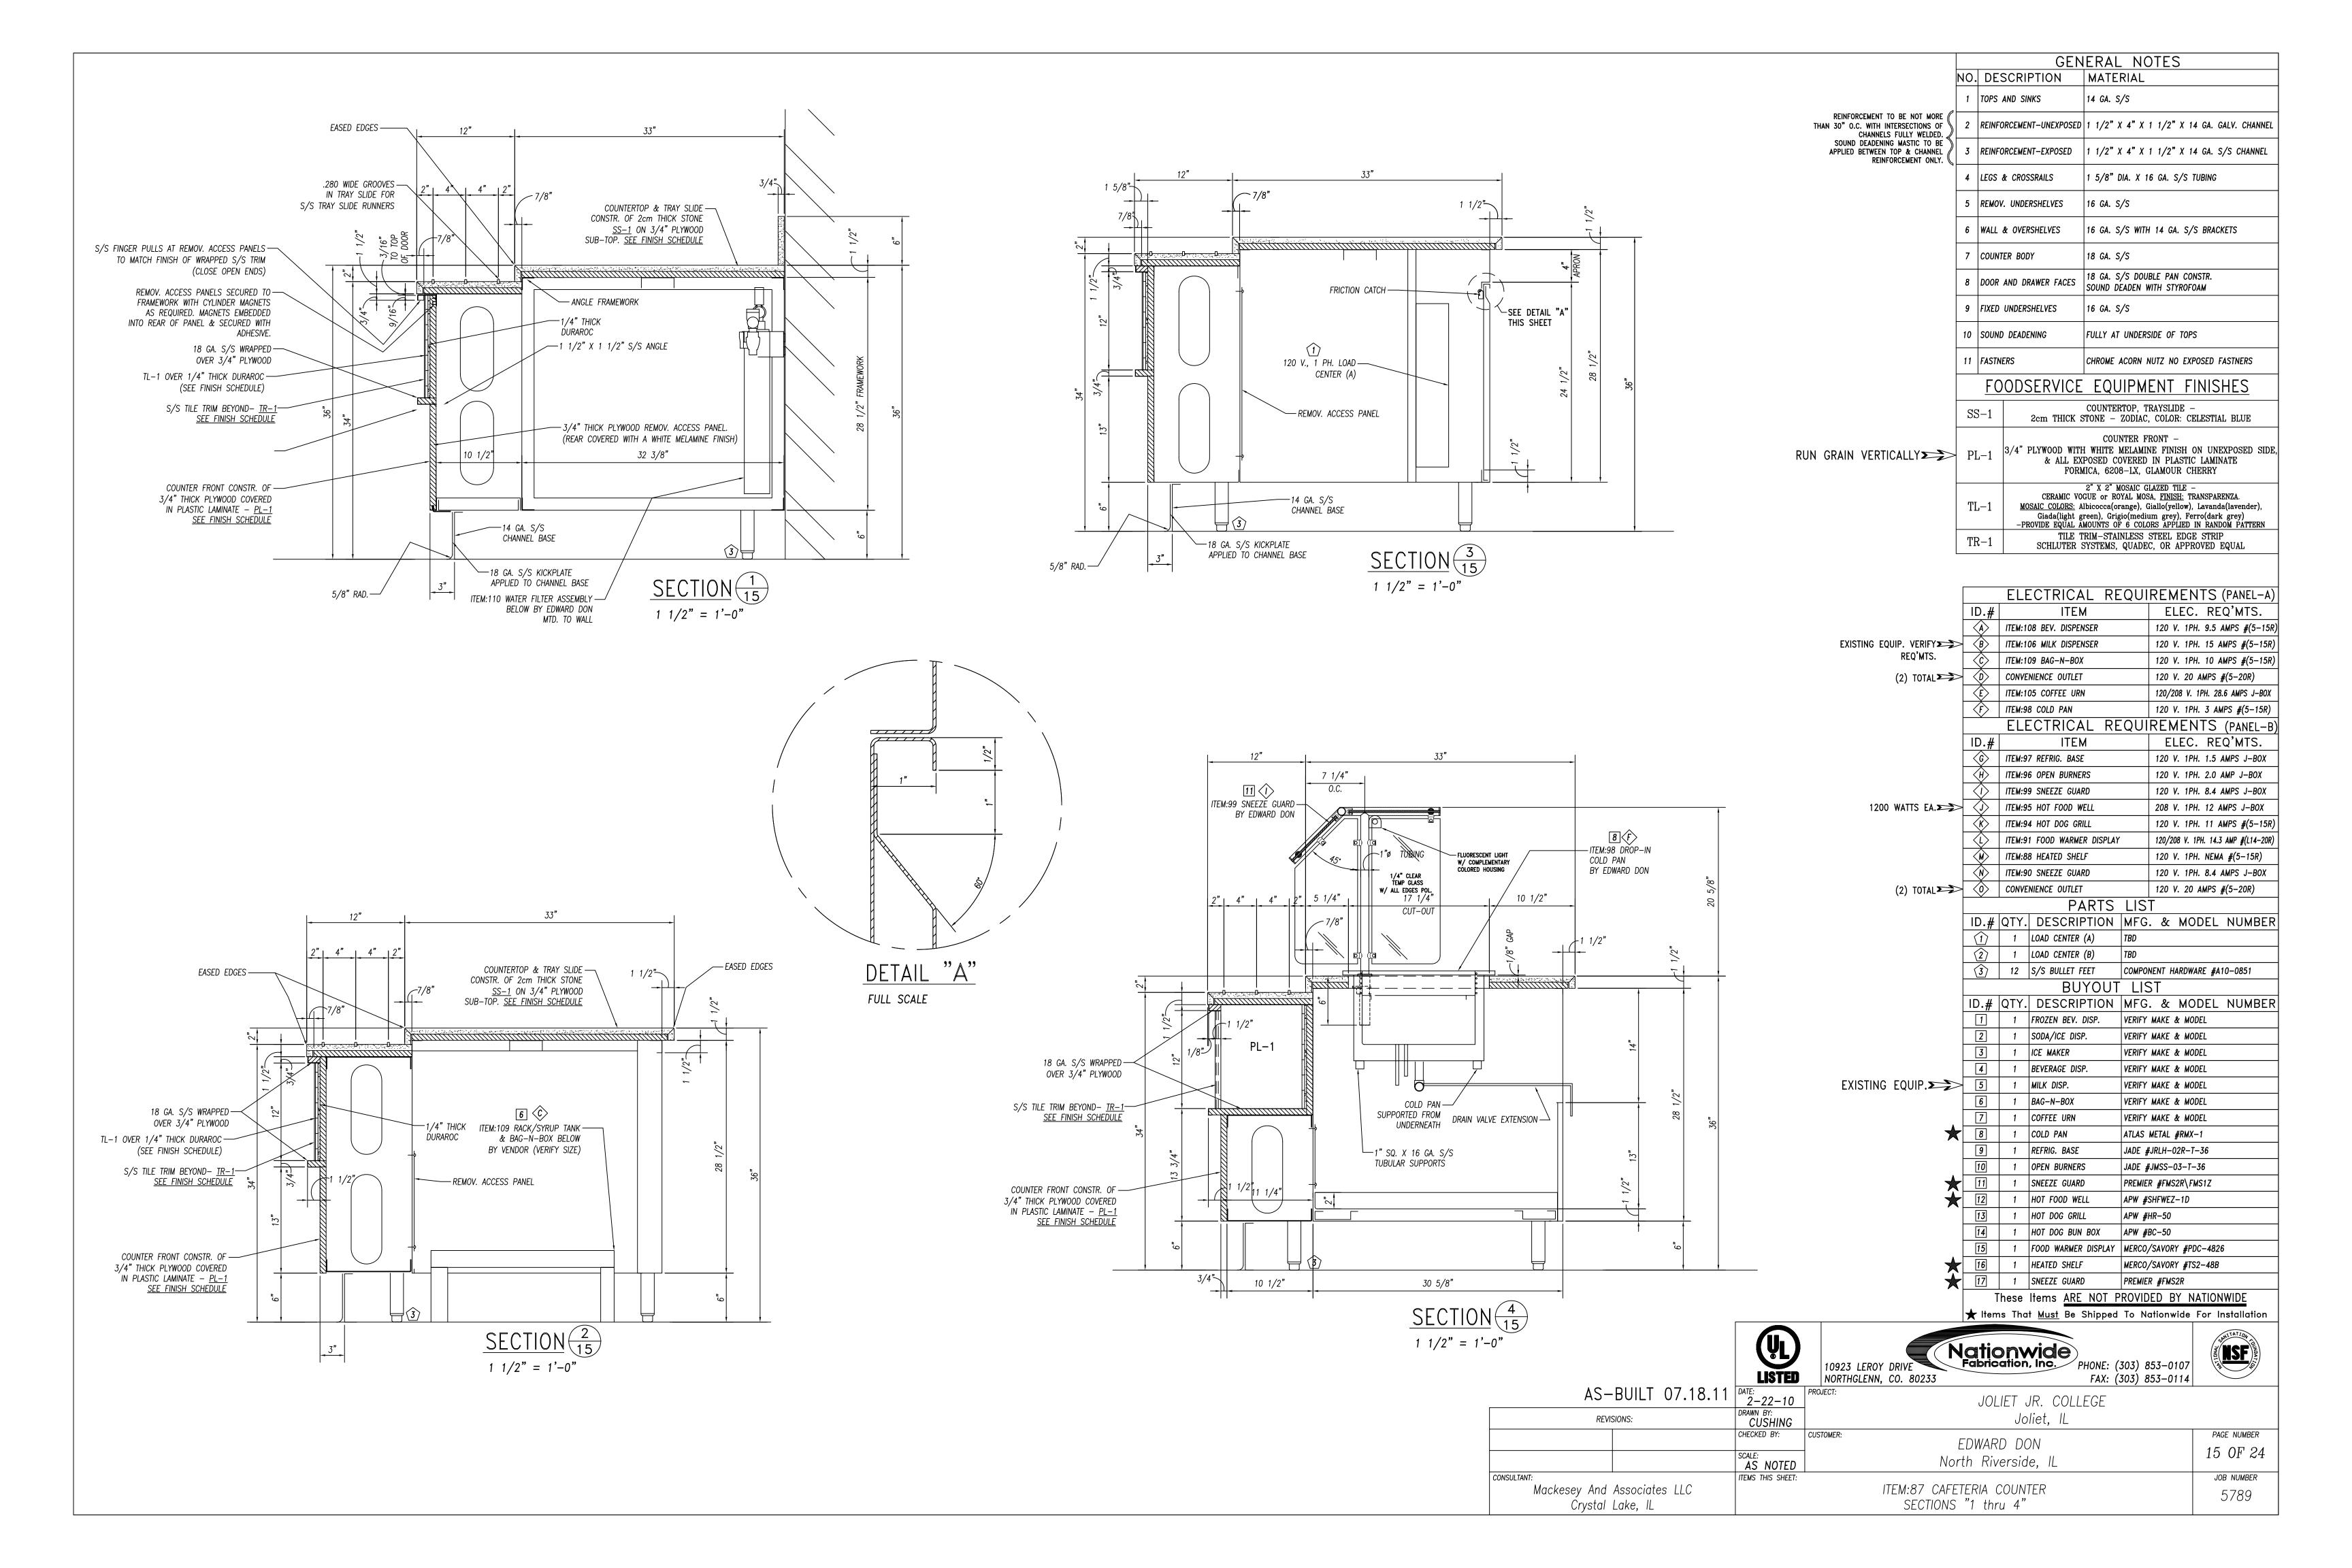


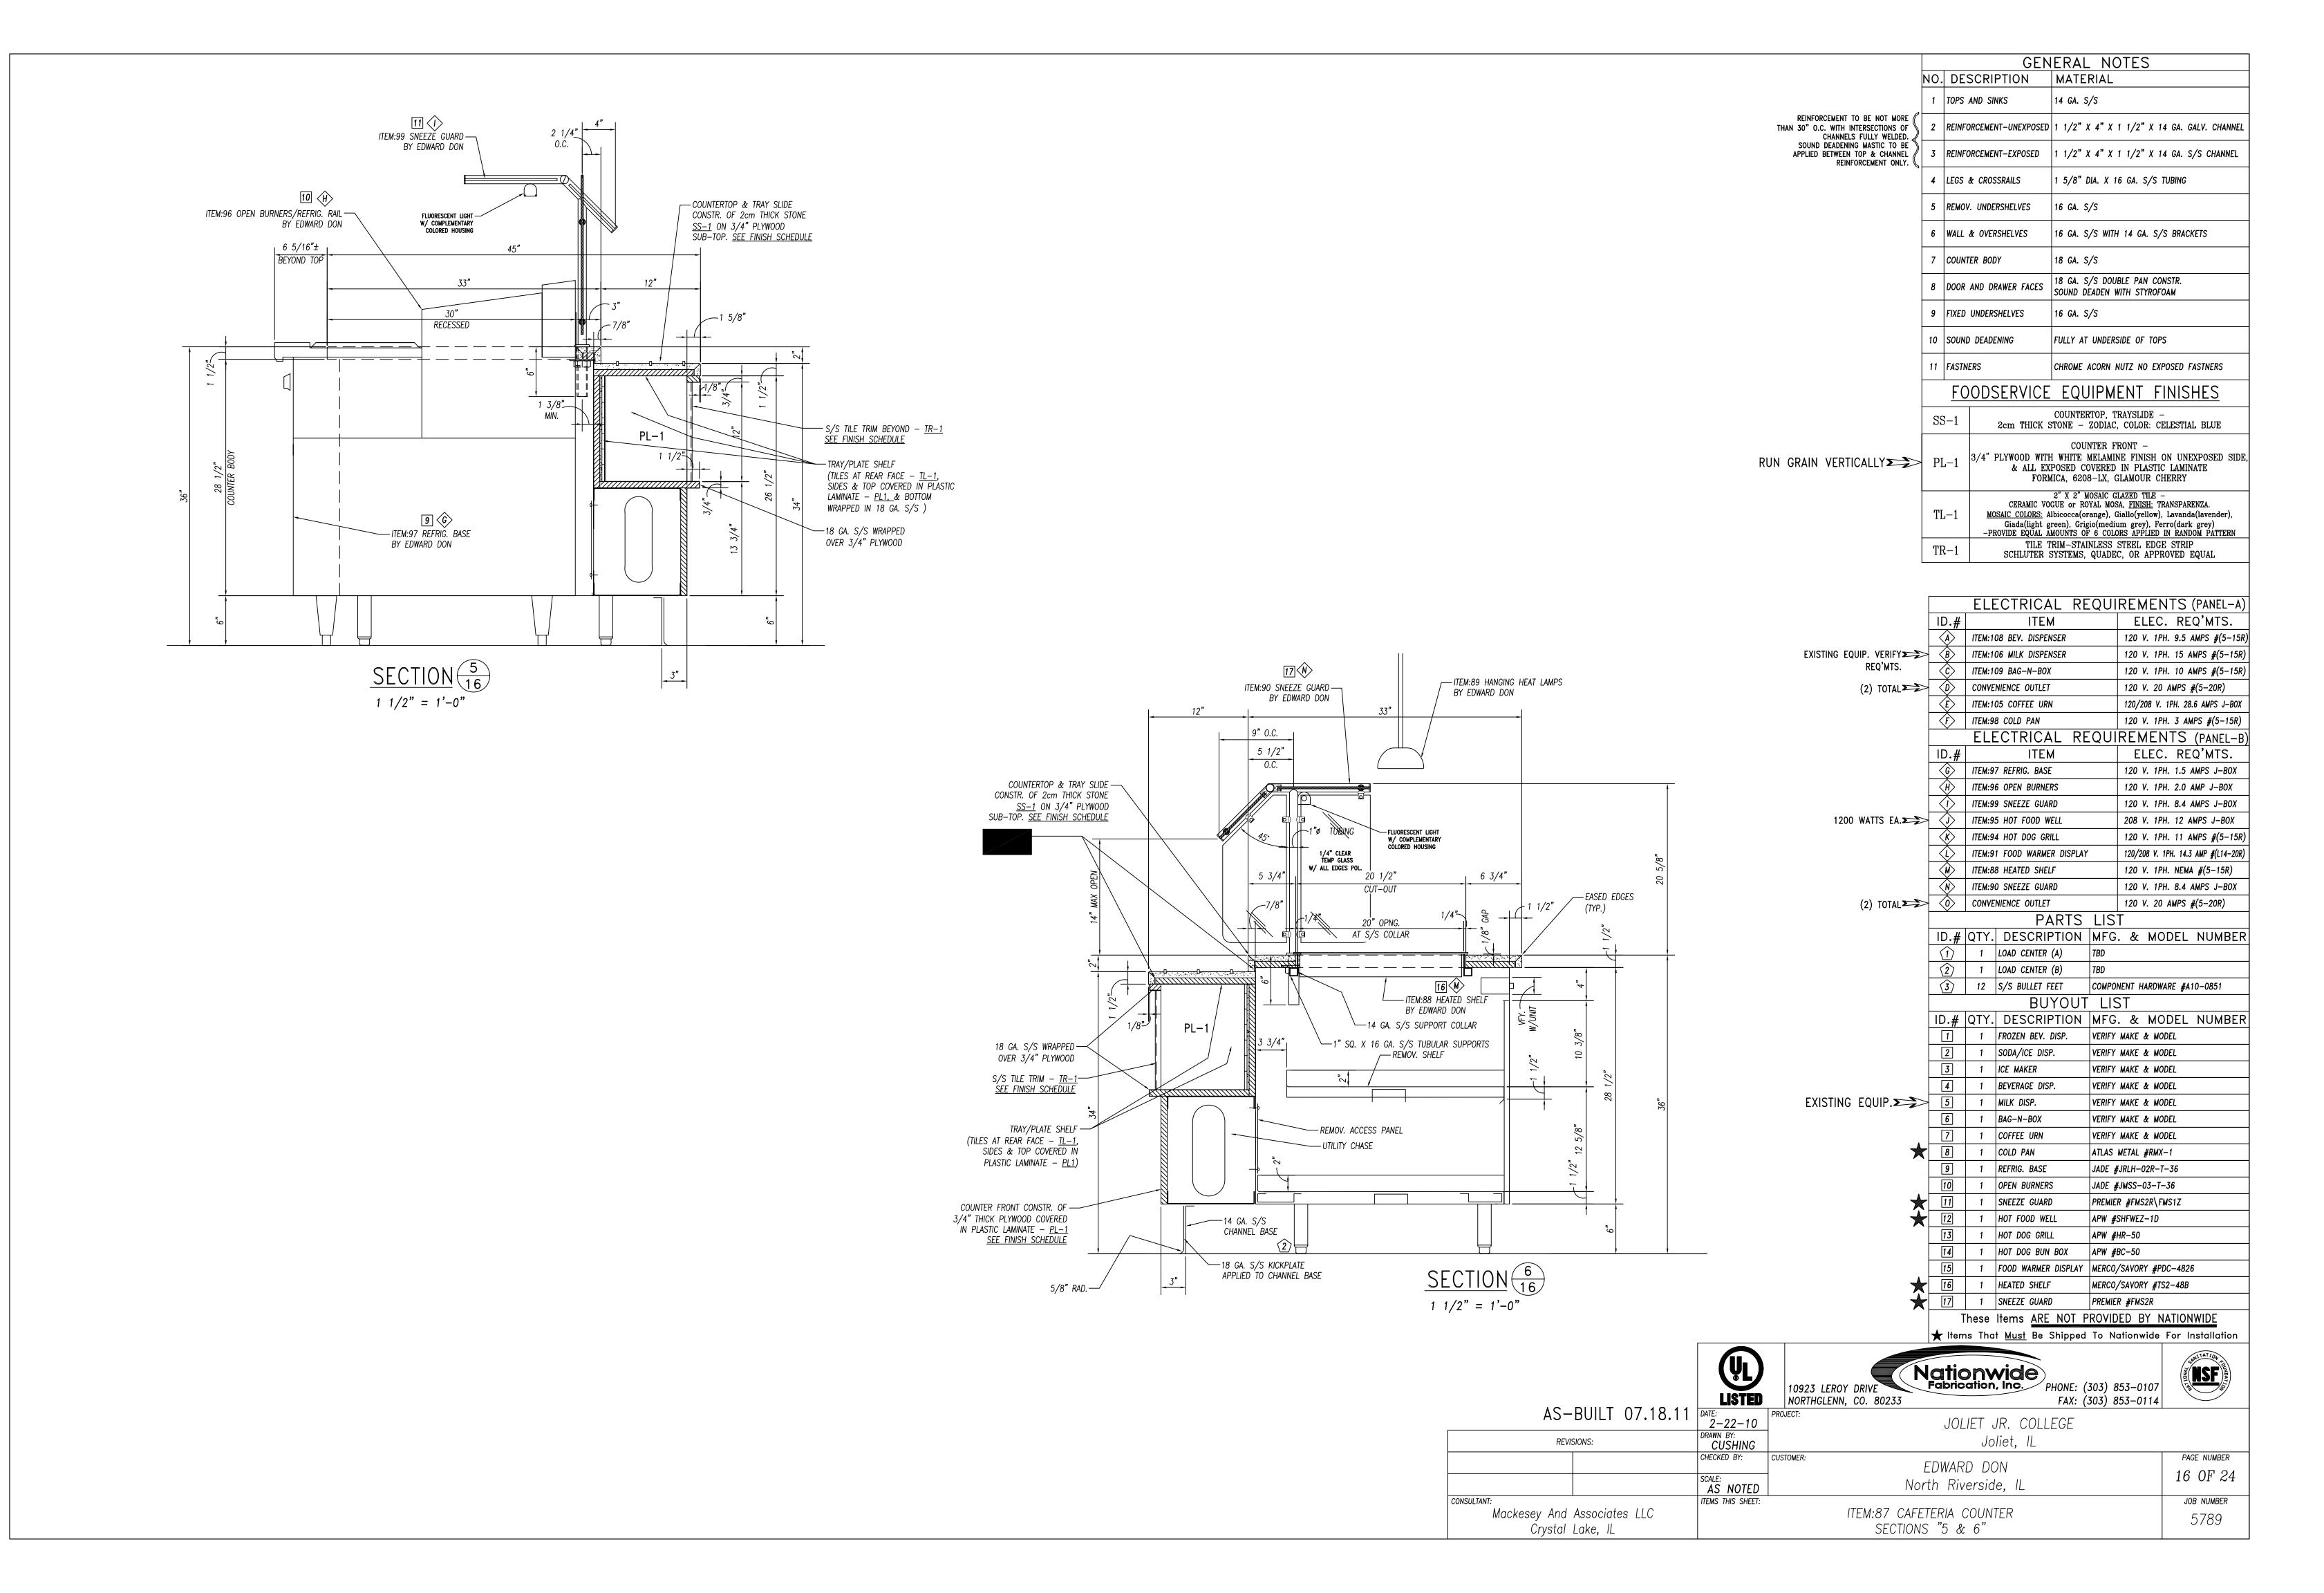


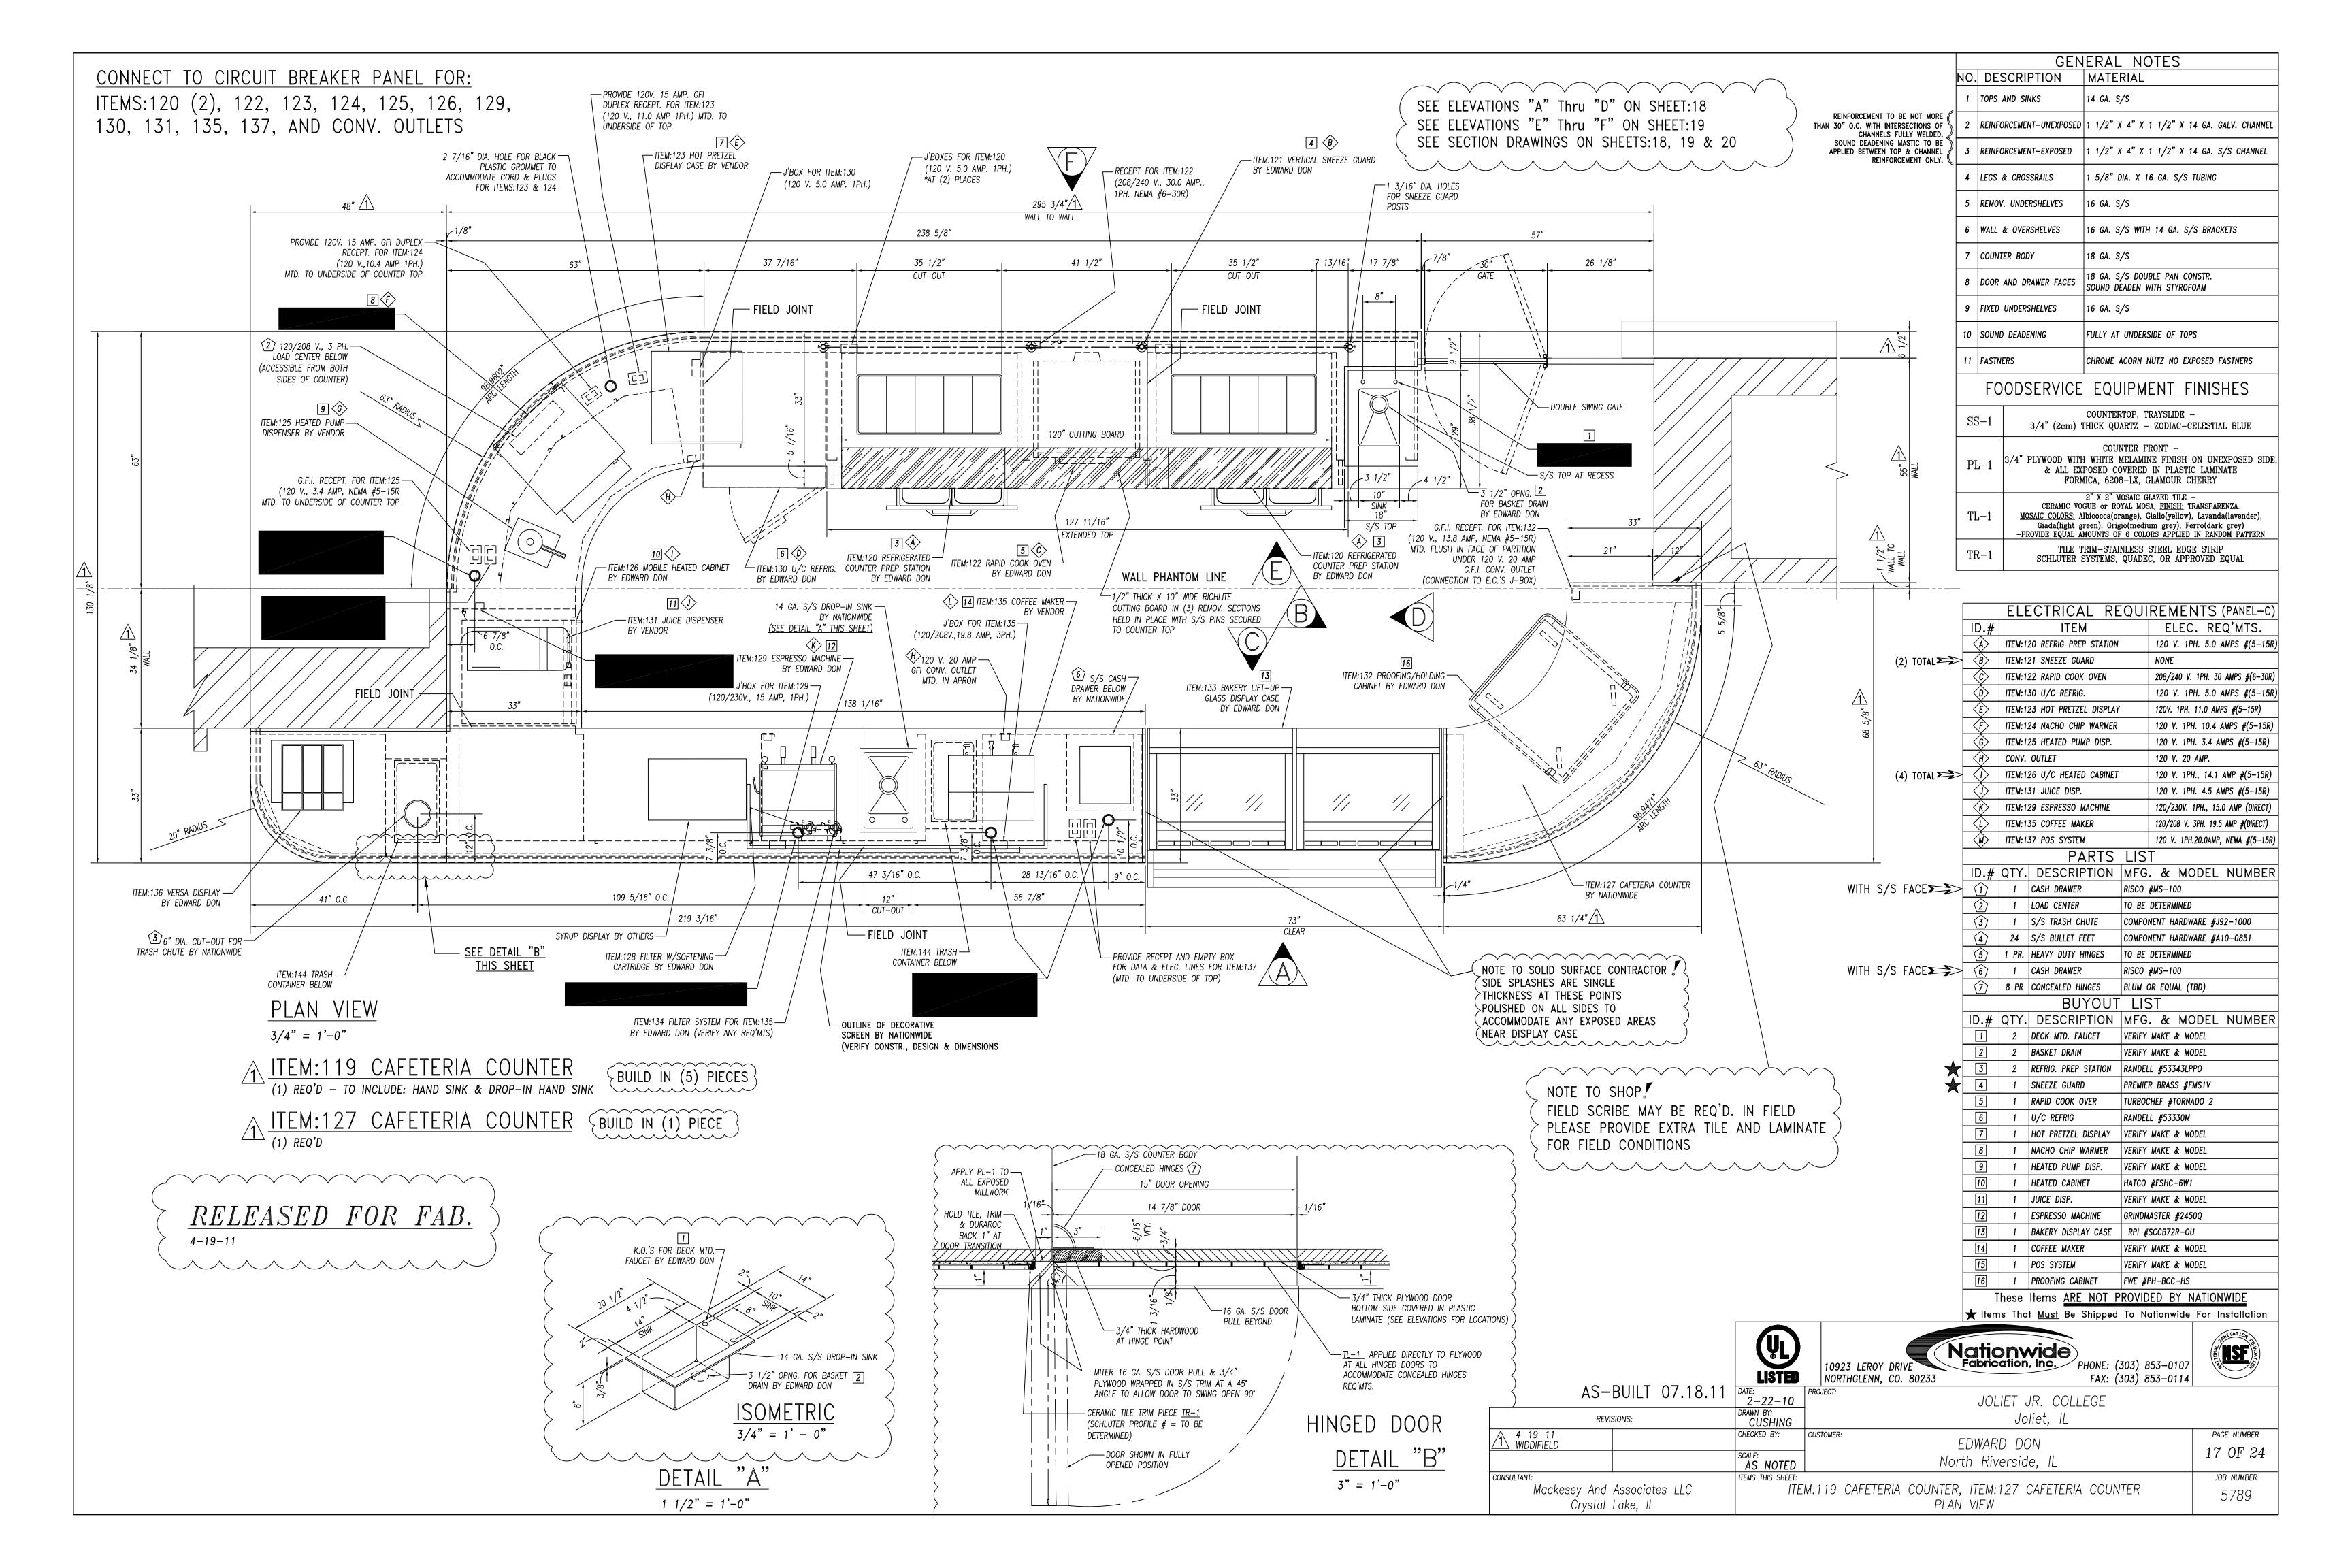


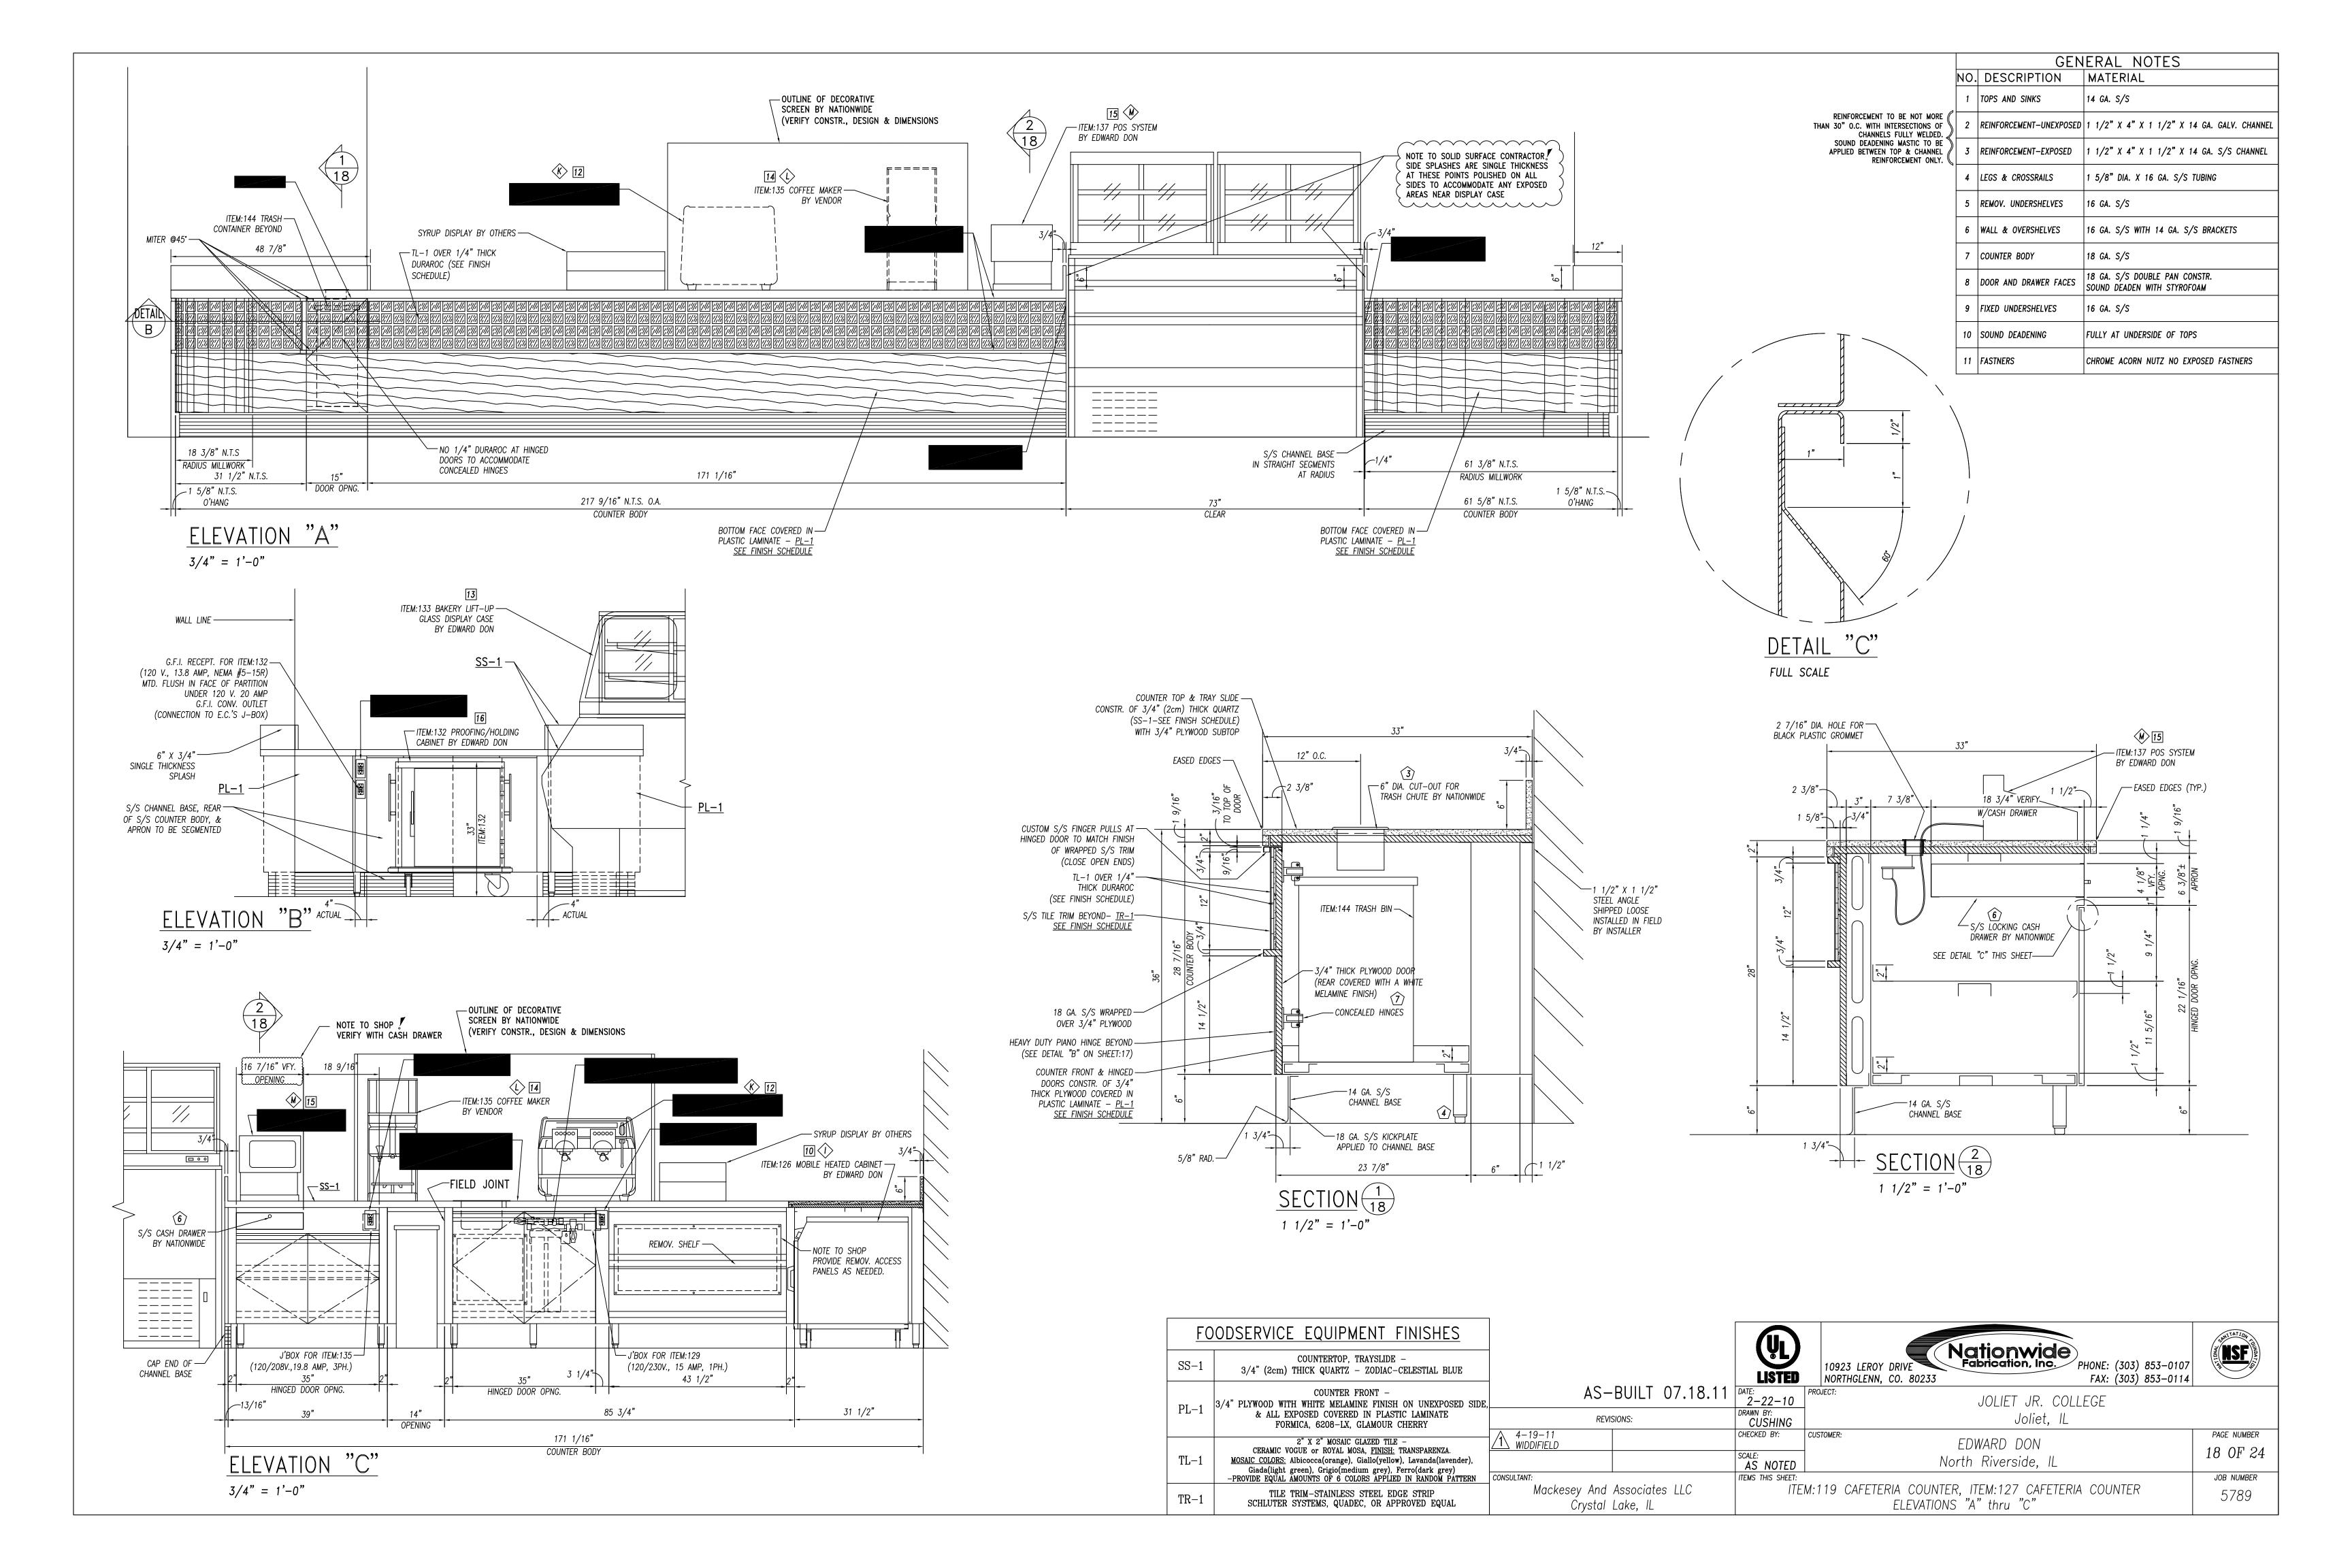


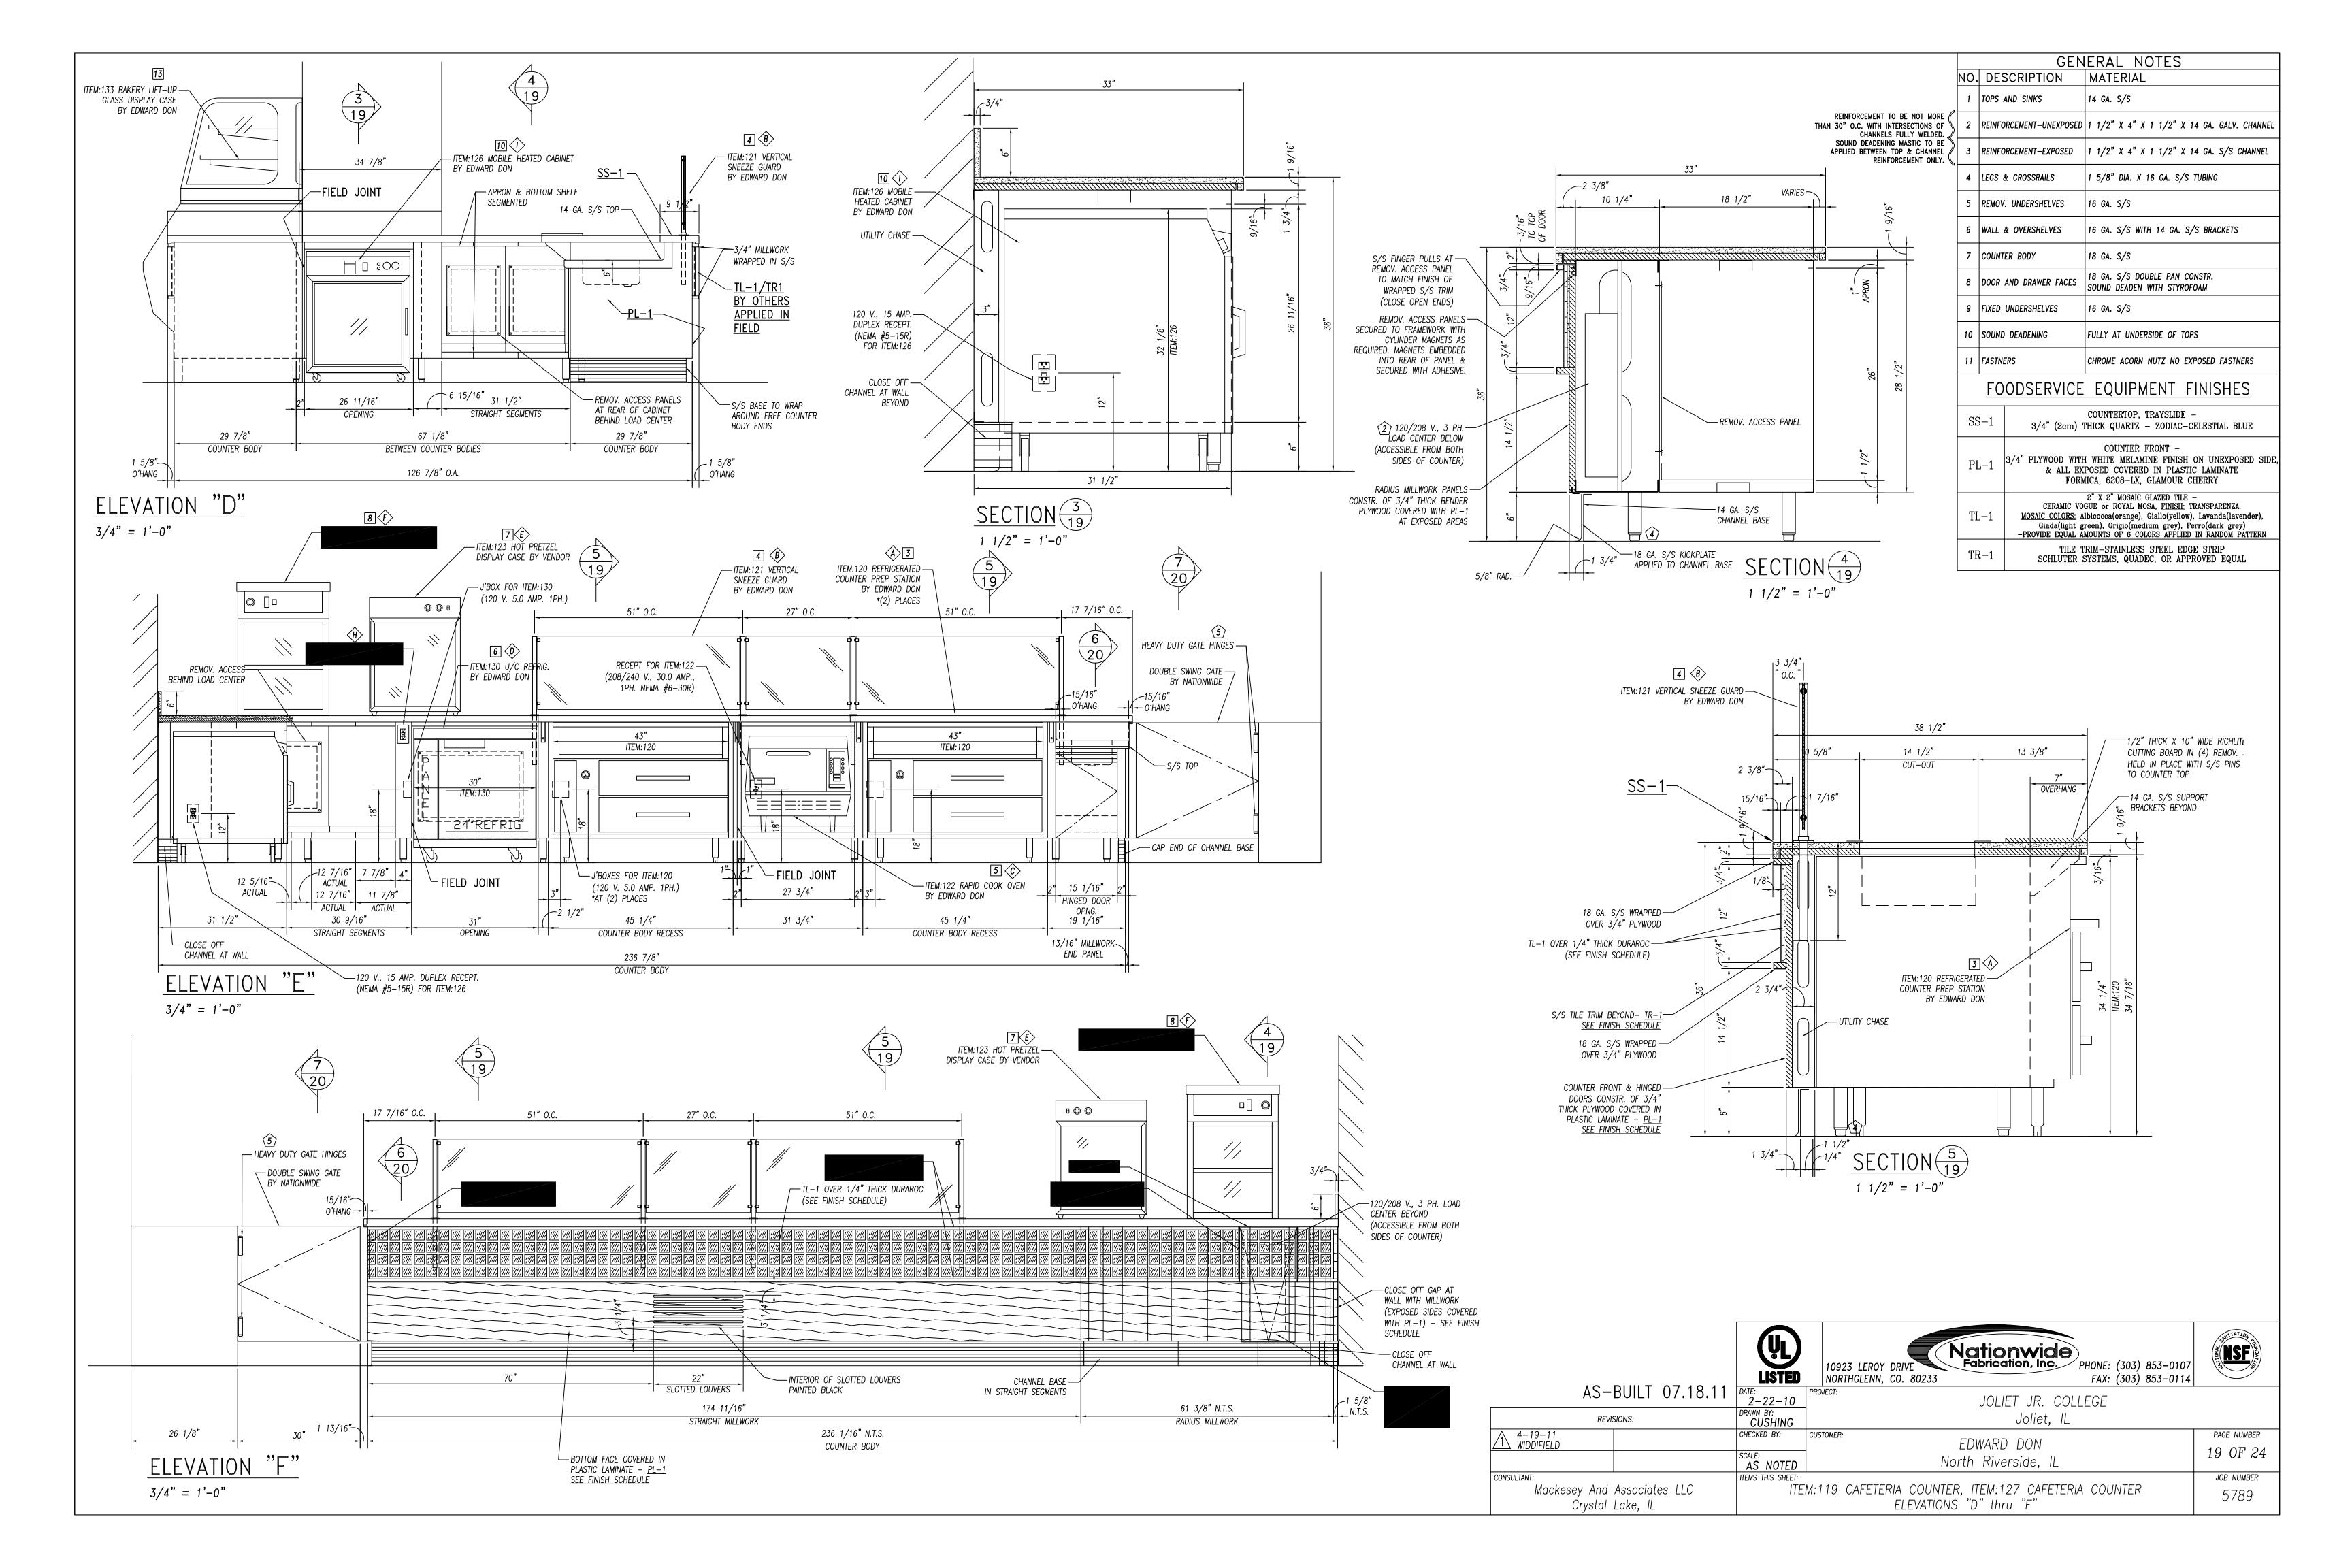

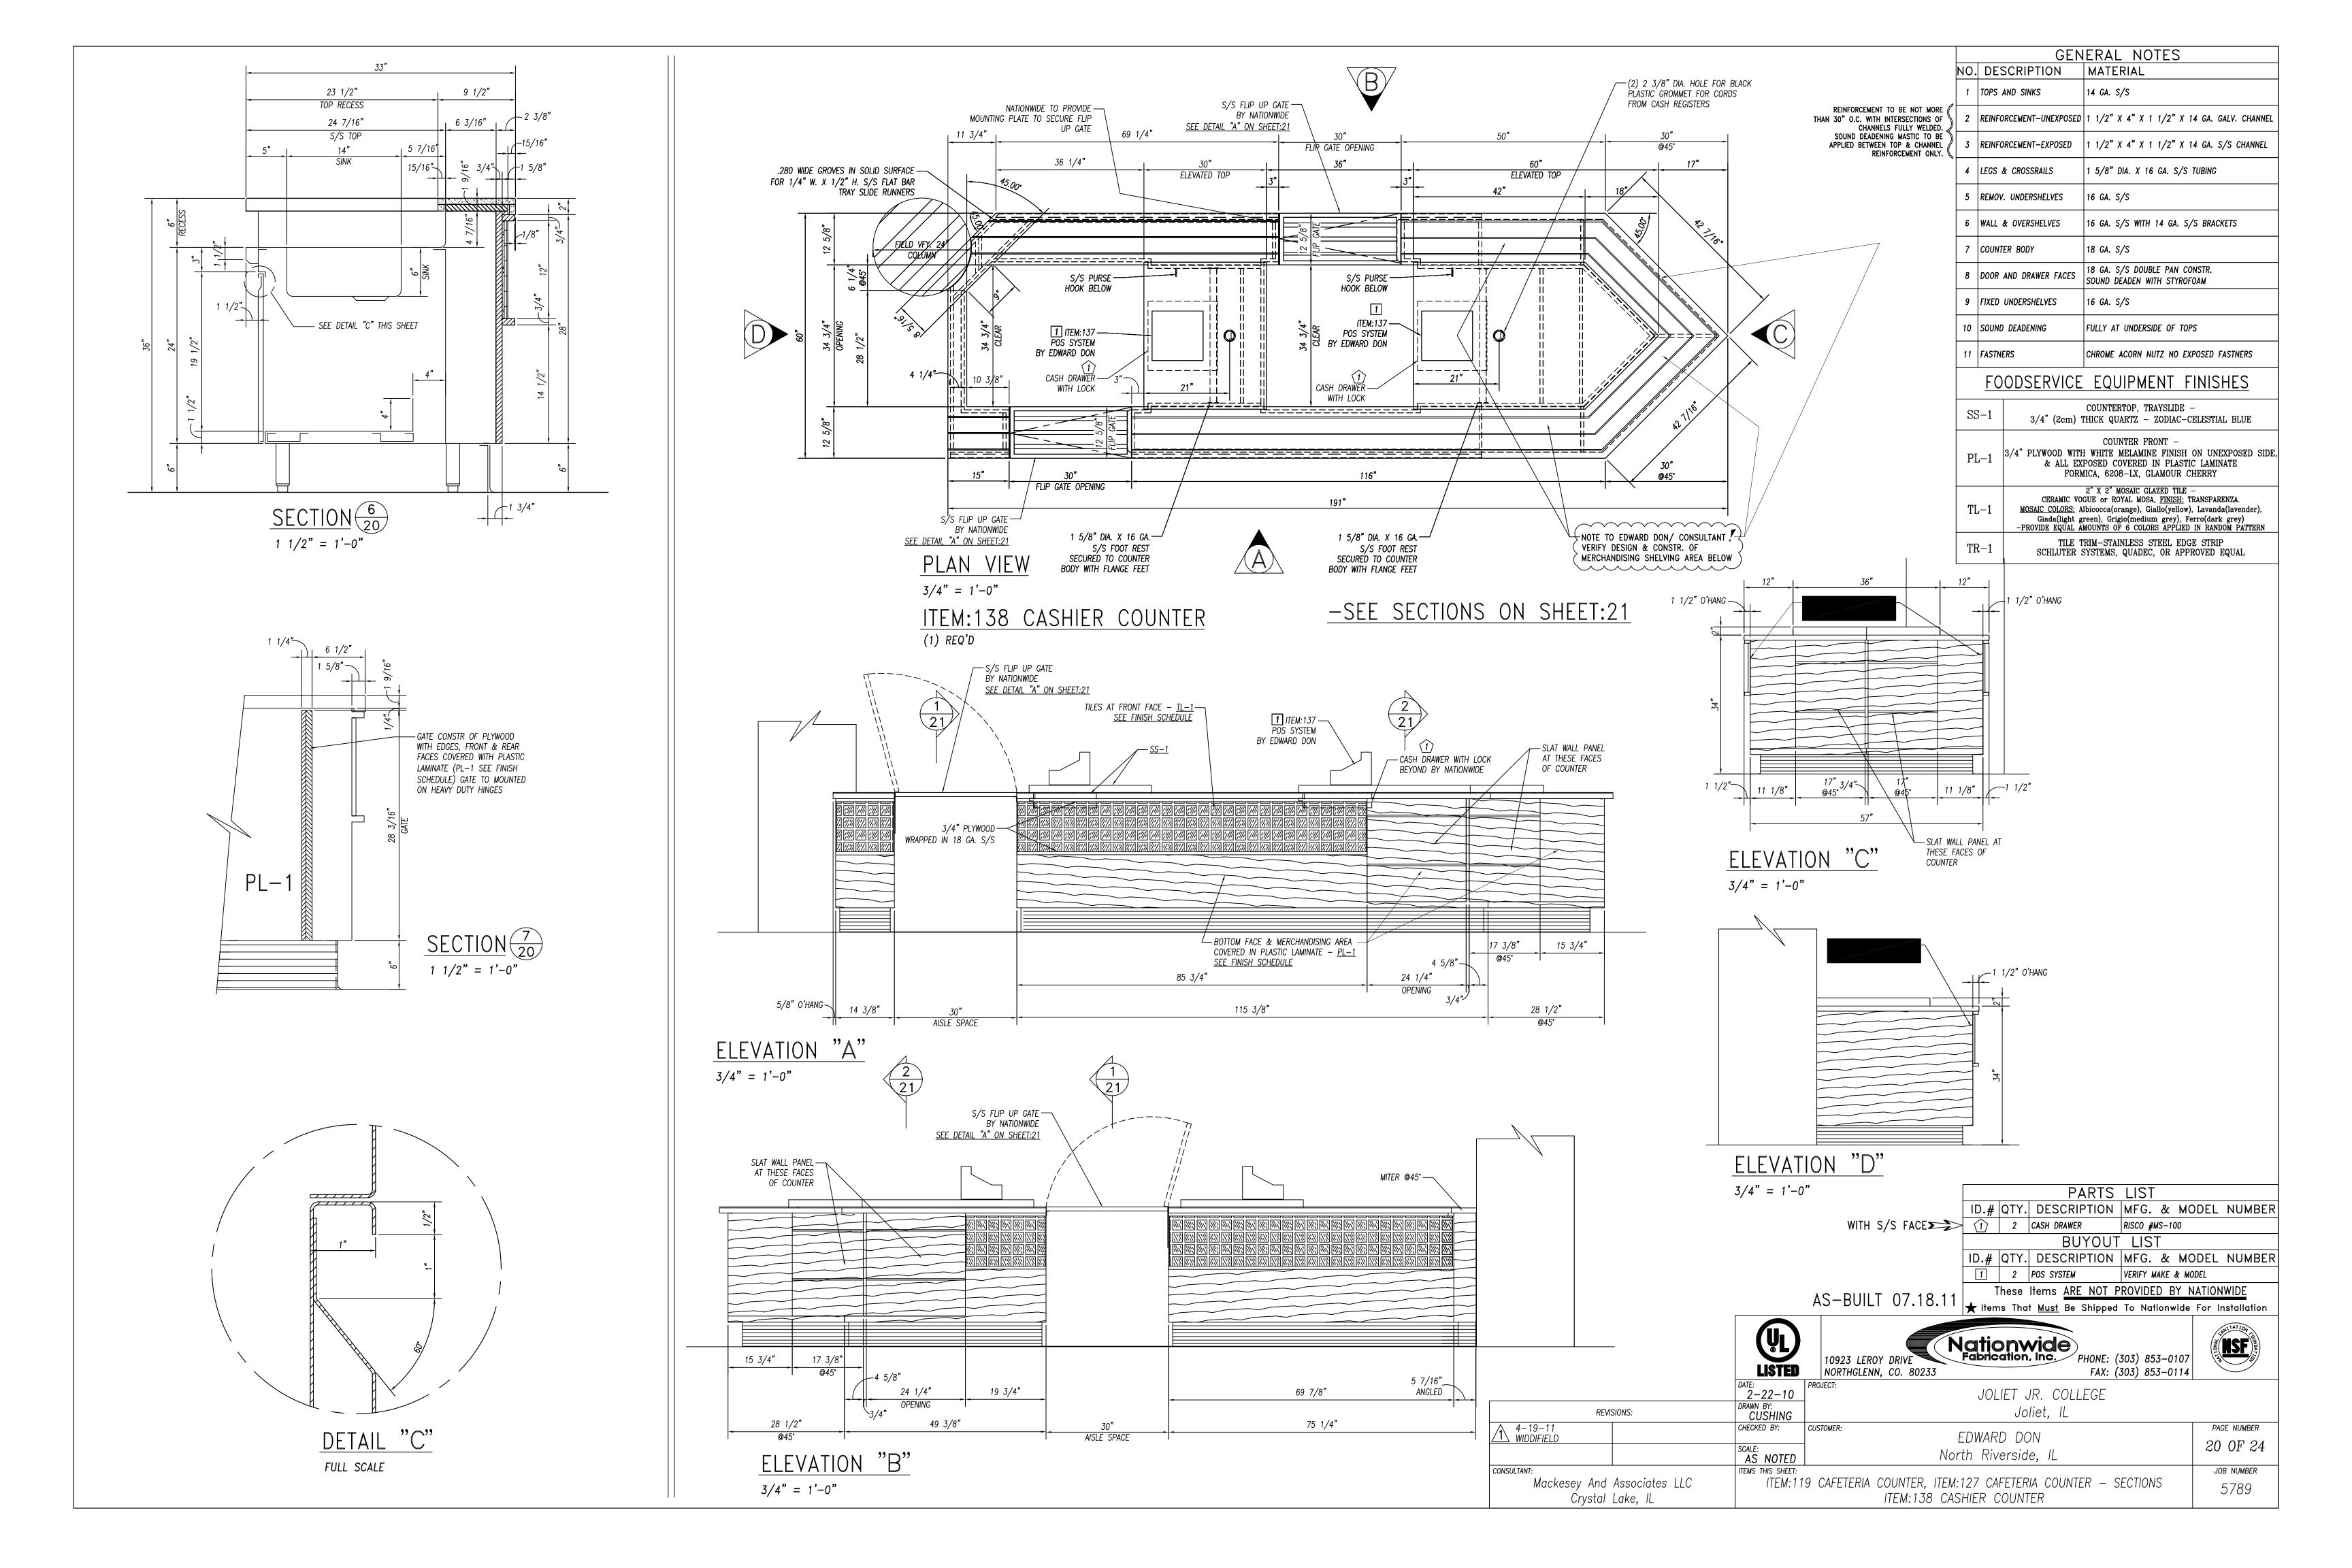

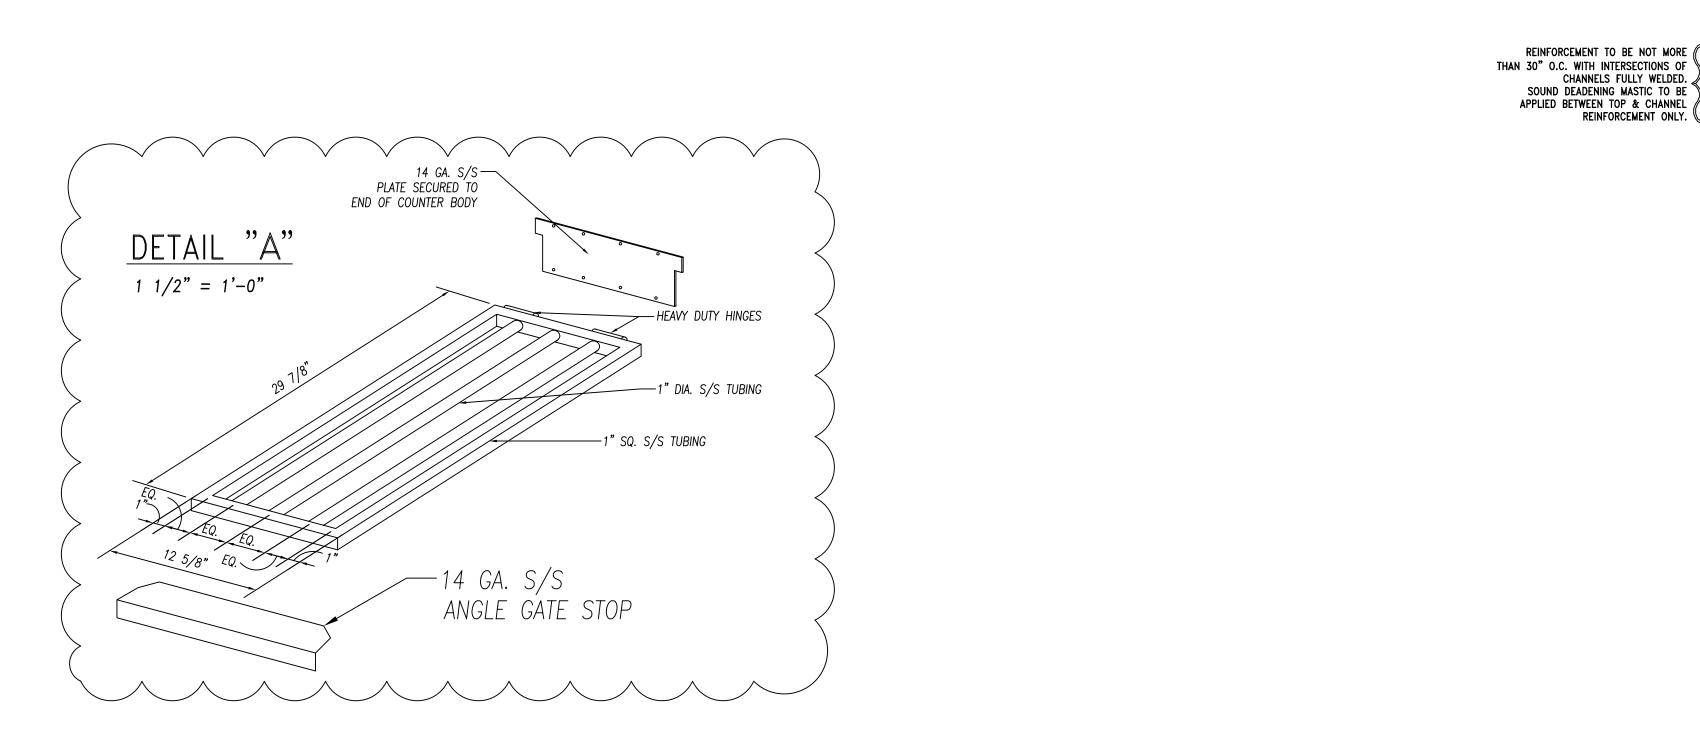

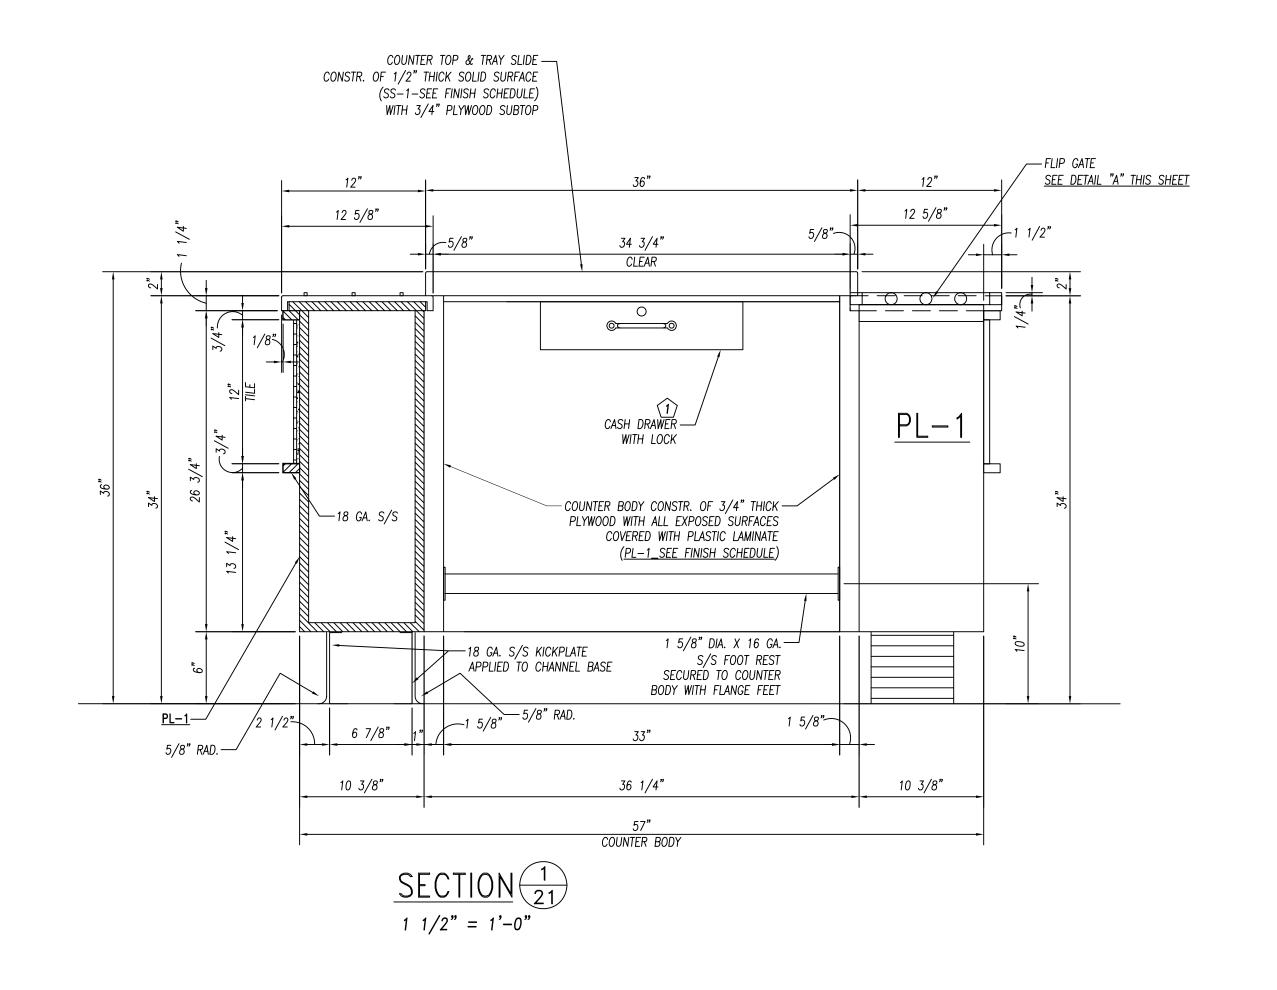

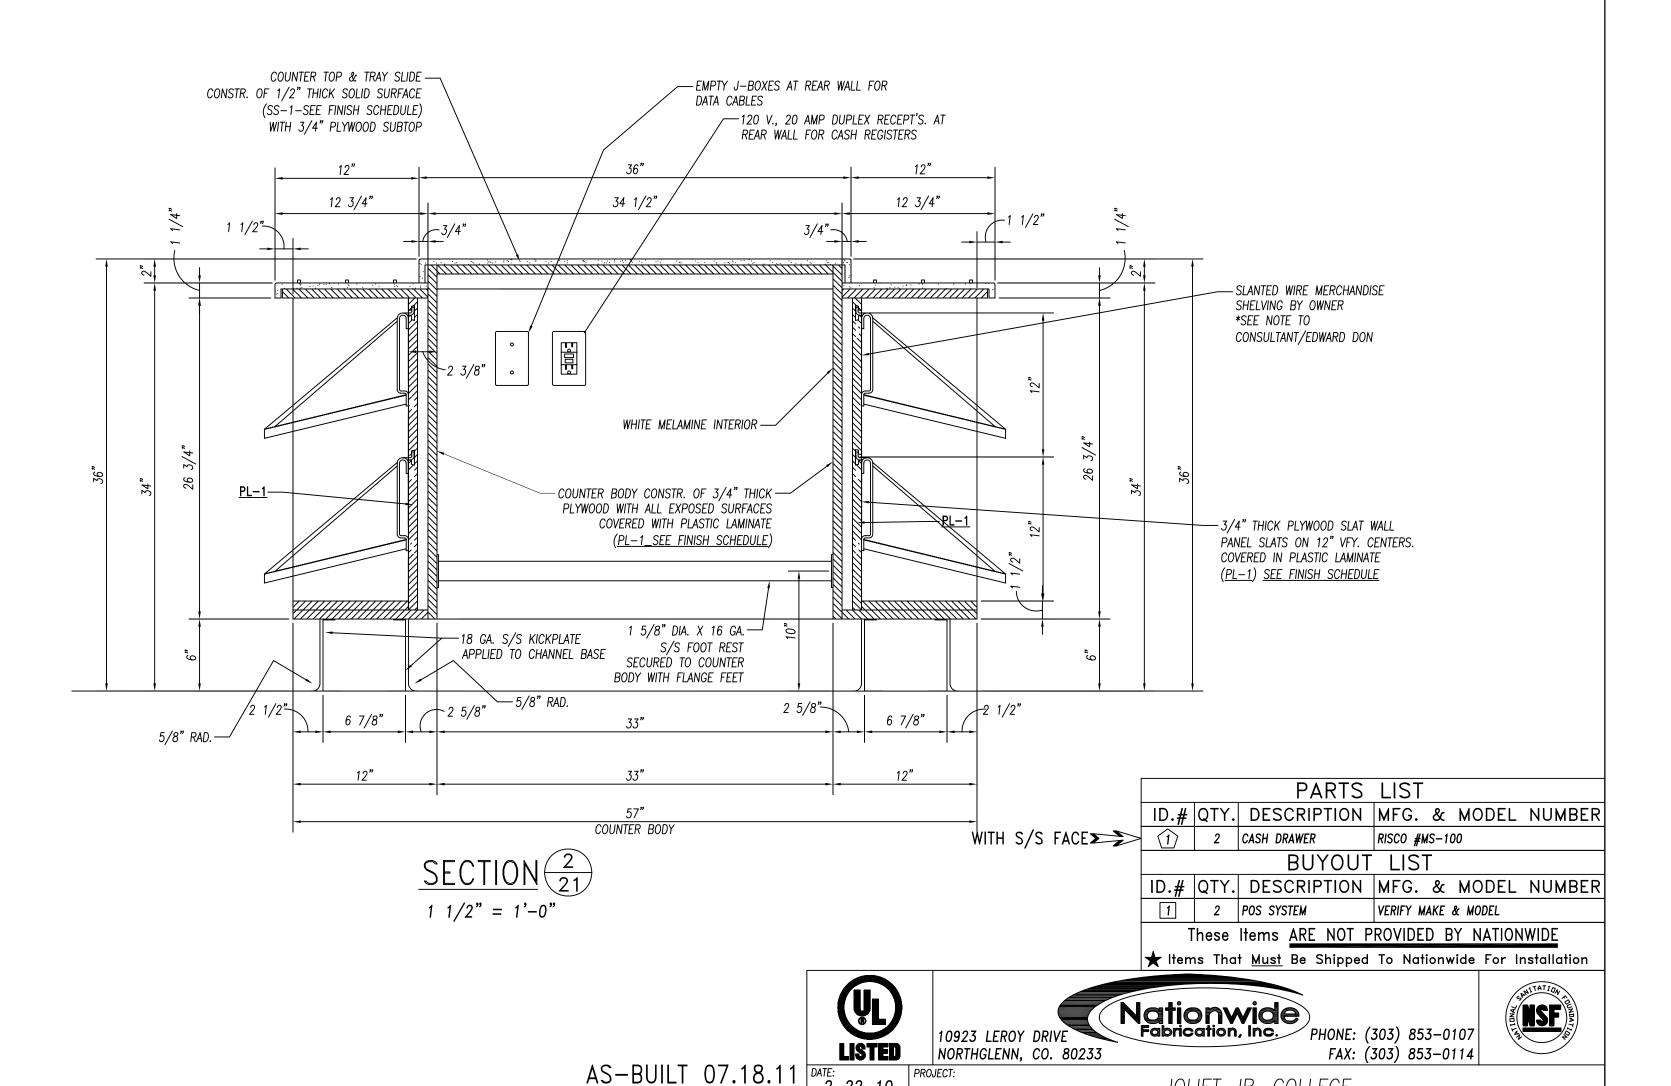

2-22-10
DRAWN BY:
CUSHING
CHECKED BY:

SCALE: AS NOTED

ITEMS THIS SHEET:

CUSTOMER:

AS-BUILT 07.18.11

REVISIONS:

Mackesey And Associates LLC

Ćrystal Lake, IL

CONSULTANT:

GENERAL NOTES

2 REINFORCEMENT-UNEXPOSED 1 1/2" X 4" X 1 1/2" X 14 GA. GALV. CHANNEL

3 REINFORCEMENT-EXPOSED | 1 1/2" X 4" X 1 1/2" X 14 GA. S/S CHANNEL

16 GA. S/S

18 GA. S/S

16 GA. S/S

FOODSERVICE EQUIPMENT FINISHES

SS-1 | 1/2" THICK SOLID SURFACE - FORMICA, COLOR: DENIM SPEX #936

1 5/8" DIA. X 16 GA. S/S TUBING

16 GA. S/S WITH 14 GA. S/S BRACKETS

18 GA. S/S DOUBLE PAN CONSTR.

SOUND DEADEN WITH STYROFOAM

FULLY AT UNDERSIDE OF TOPS

COUNTERTOP, TRAYSLIDE

COUNTER FRONT -3/4" PLYWOOD WITH WHITE MELAMINE FINISH ON UNEXPOSED SIDE, & ALL EXPOSED COVERED IN PLASTIC LAMINATE

FORMICA, 6208-LX, GLAMOUR CHERRY

2" X 2" MOSAIC GLAZED TILE -CERAMIC VOGUE or ROYAL MOSA, FINISH: TRANSPARENZA. MOSAIC COLORS: Albicocca(orange), Giallo(yellow), Lavanda(lavender), Giada(light green), Grigio(medium grey), Ferro(dark grey)
-PROVIDE EQUAL AMOUNTS OF 6 COLORS APPLIED IN RANDOM PATTERN

TILE TRIM-STAINLESS STEEL EDGE STRIP SCHLUTER SYSTEMS, QUADEC, OR APPROVED EQUAL

CHROME ACORN NUTZ NO EXPOSED FASTNERS

14 GA. S/S

NO. DESCRIPTION | MATERIAL

TOPS AND SINKS

4 LEGS & CROSSRAILS

5 REMOV. UNDERSHELVES

6 WALL & OVERSHELVES

8 DOOR AND DRAWER FACES

JOLIET JR. COLLEGE

Joliet, IL

EDWARD DON

North Riverside, IL

ITEM:138 CASHIER COUNTER

SECTIONS

PAGE NUMBER

21 OF 24

JOB NUMBER


5789


9 | FIXED UNDERSHELVES


10 SOUND DEADENING

11 FASTNERS

7 COUNTER BODY

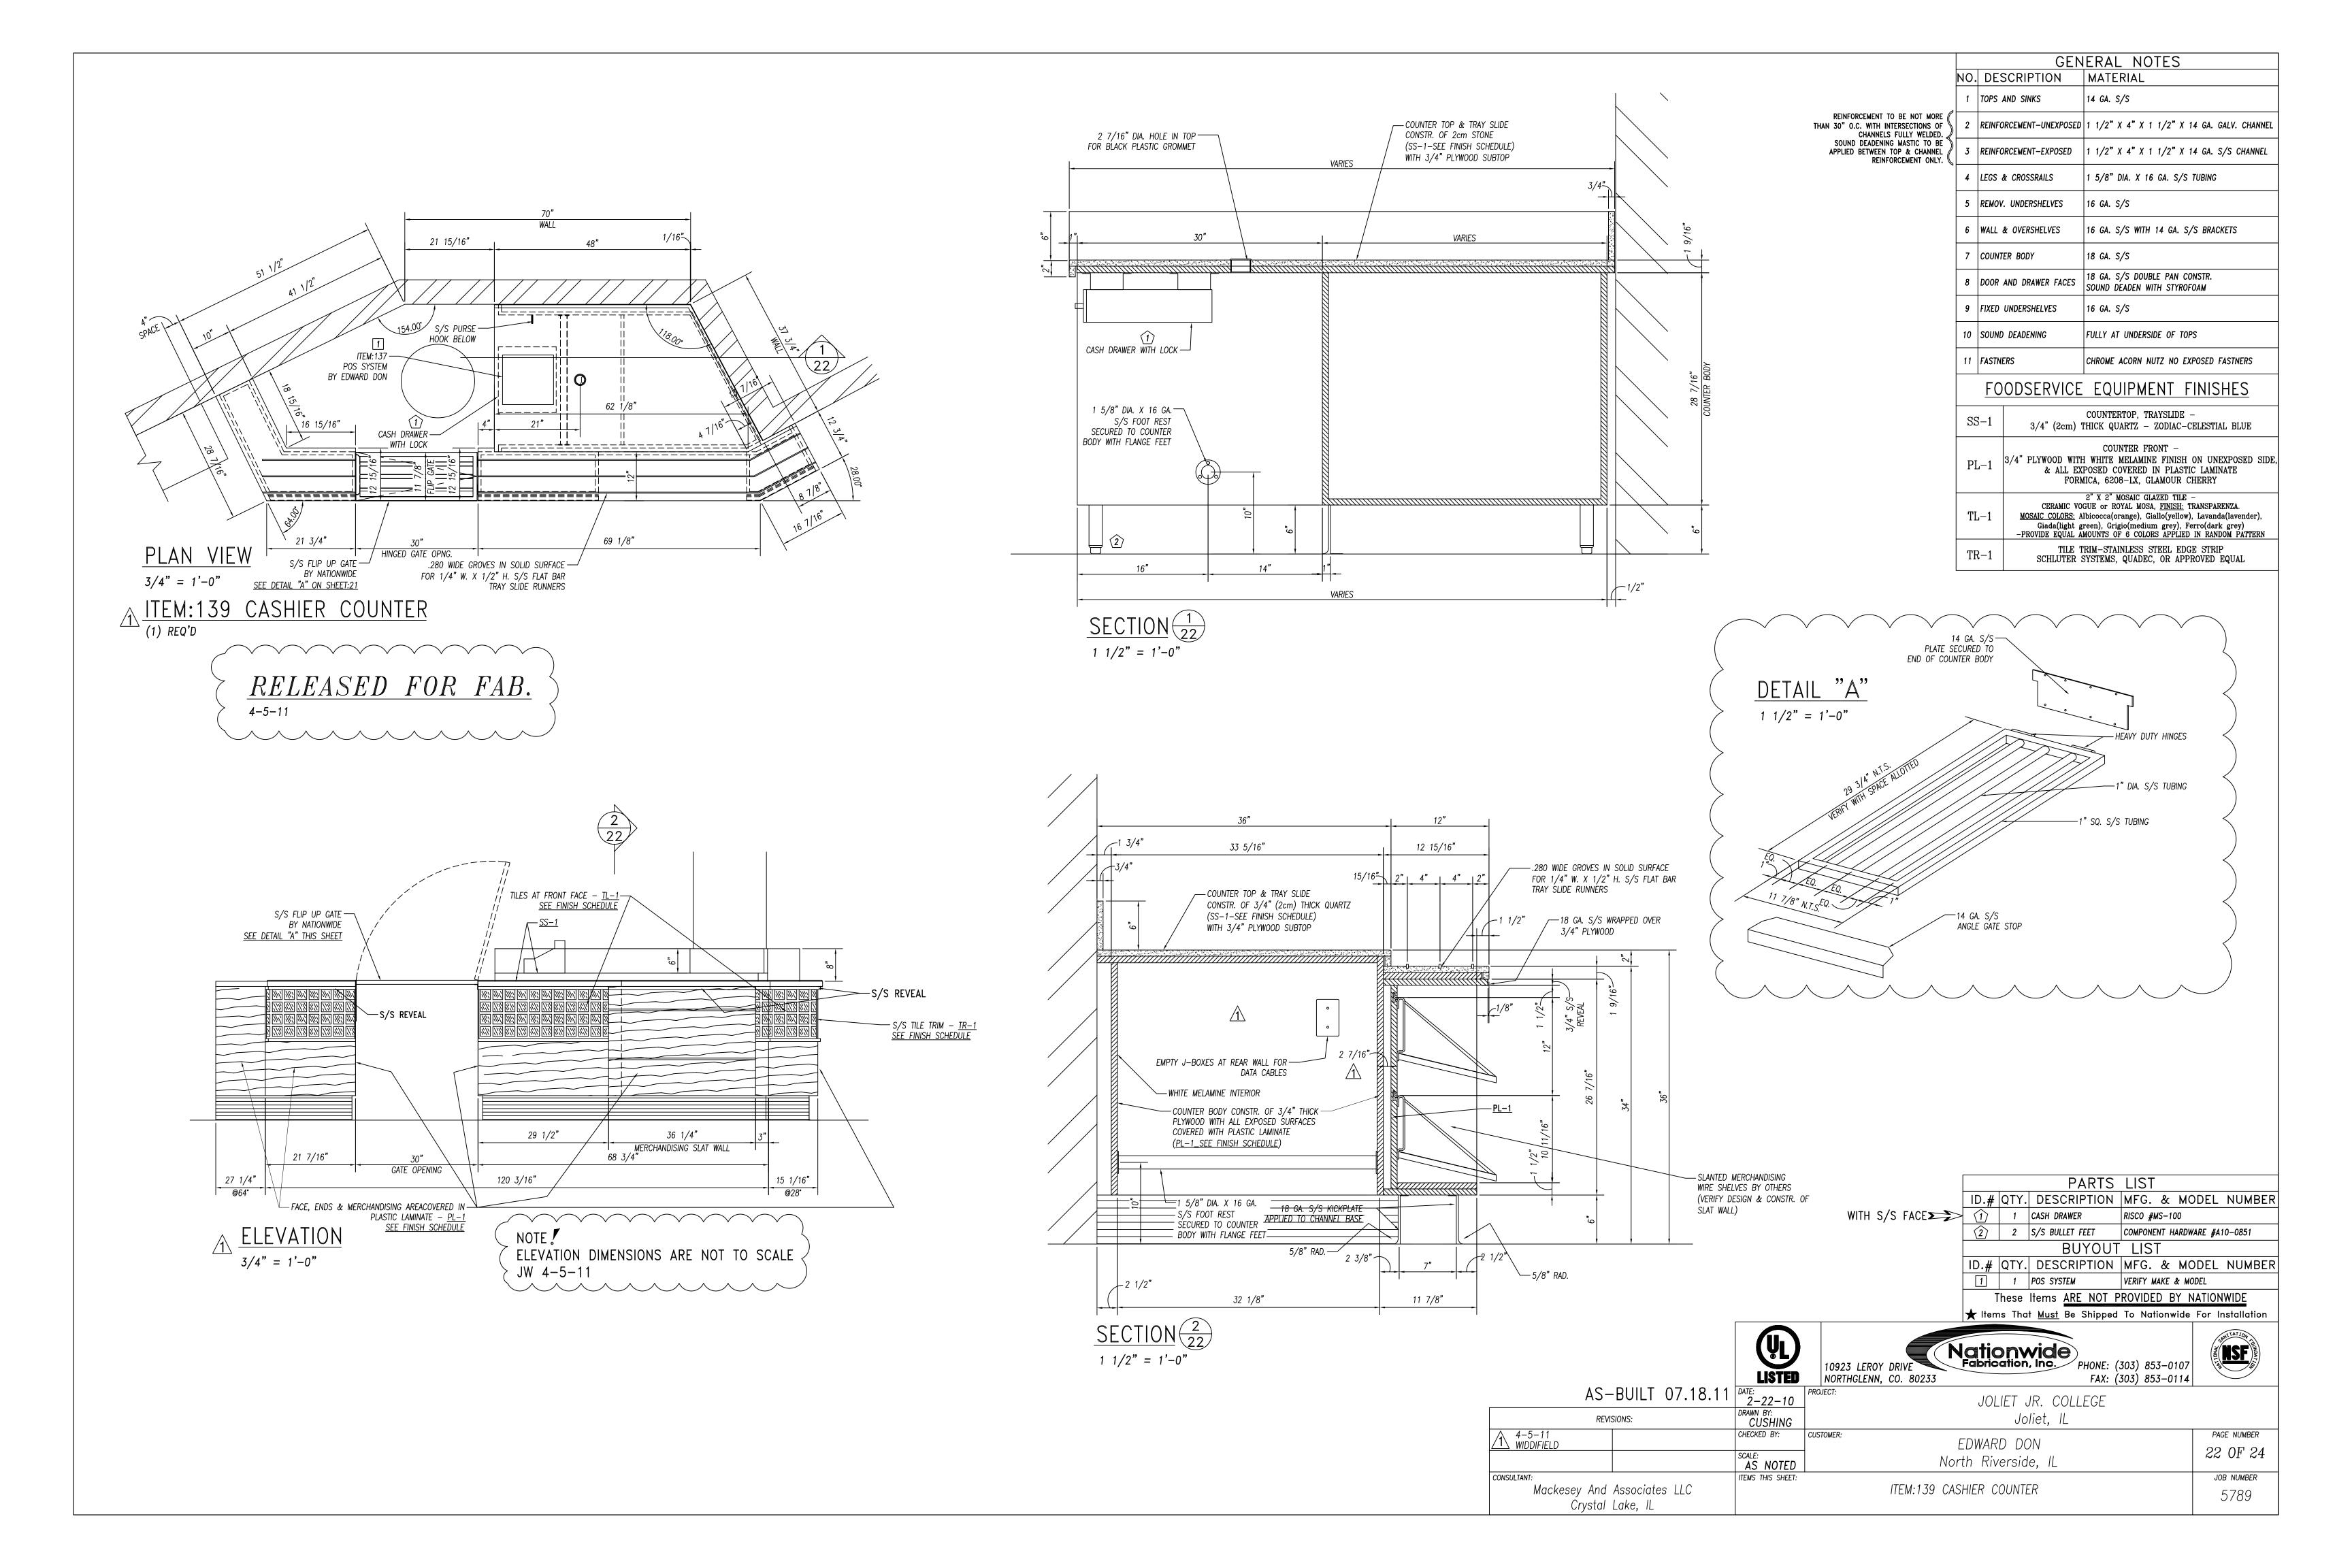

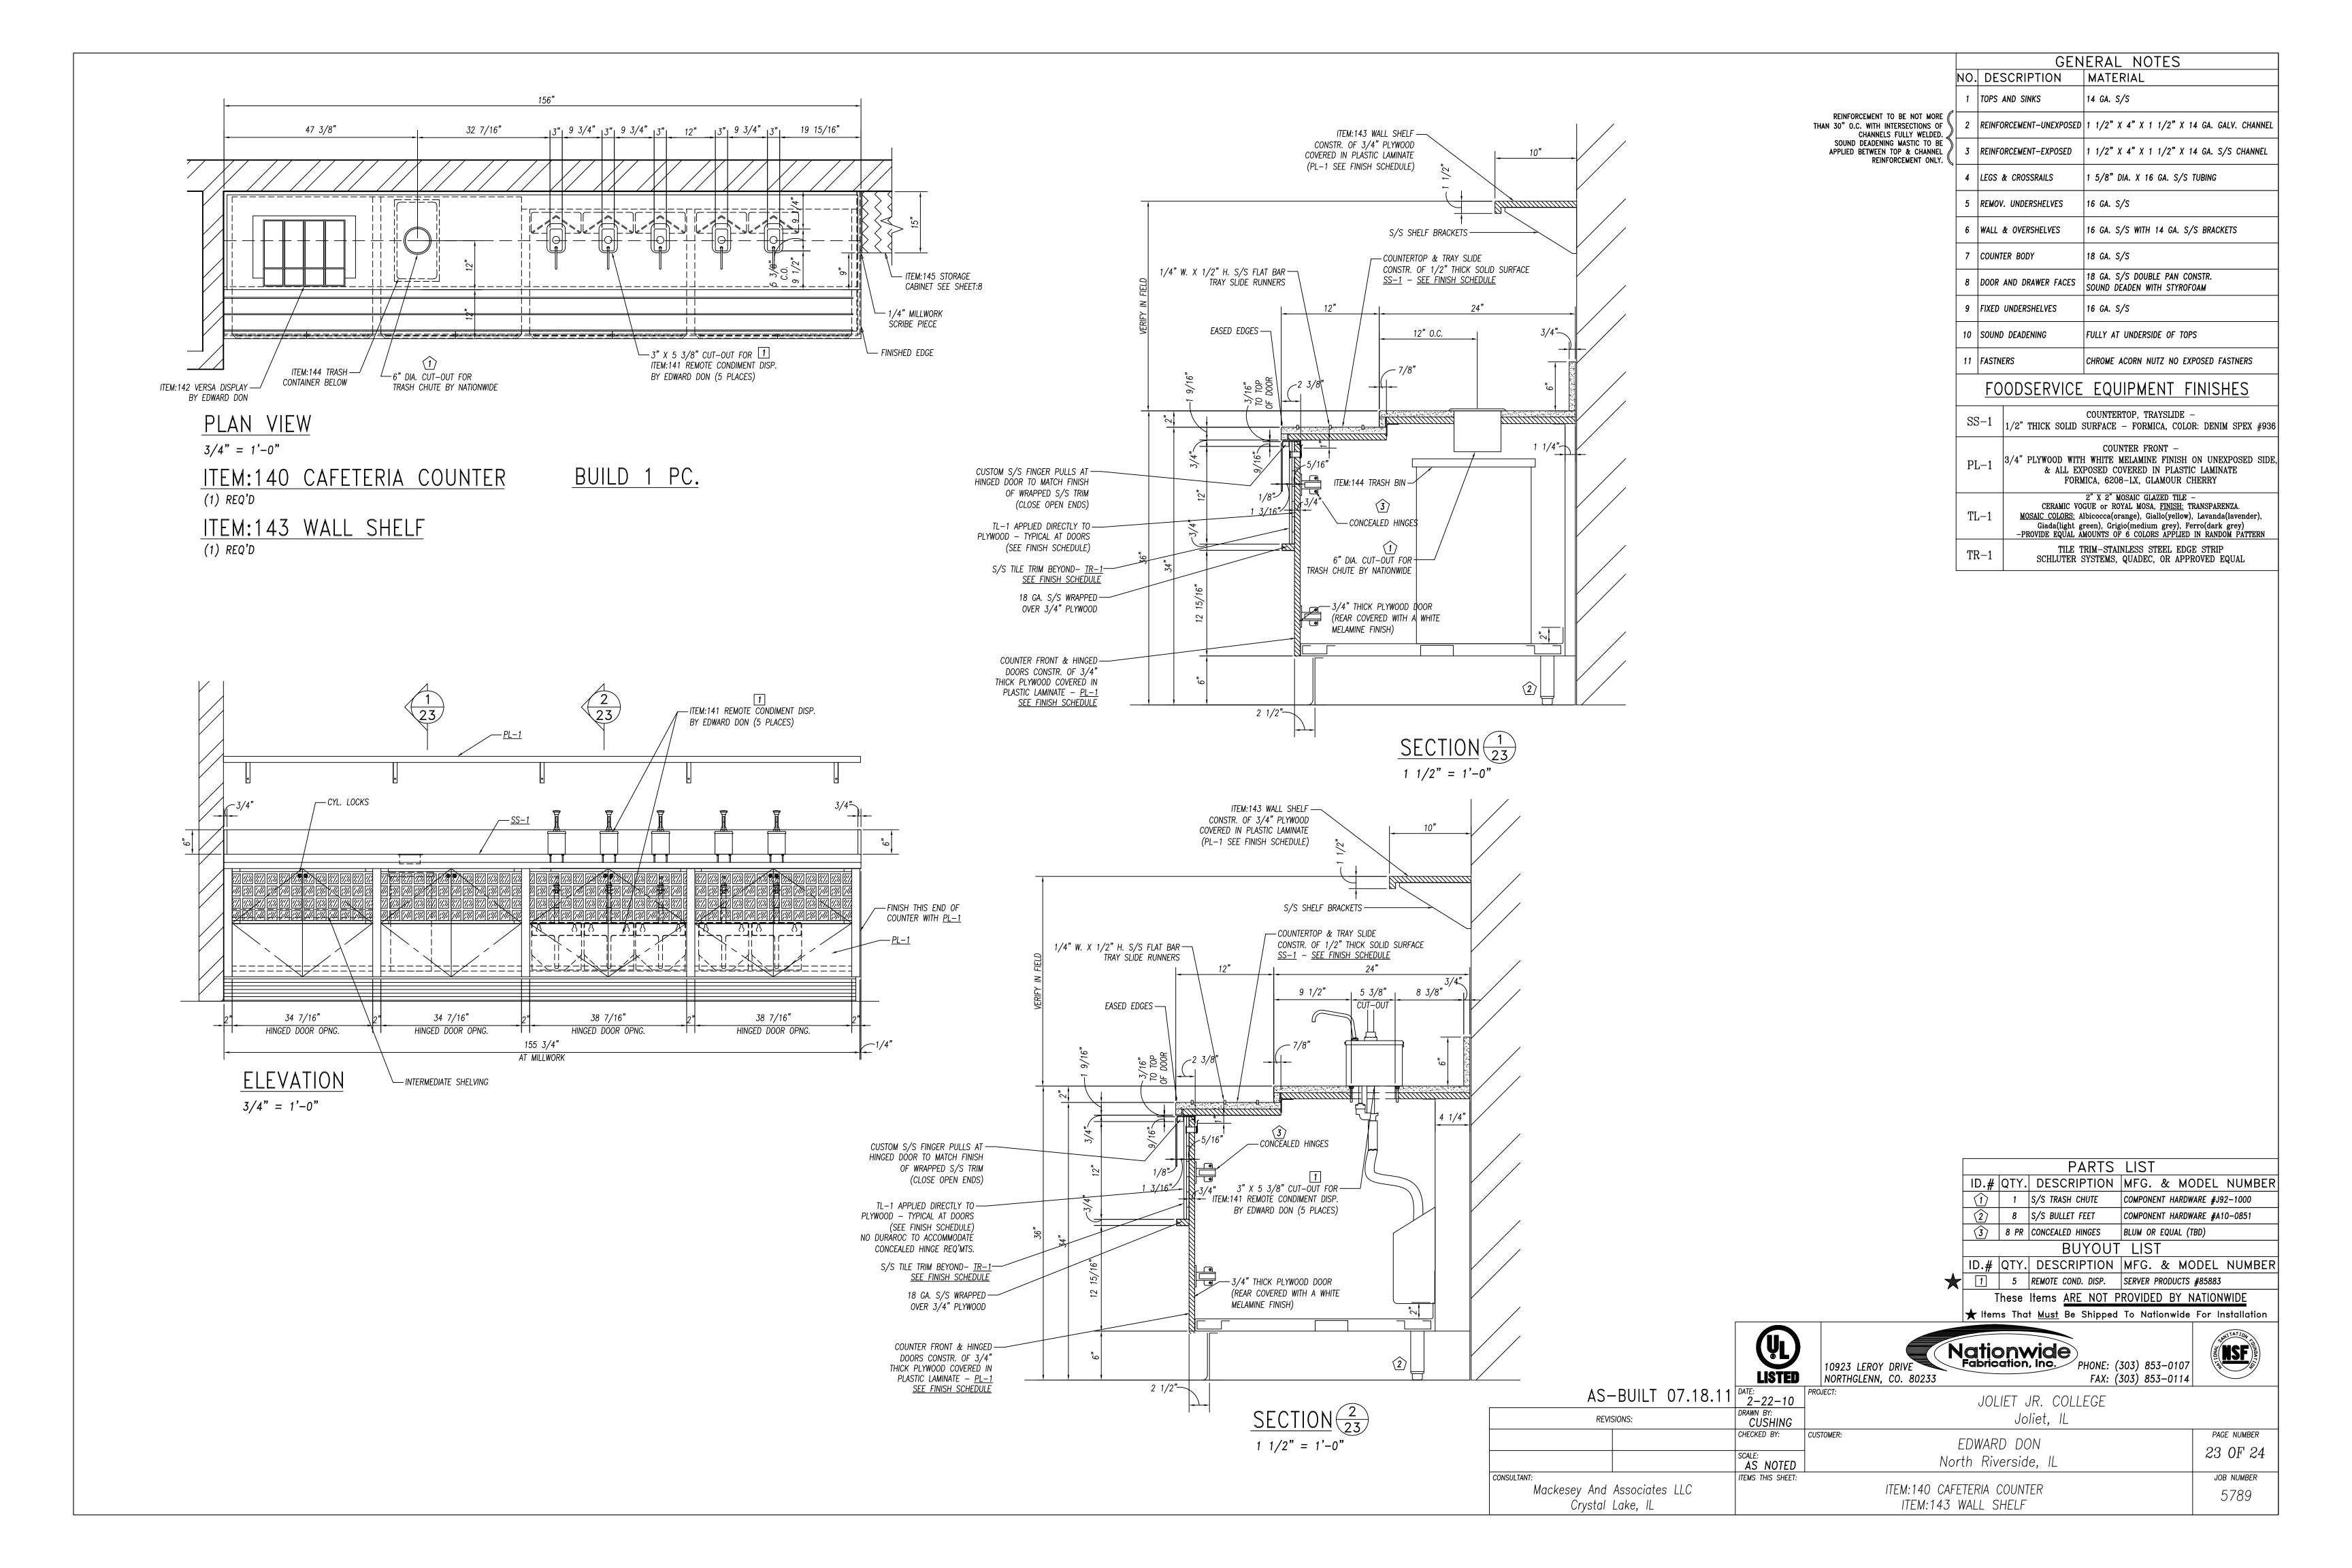

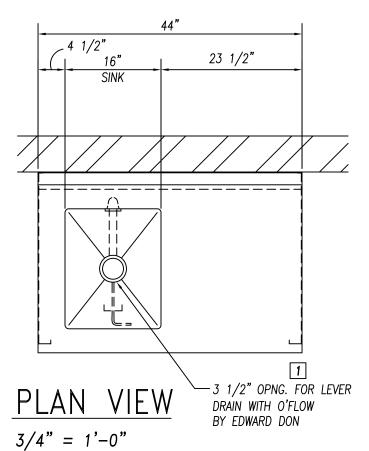


ITEM: 103 CAFETERIA COUNTER W/SINK
(1) REQ'D.

NOTE TO SHOP!

> S/S HINGED DOOR HARDWARE


> CONSISTS OF S/S LIFT-OFF

> HINGES AND FRICTION CATCHES

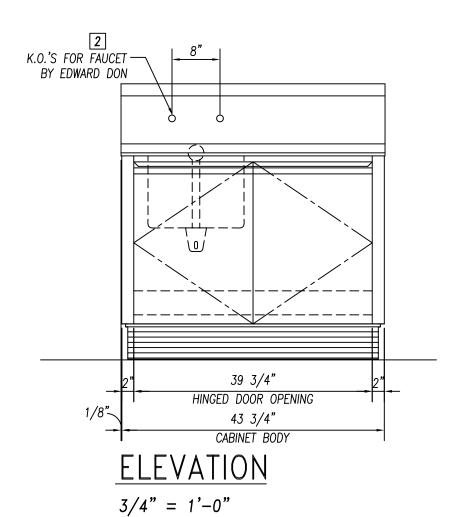


SECTION

1 1/2" = 1'-0"

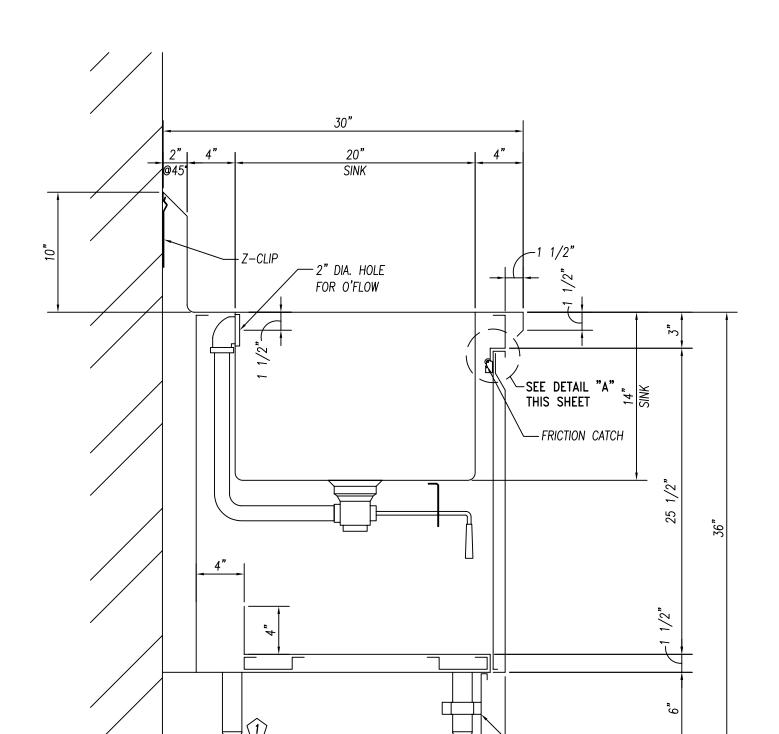

18 GA. S/S REMOV. KICKPLATE AT FRONT & BOTH ENDS

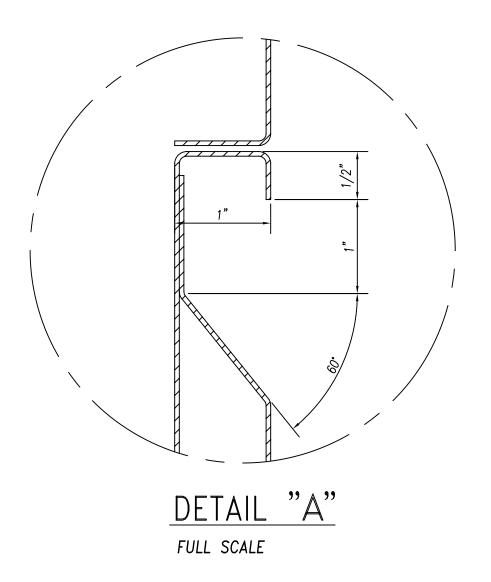

NOTE TO EDWARD DON!

VERIFY DIMENSIONS FOR

ITEM:115 S/S TRIM

ITEM: 115 S/S TRIM
(1) LOT REQ'D.


NOTE TO SHOP ! UPON VERIFYING DIMENSIONS FOR ITEM:115 S/S TRIM. REFER TO STANDARD DETAIL ON SHT:FS6.1 OF THE CONTRACT DRAWINGS REINFORCEMENT TO BE NOT MORE
THAN 30" O.C. WITH INTERSECTIONS OF
CHANNELS FULLY WELDED.
SOUND DEADENING MASTIC TO BE
APPLIED BETWEEN TOP & CHANNEL
REINFORCEMENT ONLY.


		GEN	ERAL NOTES
	NO.	DESCRIPTION	MATERIAL
4	1	TOPS AND SINKS	14 GA. S/S
E ()	2	REINFORCEMENT-UNEXPOSED	1 1/2" X 4" X 1 1/2" X 14 GA. GALV. CHANNEL
E L	3	REINFORCEMENT-EXPOSED	1 1/2" X 4" X 1 1/2" X 14 GA. S/S CHANNEL
•	4	LEGS & CROSSRAILS	1 5/8" DIA. X 16 GA. S/S TUBING
	5	REMOV. UNDERSHELVES	16 GA. S/S
	6	WALL & OVERSHELVES	16 GA. S/S WITH 14 GA. S/S BRACKETS
	7	COUNTER BODY	18 GA. S/S
	8	DOOR AND DRAWER FACES	18 GA. S/S DOUBLE PAN CONSTR. SOUND DEADEN WITH STYROFOAM
	9	FIXED UNDERSHELVES	16 GA. S/S
	10	SOUND DEADENING	FULLY AT UNDERSIDE OF TOPS
	11	FASTNERS	CHROME ACORN NUTZ NO EXPOSED FASTNERS


		PARTS	LIST
ID.#	QTY.	DESCRIPTION	MFG. & MODEL NUMBER
1	4	S/S BULLET FEET	COMPONENT HARDWARE #A10-0851
		BUYOUT	LIST
ID.#	QTY.	DESCRIPTION	MFG. & MODEL NUMBER
1	1	LEVER DRAIN W/O'FLOW	T & S #B-3970-01
2	1	FAUCET	T & S #B-0231/B-0199-01 AERATOR


									NITATION	_
	★ Items Th	nat <u>Must</u>	Ве	Shippe	d To	Natio	nwide	For	Installat	ŀi
	These	e Items	ARE	NOT	PRO\	/IDED	BY 1	OITAN	NWIDE	


	LISTED	NORTHGLENN, CO. 80233 FAX: (303) 853-0114	
AS-BUILT 07.18.11	DATE: 2-22-10	PROJECT: JOLIET JR. COLLEGE	
REVISIONS:	DRAWN BY: CUSHING	Joliet, IL	
	CHECKED BY:	CUSTOMER: EDWARD DON	PAGE NUMBER
	SCALE: AS NOTED	North Riverside, IL	24 OF 24
CONSULTANT:	ITEMS THIS SHEET:		JOB NUMBER
Mackesey And Associates LLC Crystal Lake, IL		ITEM:103 CAFETERIA COUNTER W/SINK ITEM:115 S/S TRIM	5789

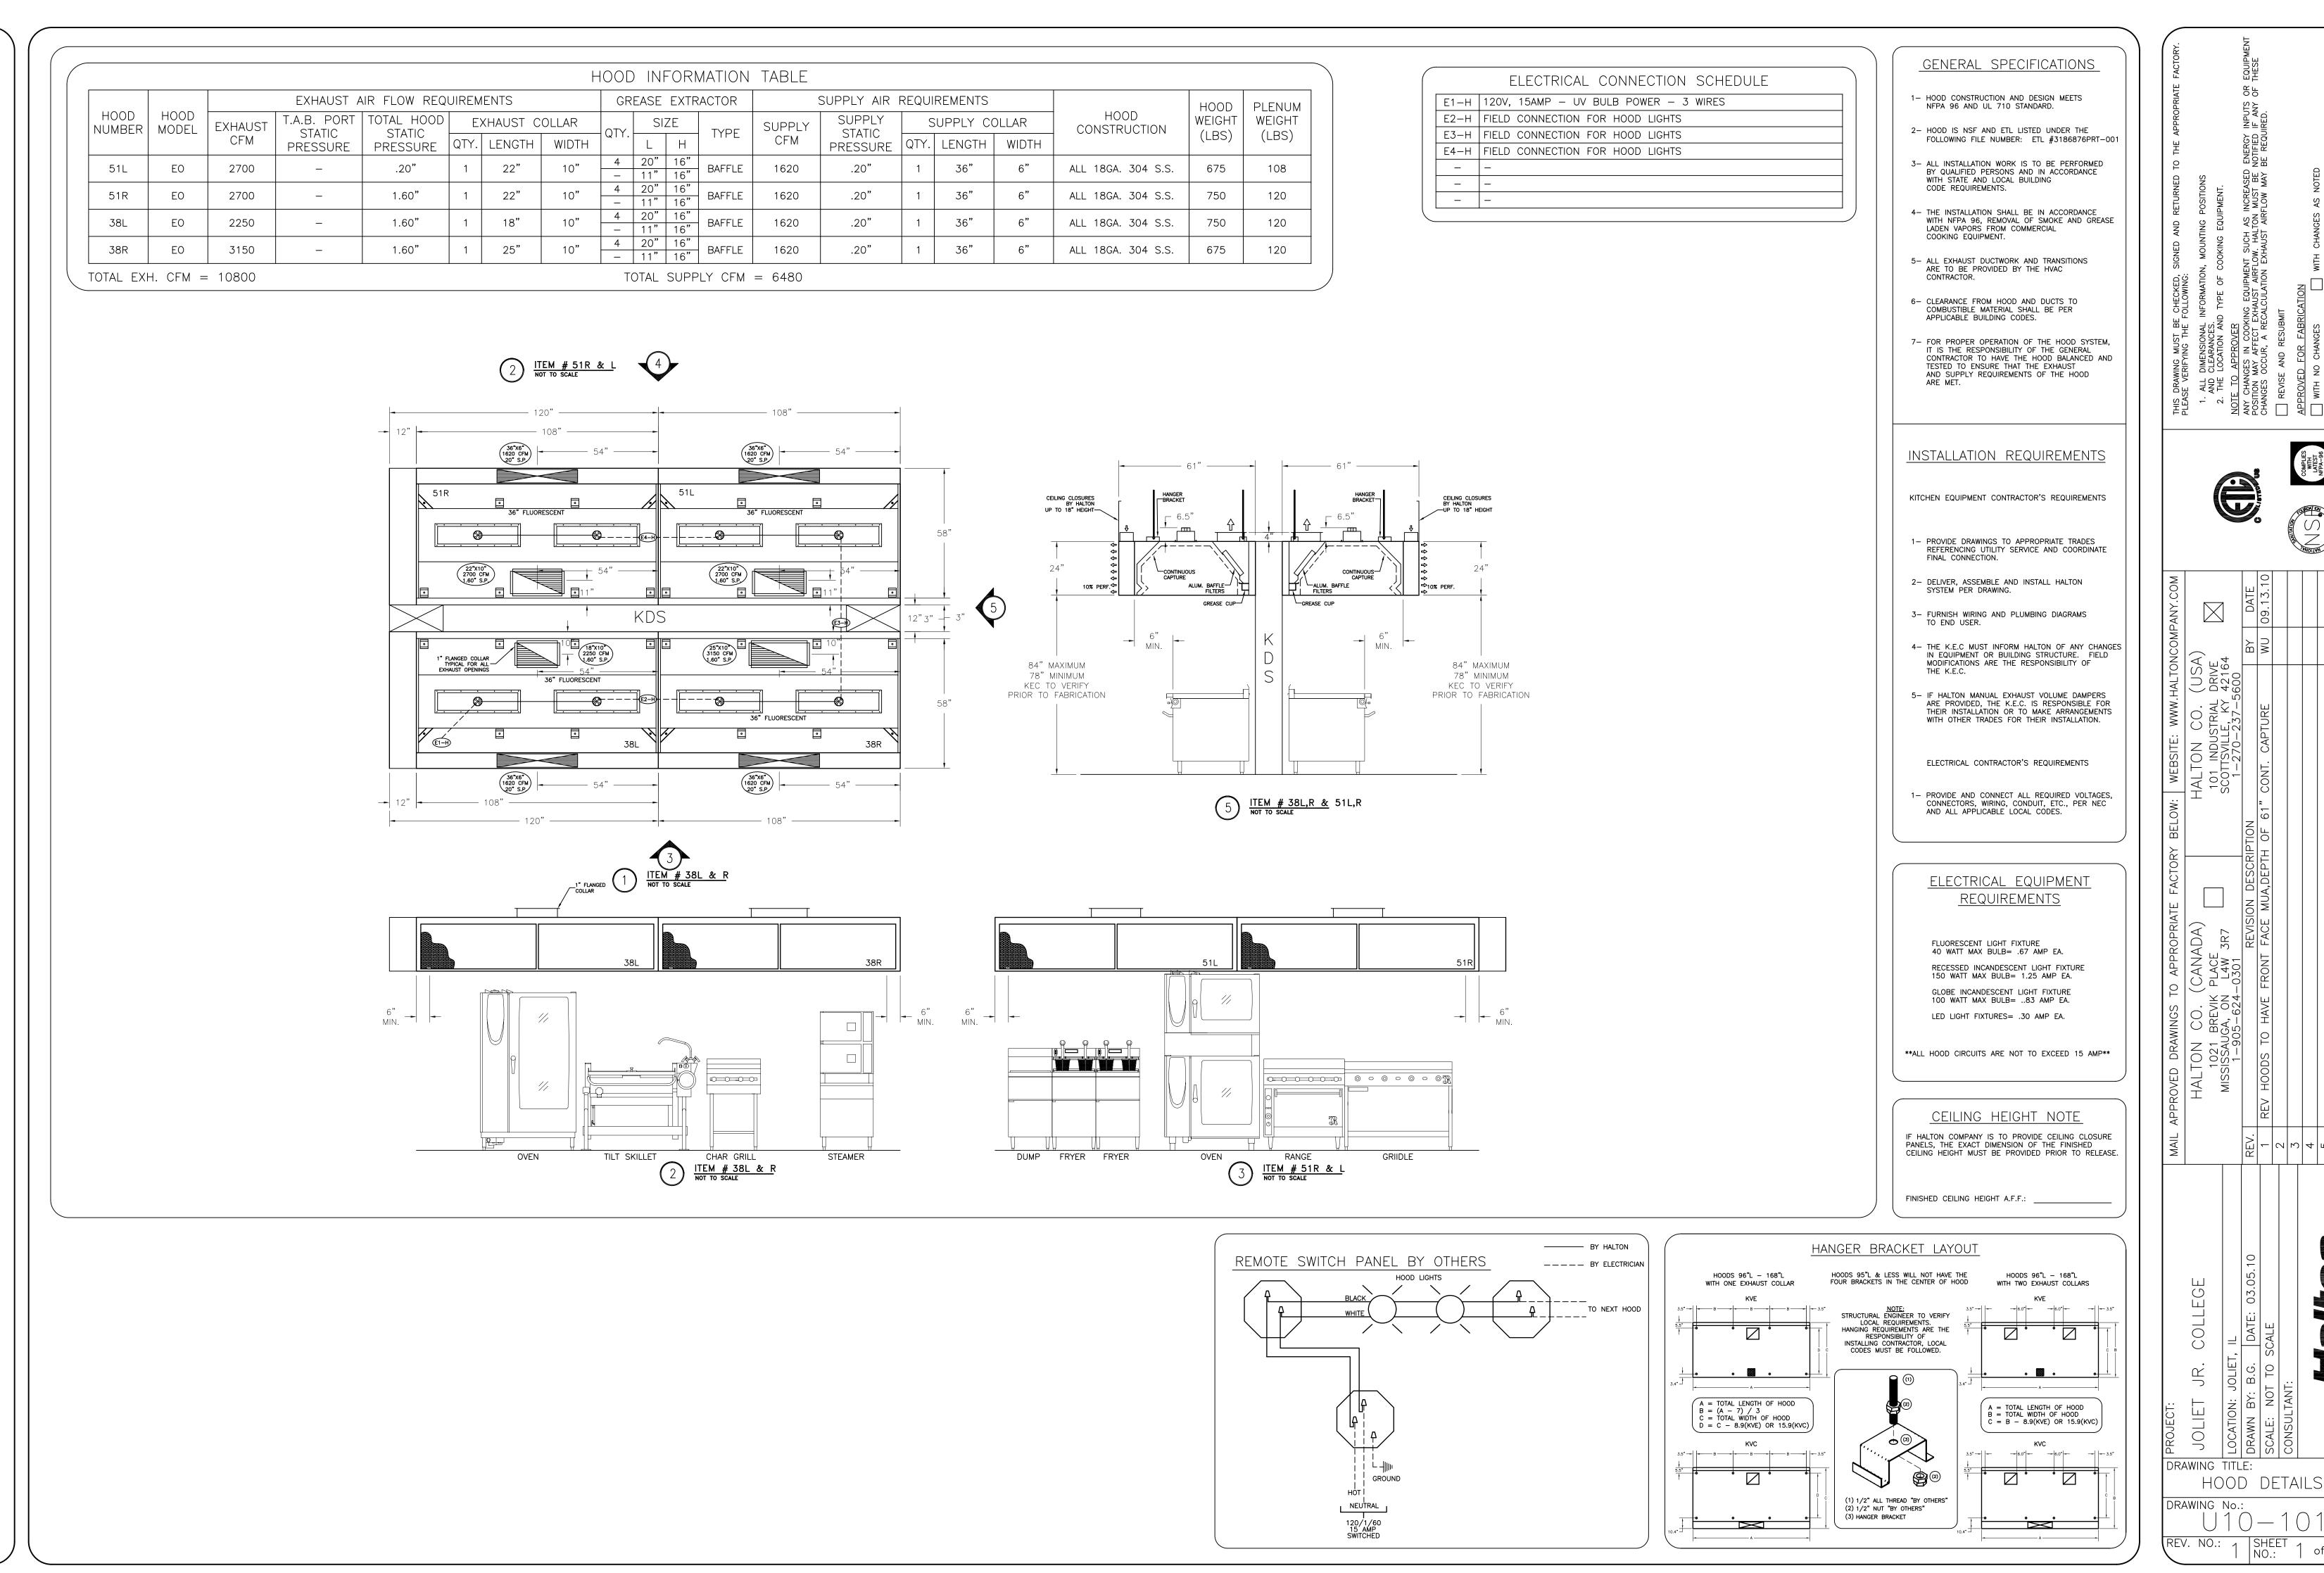


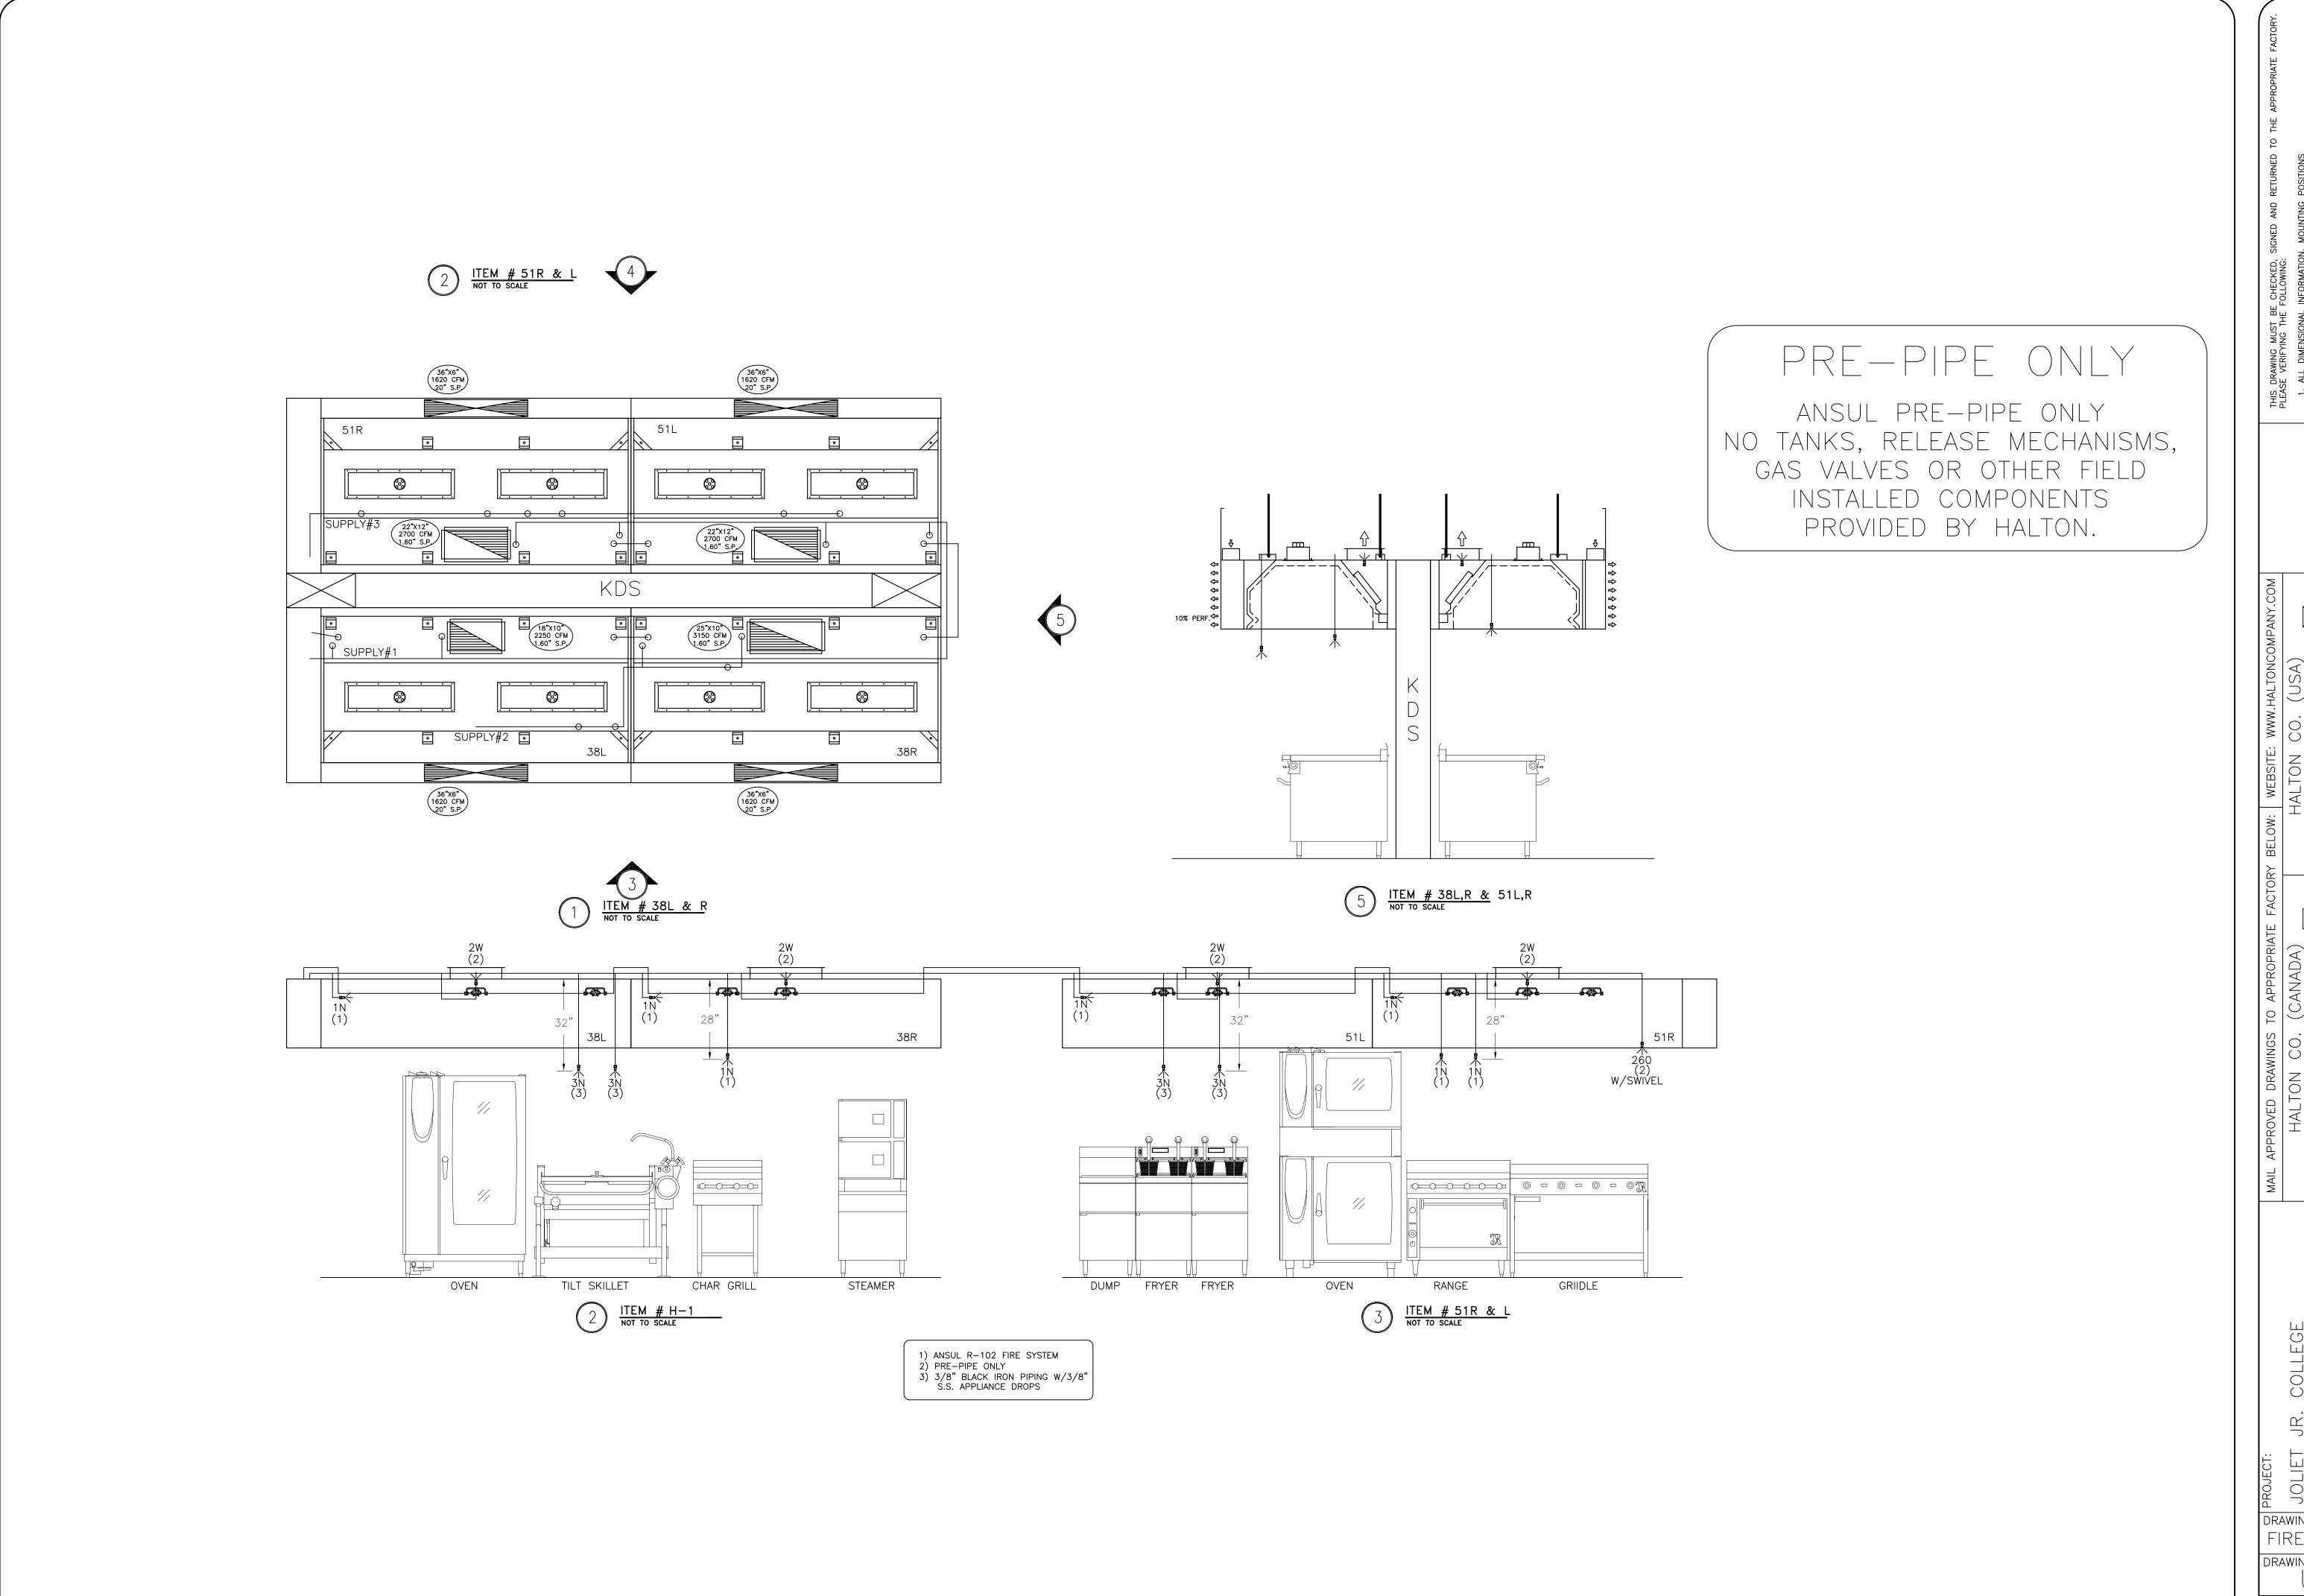


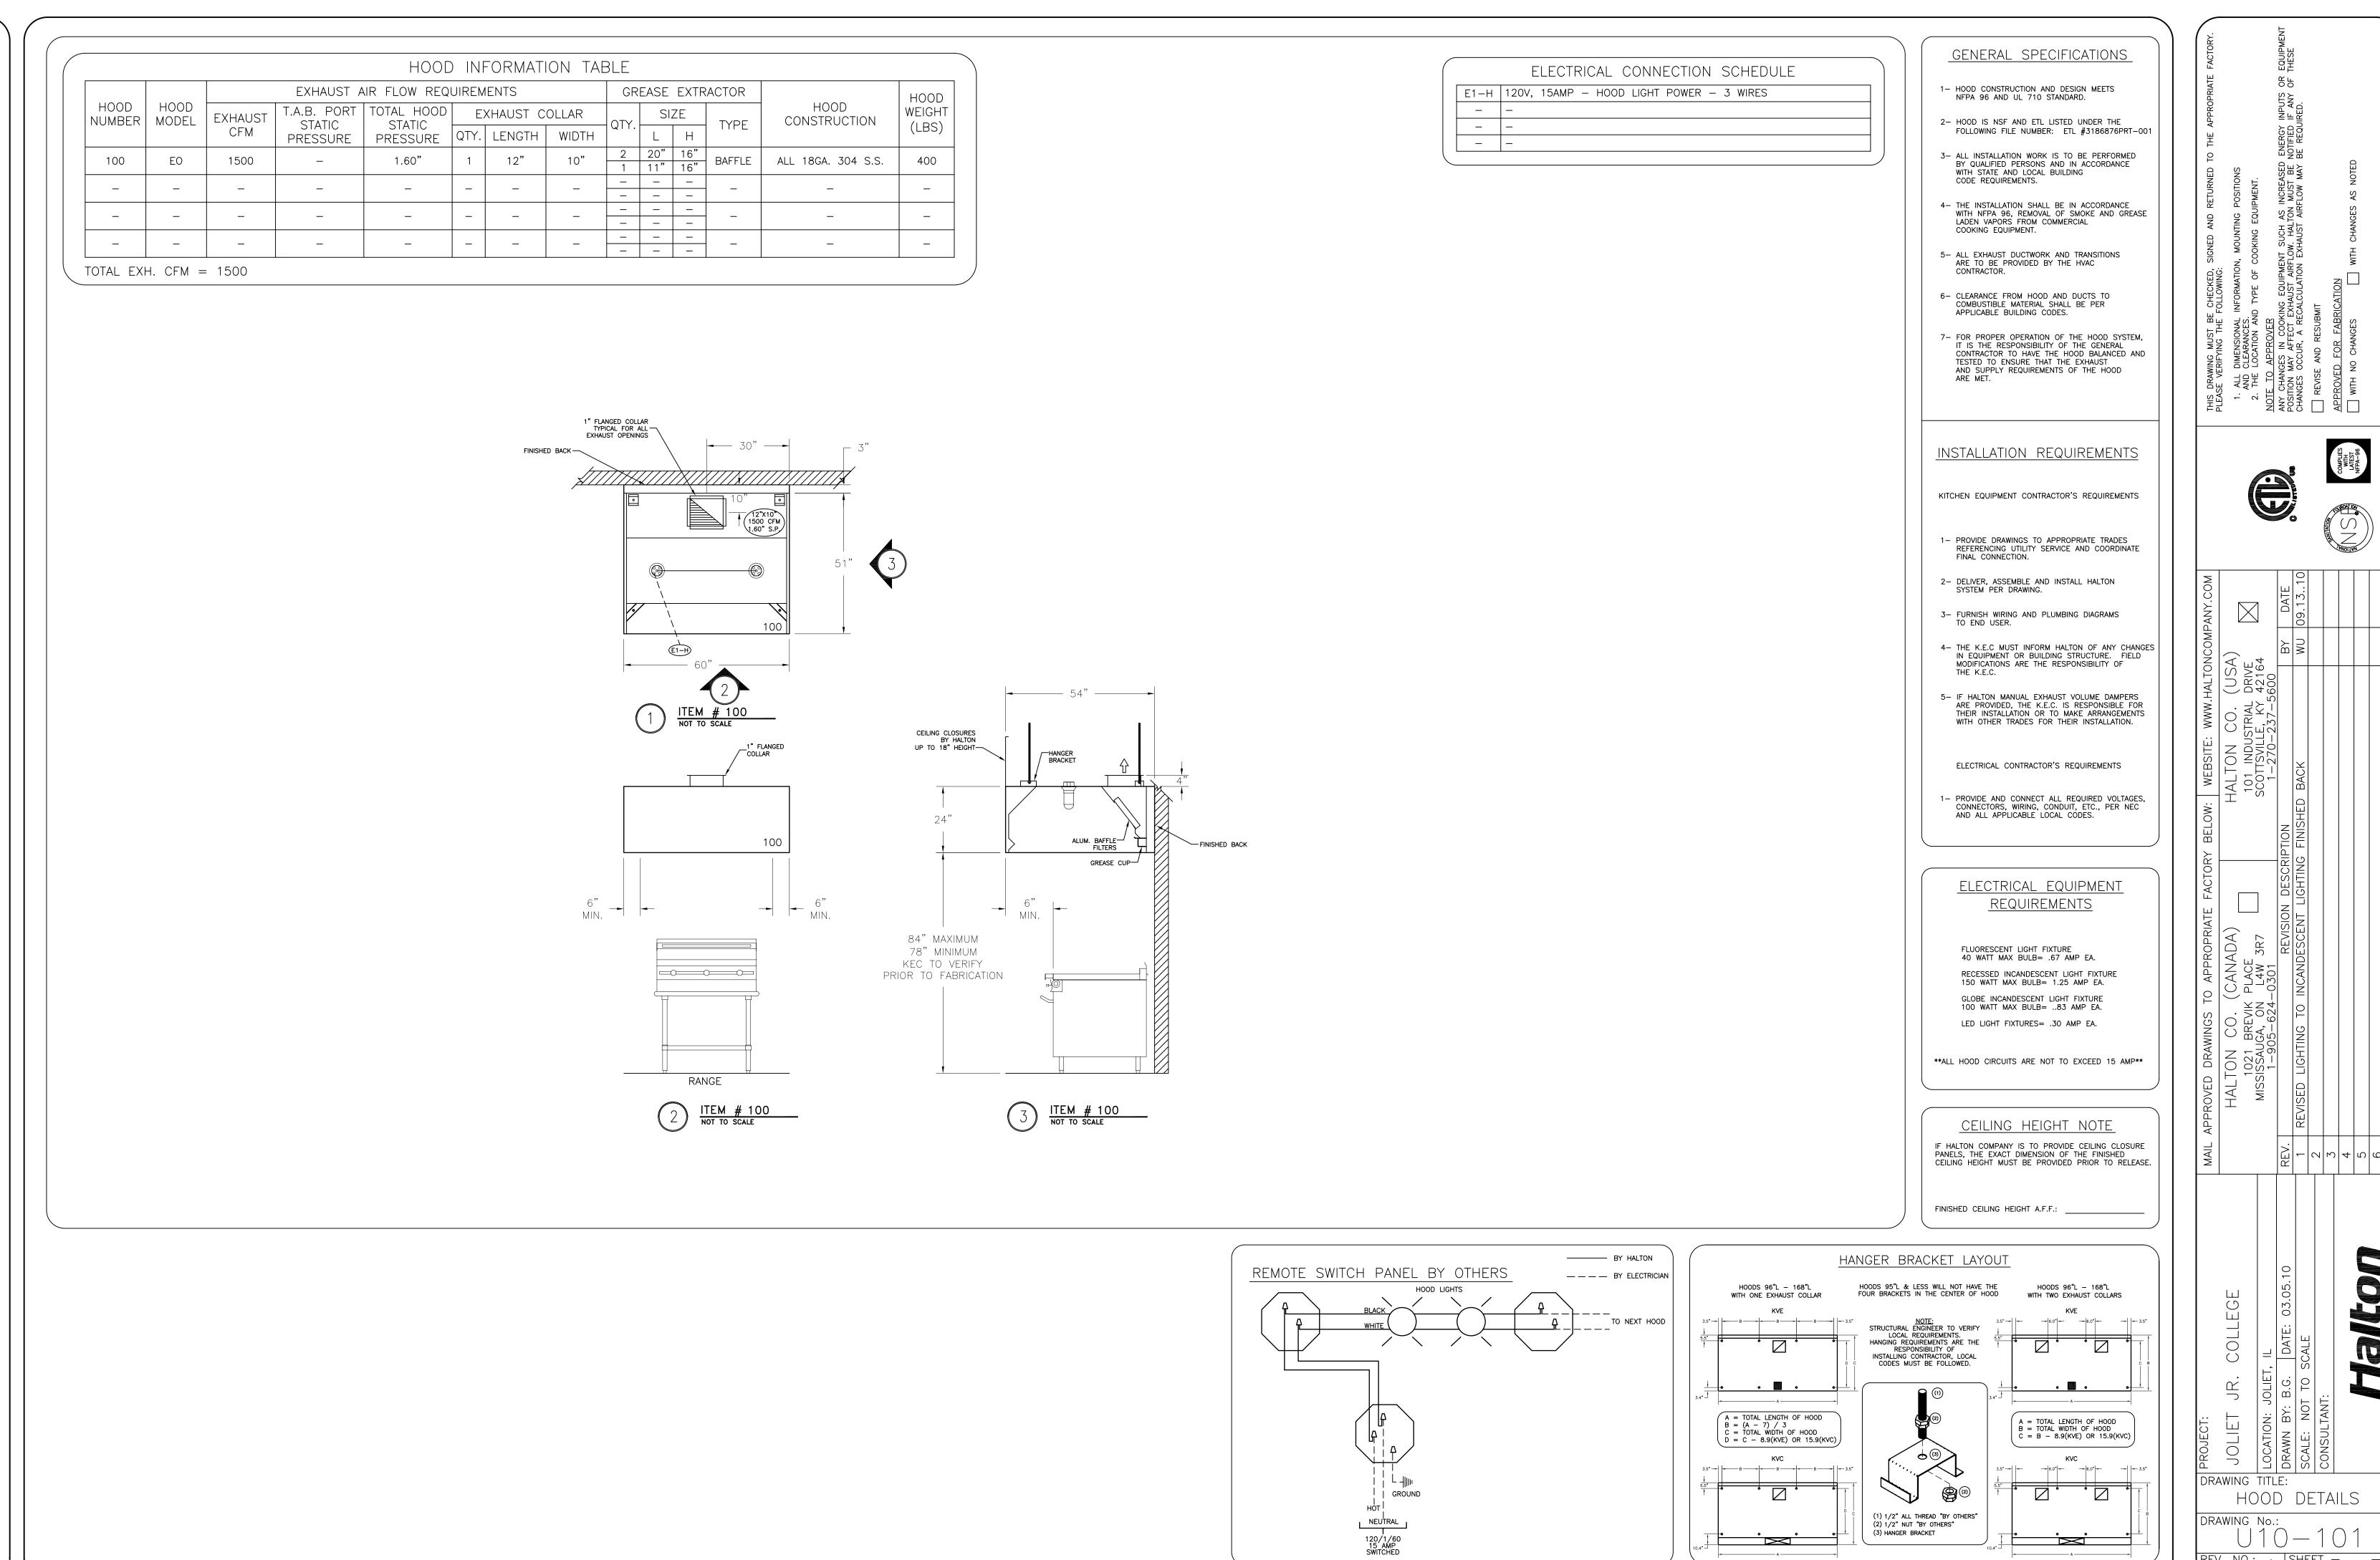


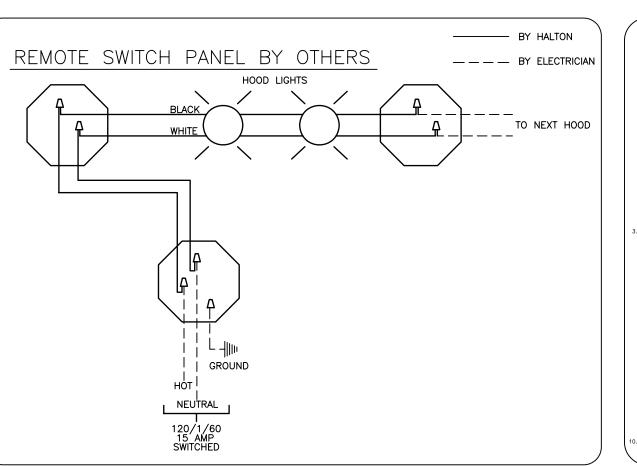

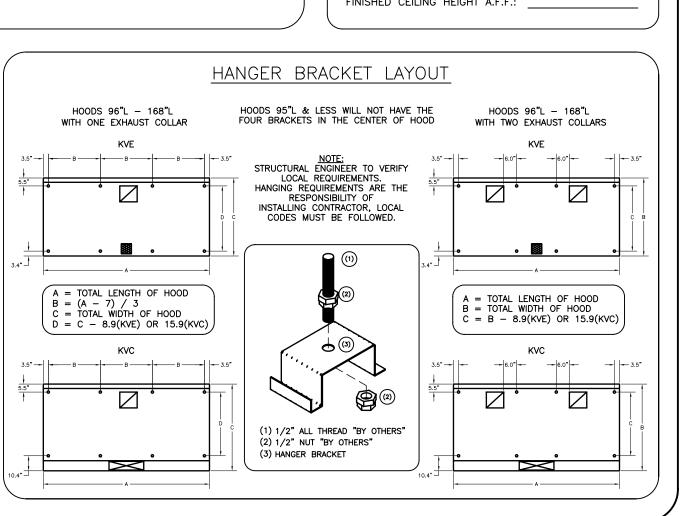

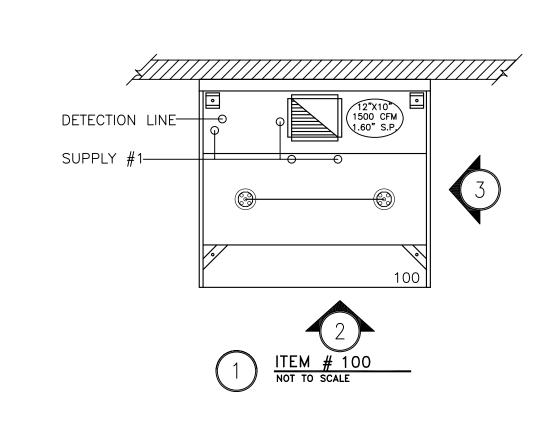


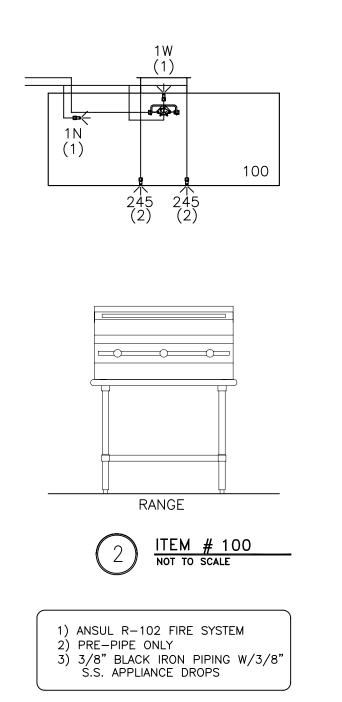


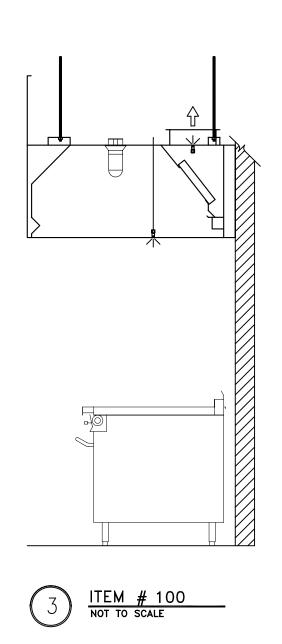


PRE-PIPE ONLY

ANSUL PRE-PIPE ONLY
NO TANKS, RELEASE MECHANISMS,
GAS VALVES OR OTHER FIELD
INSTALLED COMPONENTS
PROVIDED BY HALTON.

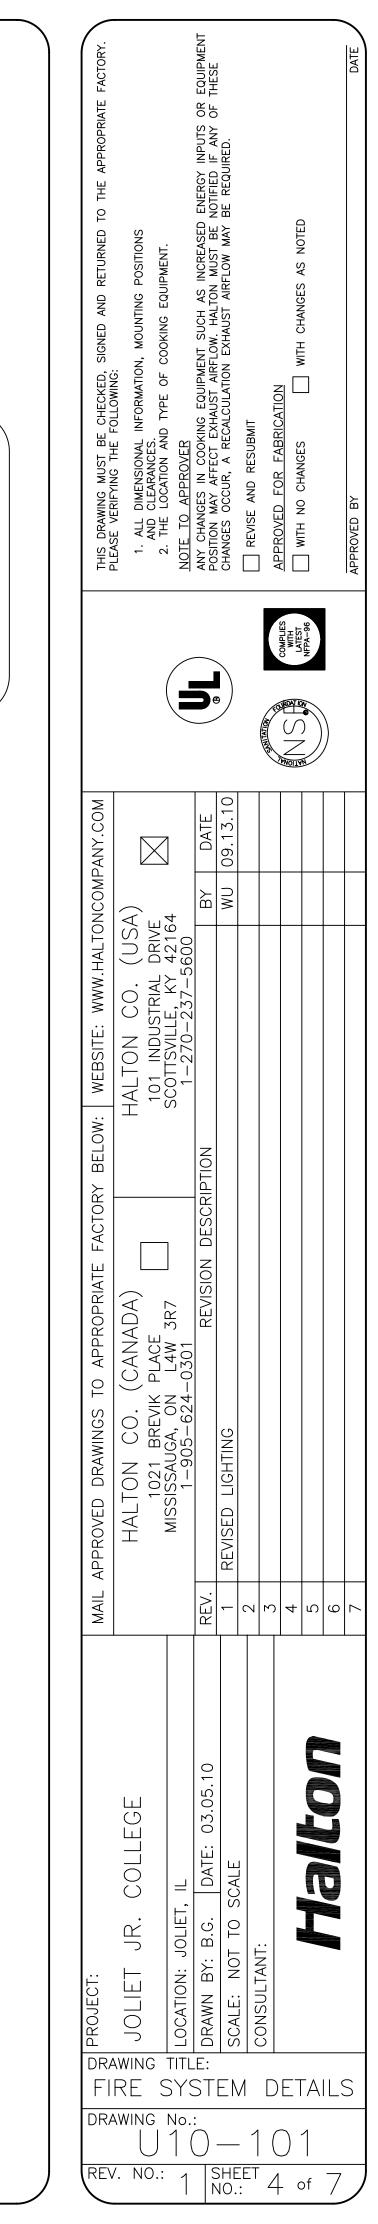


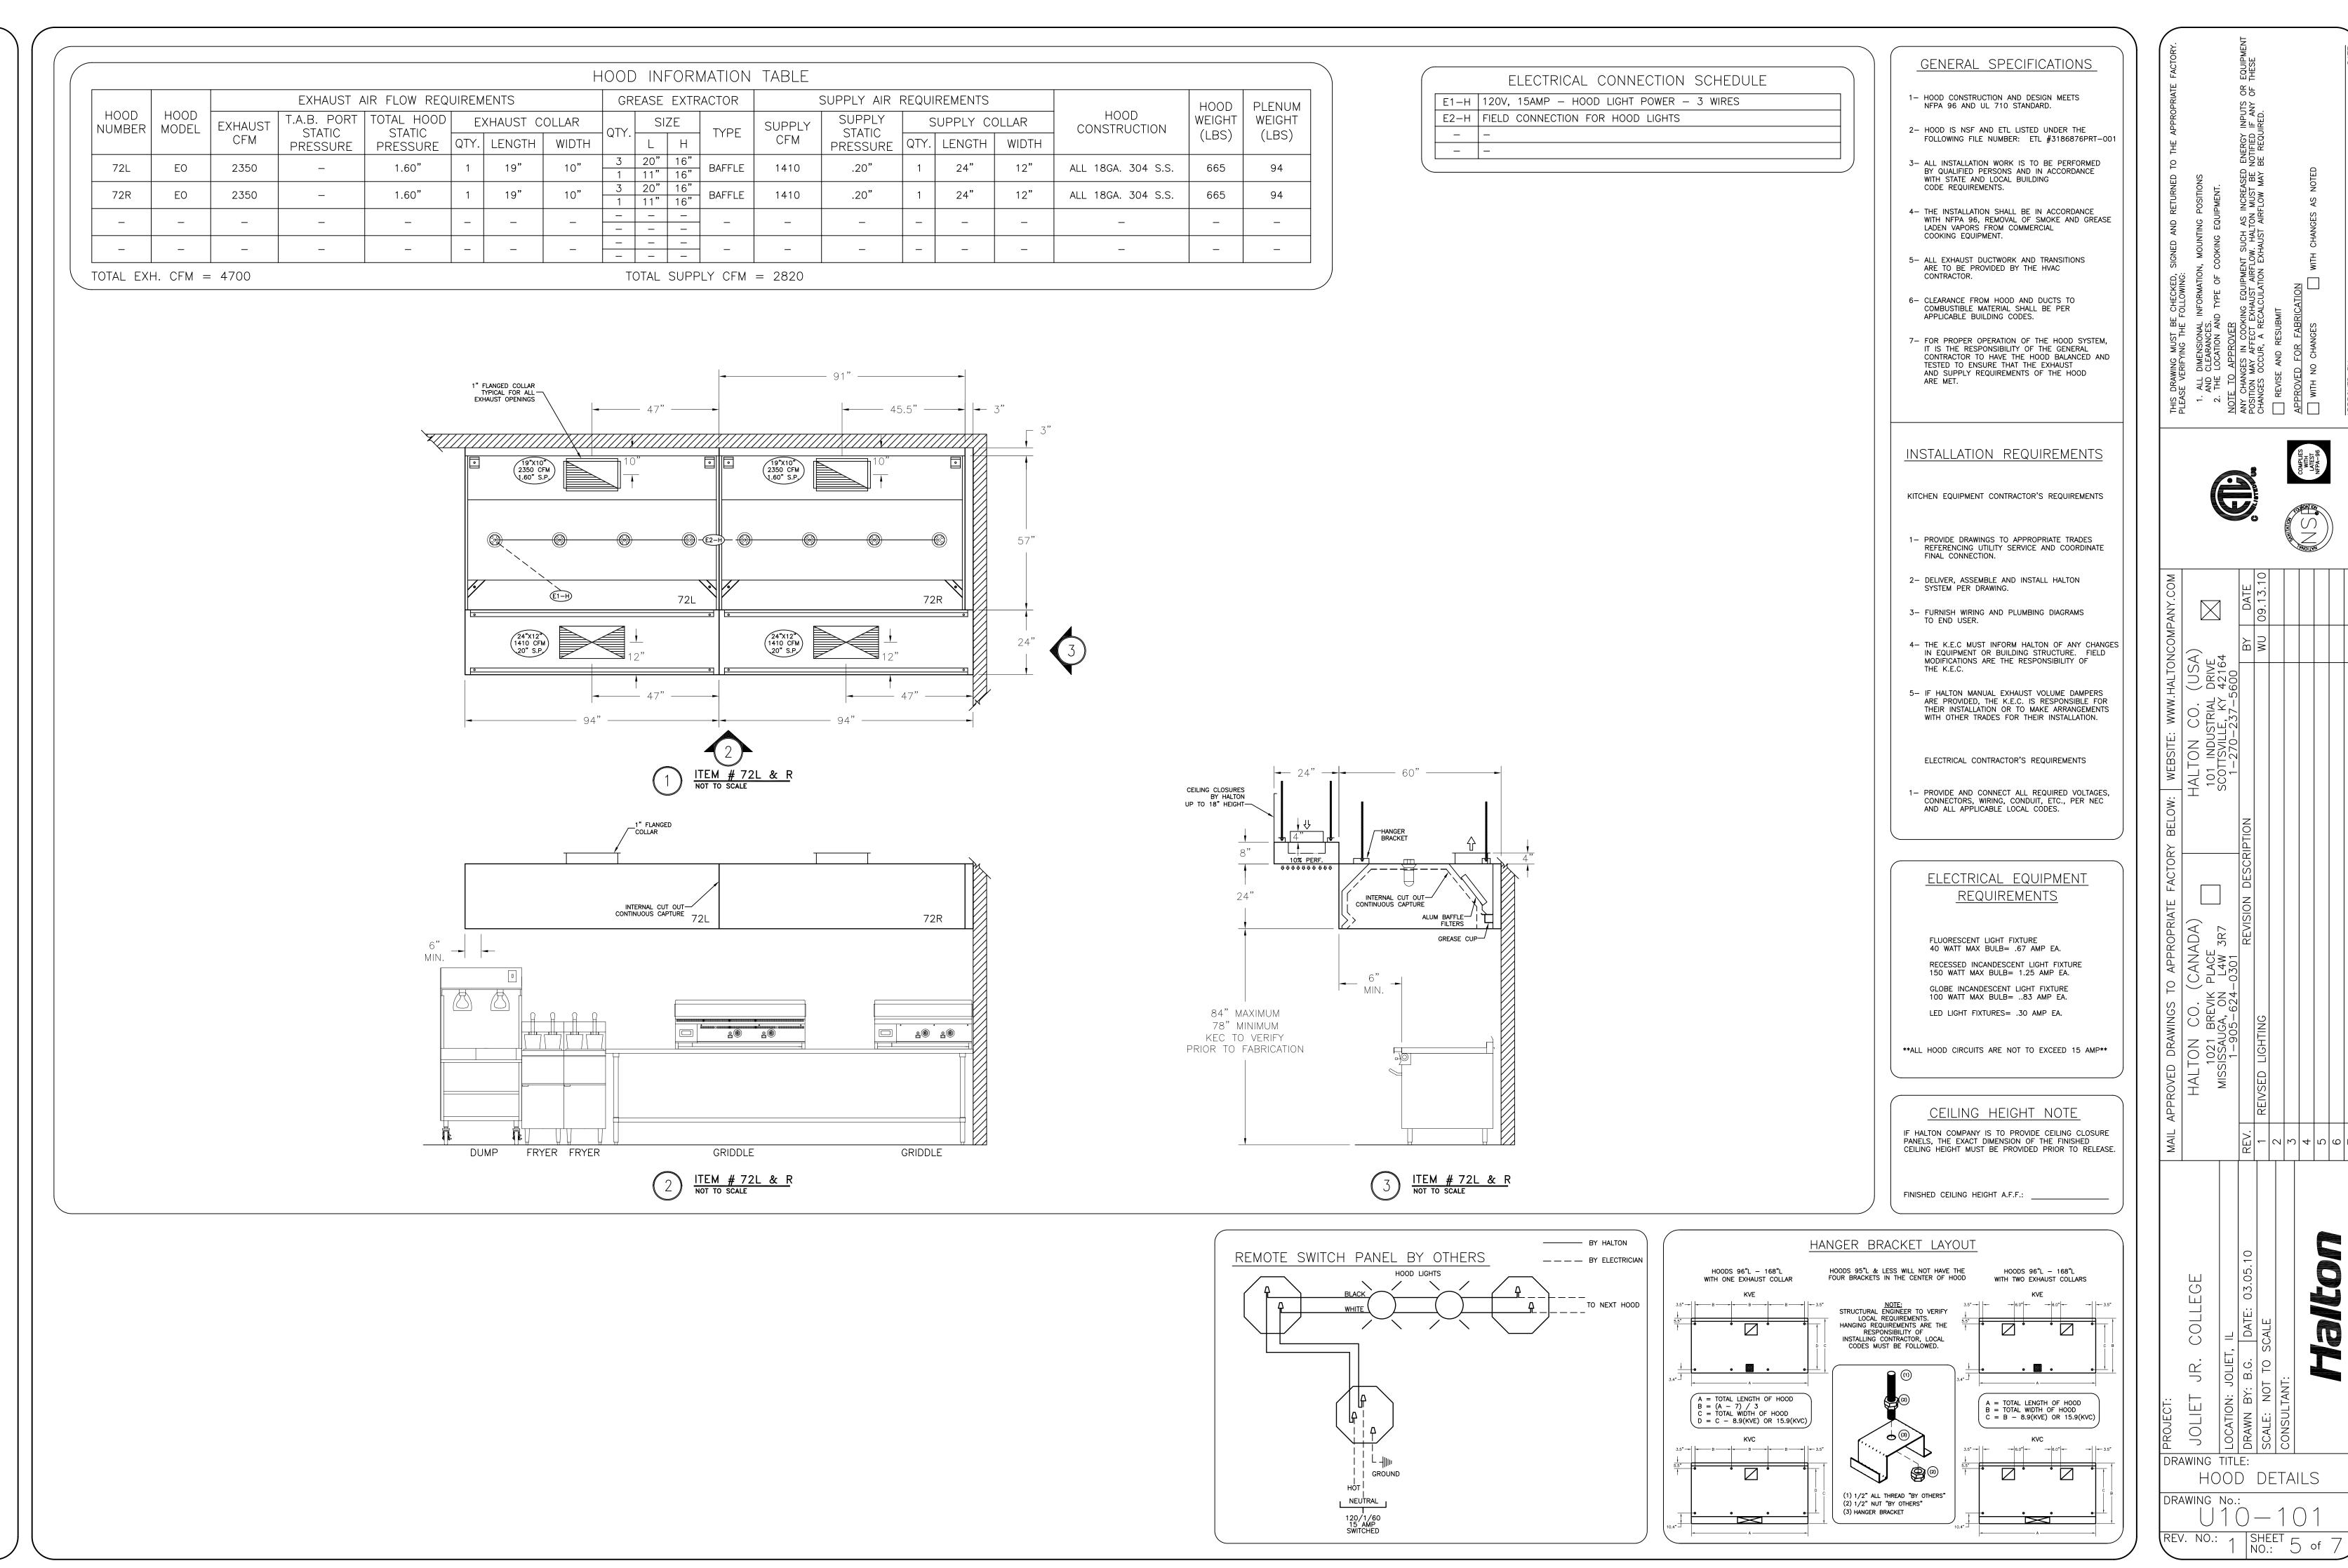


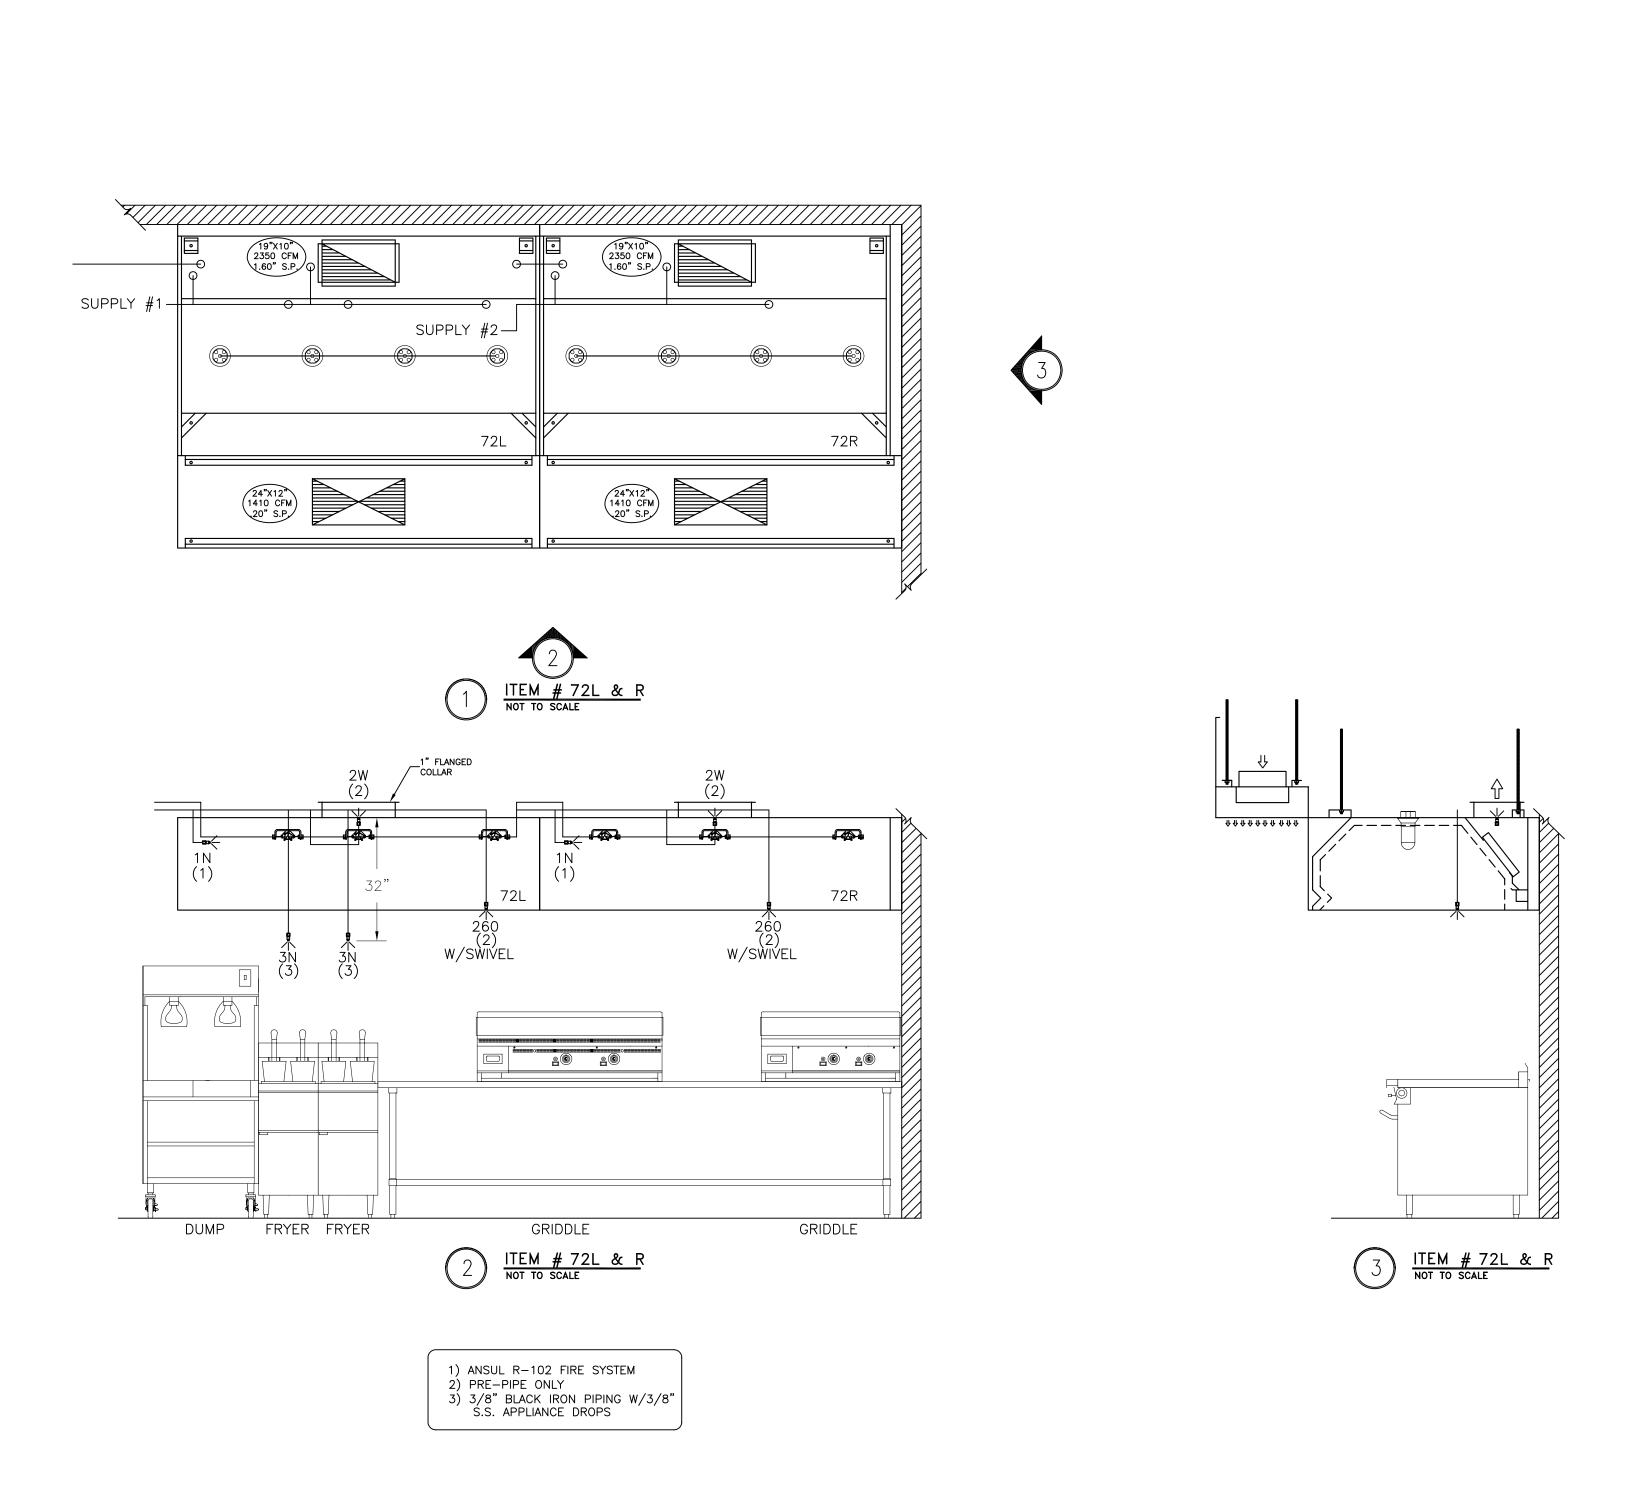

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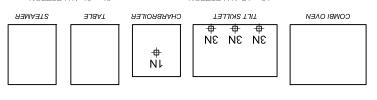


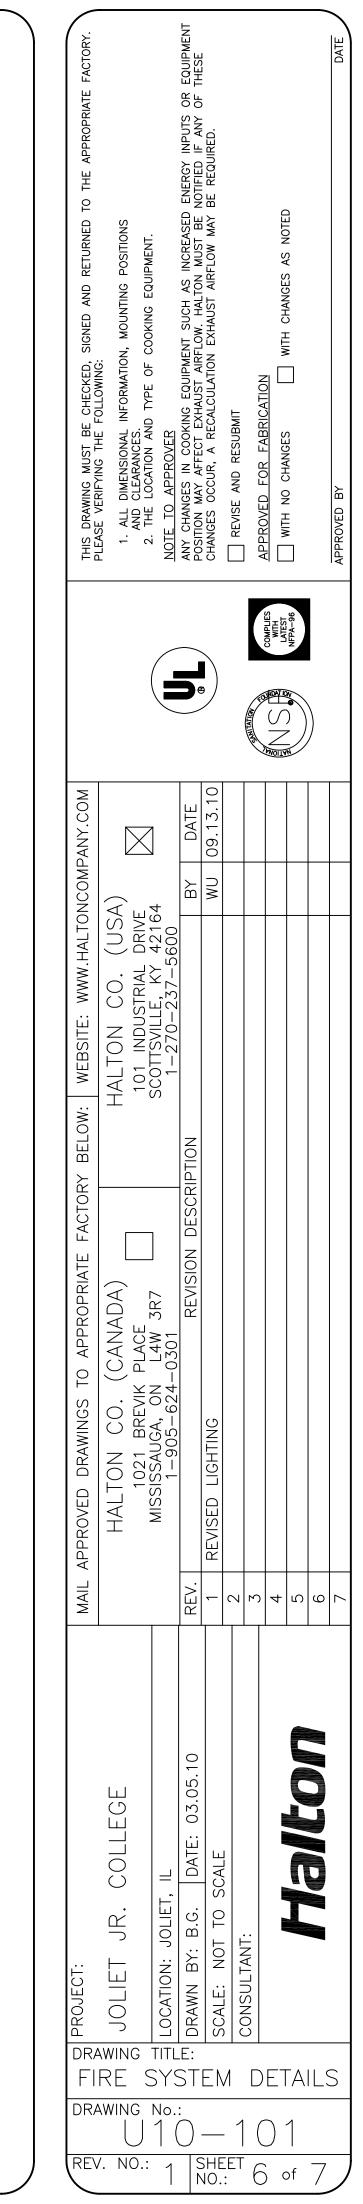


PLANVIEW

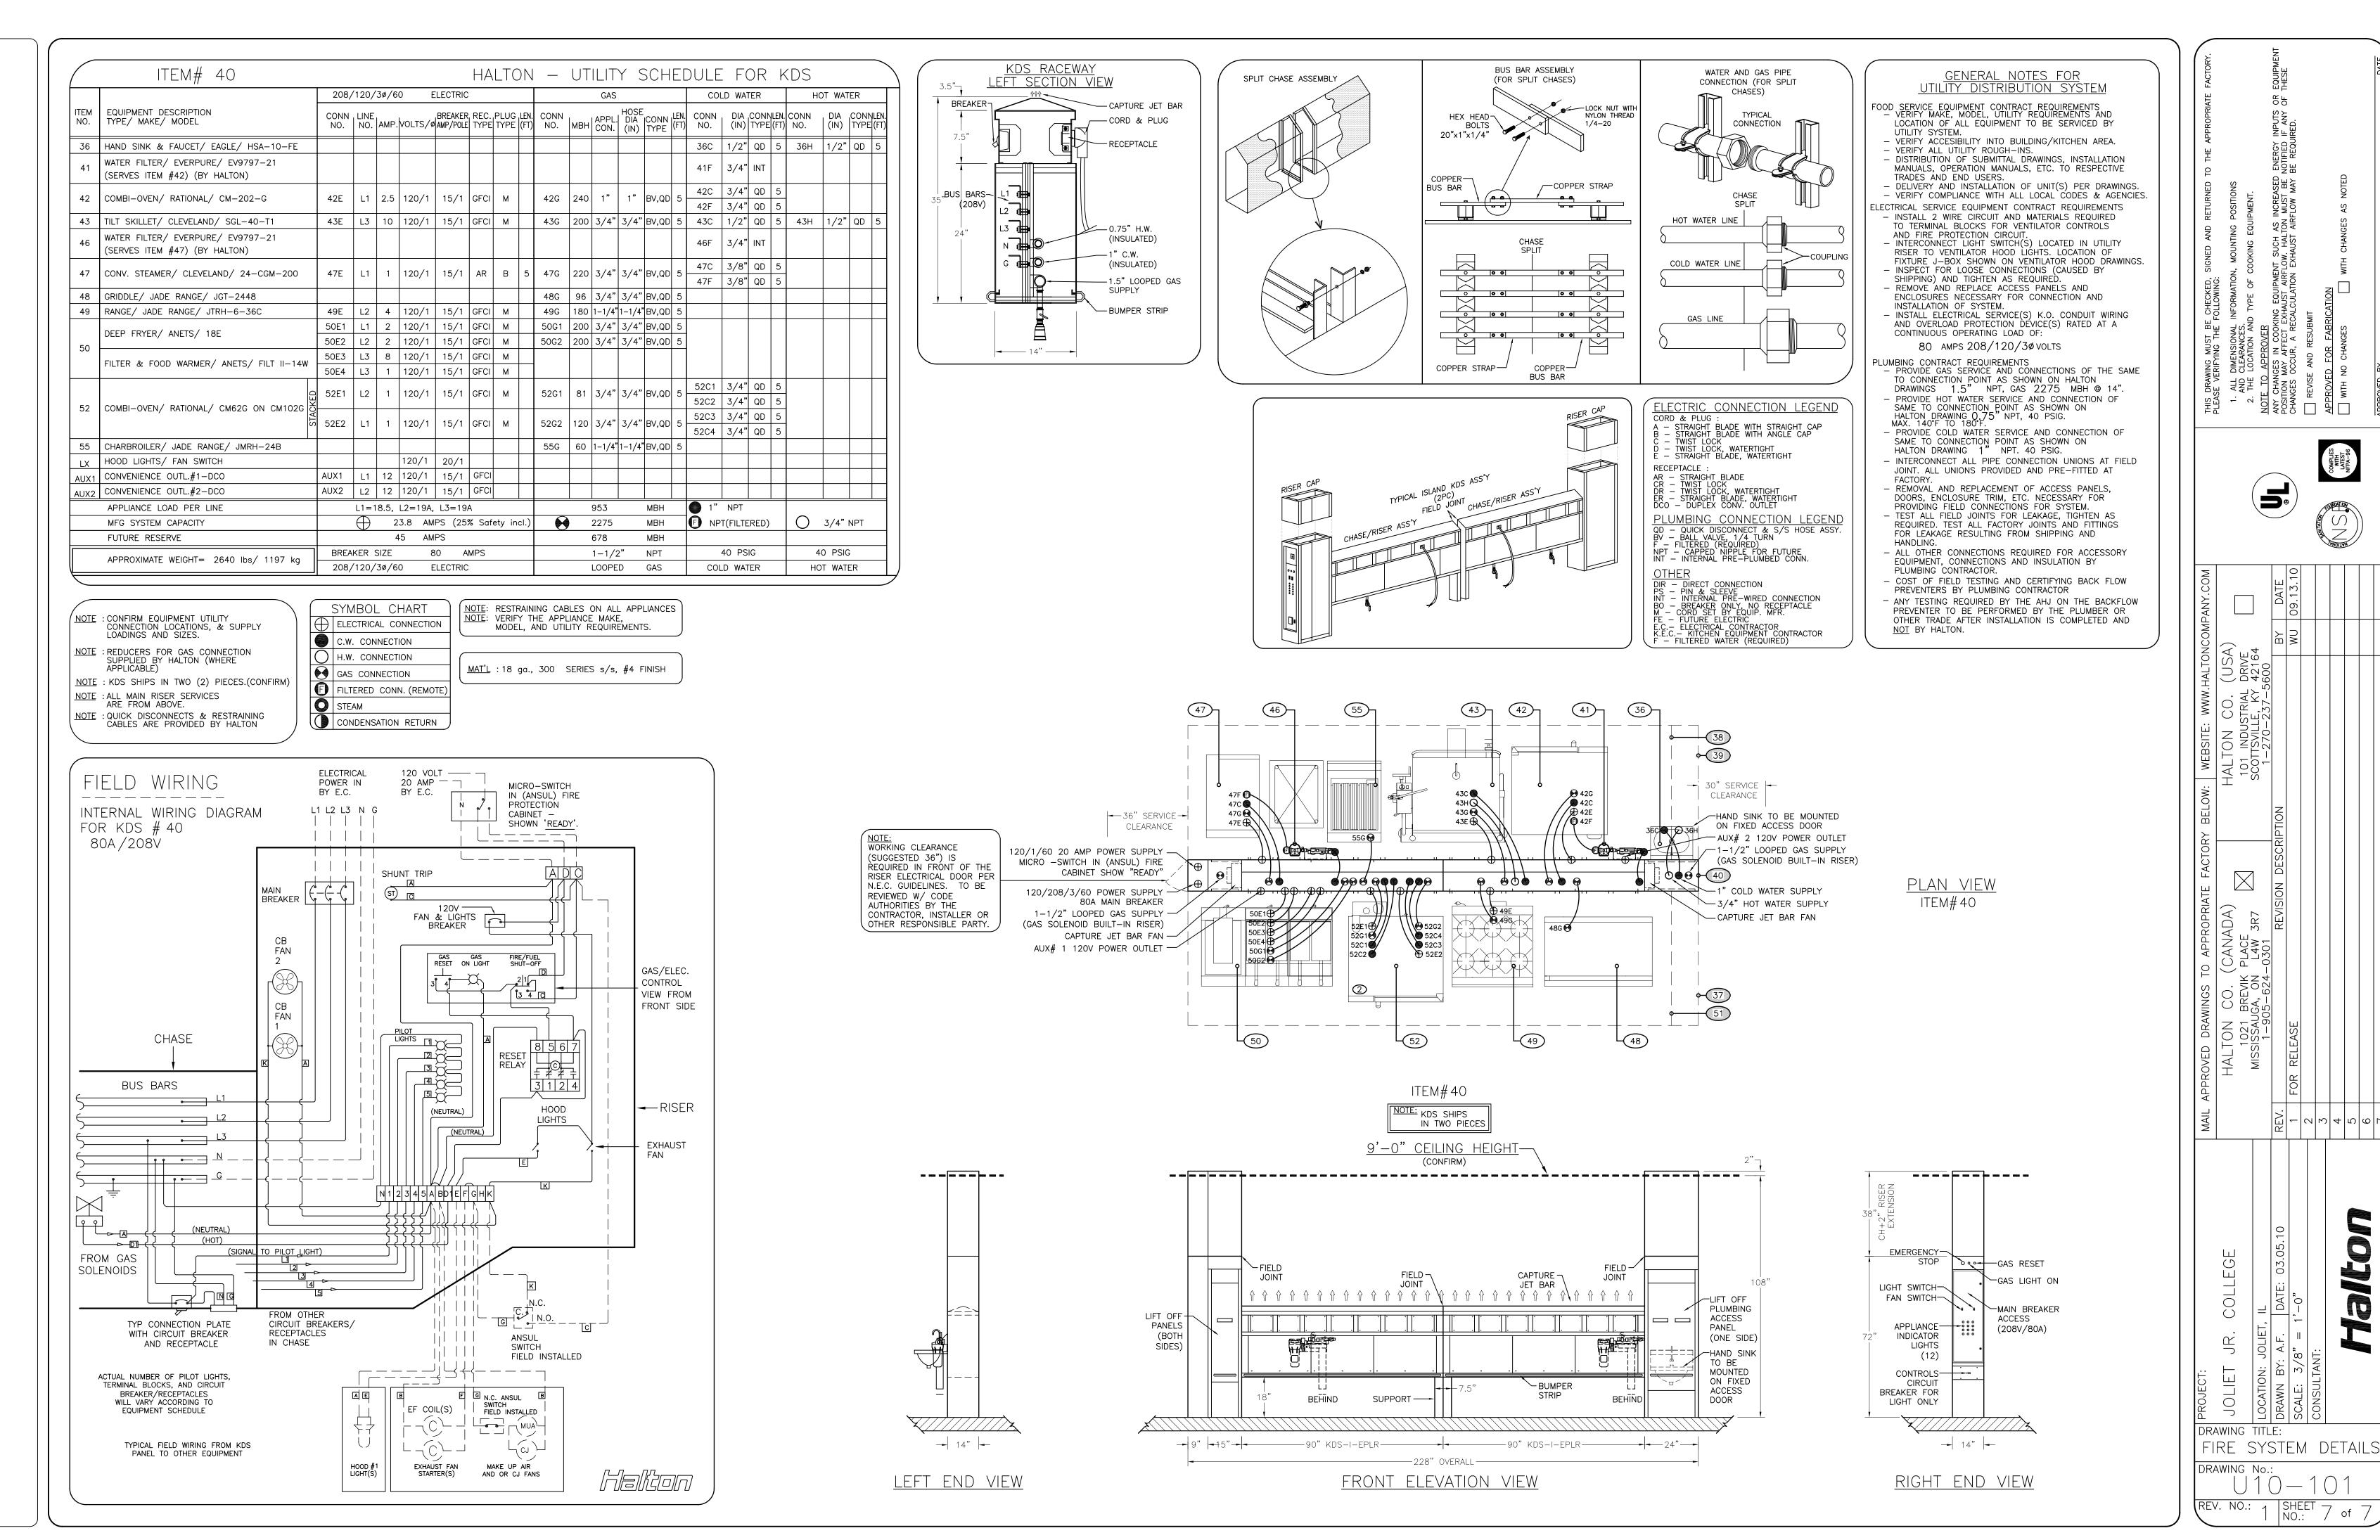
GAS RAD CHAR 1N NOZZLE 1 F.P. HAZARD AREA 24" X 36" CENTER LOCATED NOZZLE HT. 15" - 40"

TILT SKILLET 3N NOZZLE 3 F.P. HAZARD AREA 19 1/2" X 25 3/8" LOCATED AT FRONT EDGE; AIMED AT CENTER NOZZLE HT. 21" - 34"



FRYER 230 NOZZLE 2 F.P. HAZARD AREA 14" X 21" CENTER LOCATED W/ DRIP BOARD NOZZLE HT. 27" - 47"

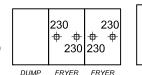

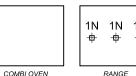

1N 1N 1N ι | 1Ν ф-1N GRIDDLE RANGE

INSTALLATION NOTES

THE R-102 RESTAURANT FIRE SUPPRESSION SYSTEM HAS BEEN TESTED AND IS LISTED BY UNDERWRITERS LABORATORIES, INC. AS A PRE-ENGINEERED SYSTEM,

THE R-102 SYSTEM REQUIRES 3/8" SCHEDULE 40 BLACK IRON, CHROME-PLATED, OR STAINLESS STEEL PIPE FITTINGS.

HOOD PENETRATIONS SHALL HAVE A LIQUID TIGHT CONTINUOUS EXTERNAL WELD. PENETRATIONS MAY ALSO BE SEALED BY OTHER LISTED DEVICES THAT ARE EVALUATED UNDER THE SAME CONDITIONS OF FIRE SEVERITY AS THE HOOD OR ENCLOSURE OF LISTED GREASE EXTRACTORS, AND WHOSE PRESENCE DOES NOT DETRACT FROM THE HOOD OR DUCT'S STRUCTURAL INTEGRITY.

THE PULL STATION WILL BE INSTALLED NOT LESS THAN 42" OR MORE THAN 48" ABOVE THE FLOOR. AT LEASE 10 FEET, BUT NO MORE THAN 20 FEET ON A MEANS OF EGRESS.

EXHAUST FANS IN THE VENTILATION SYSTEM SHOULD BE LEFT ON.

THE INSTALLED SYSTEM WILL CONFORM TO NFPA 17A. 96. UL300 LISTINGS, AND INTERNATIONAL BUILDING CODES.

THE INSTALLER SHALL CERTIFY TO THE AUTHORITY HAVING JURISDICTION THAT THE SYSTEM HAS BEEN INSTALLED IN ACCORDANCE WITH THE APPROVED PLANS AND THE MANUFACTURER'S LISTED INSTALLATION AND MAINTENANCE MANUAL

DRAWING DATE 03-18-10 **FLOWPOINTS**

GE

COLLE

JOLIET JUNIOR

1215 HOUBOLT ROAD JOLIET, IL 60431-8938

35

NOZZLE FLOW POINT SUMMARY CHART


TYPE OF NOZZLE	NUMBER OF NOZZLES	FLOWPOINTS PER NOZZLE	TOTAL FLOWPOINTS			
1/2N	0	1/2	0			
1100	0	1	0			
1F	0	1	0			
1N	10	1	10			
1W	0	1	0			
2W	4	2	8			
230	4	2	8			
245	0	2	0			
260	0	2	0			
290	0	2	0			
2120	0	2	0			
3N	3	3	9			
TOTA	L # OF NO	ZZLES:	21			
TOTA	TOTAL FLOW POINTS:					

THIS IS A FOUR TANK, 12 GALLON SYSTEM. SYSTEM HAS A MAXIMUM OF 11 FLOW POINT CAPACITY ON EACH 3 GALLON TANK. (4) 9' HOODS

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PHONE: 847-695-5990 • FAX: 847-695-FOXX (3)
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ONE COMPANY DOES IT ALL

RANGE 1N NOZZLE 1 F.P. HAZARD AREA 12" X 32" CENTER LOCATED NOZZLE HT. 30" - 40"

GRIDDLE 1N NOZZLE 1 F.P. HAZARD AREA 36" X 30" PERIMETER LOCATED NOZZLE HT. 35" - 40"

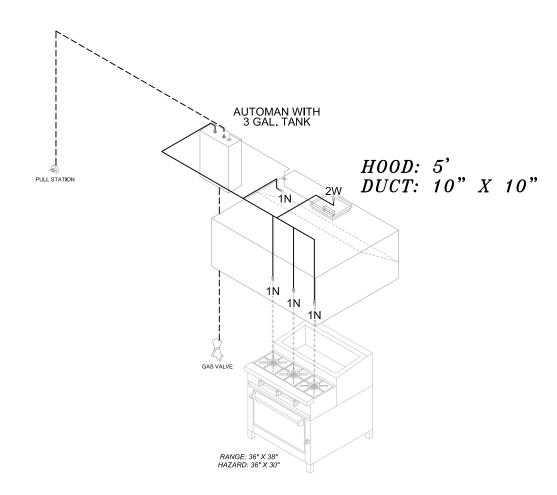

PLANVIEW

RANGE 1N NOZZLE 1 F.P. HAZARD AREA 12" X 32" CENTER LOCATED NOZZLE HT. 30" - 40"



INSTALLATION NOTES

THE R-102 RESTAURANT FIRE SUPPRESSION SYSTEM HAS BEEN TESTED AND IS LISTED BY UNDERWRITERS LABORATORIES, INC. AS A PRE-ENGINEERD SYSTEM, WHICH IS A POTASSIUM-BASED SOLUTION.

THE R-102 SYSTEM REQUIRES 3/8" SCHEDULE 40 BLACK IRON, CHROME-PLATED, OR STAINLESS STEEL PIPE FITTINGS.

HOOD PENETRATIONS SHALL HAVE A LIQUID TIGHT CONTINUOUS EXTERNAL WELD. PENETRATIONS MAY ALSO BE SEALED BY OTHER LISTED DEVICES THAT ARE EVALUATED UNDER THE SAME CONDITIONS OF FIRE SEVERITY AS THE HOOD OR ENCLOSURE OF LISTED GREASE EXTRACTORS, AND WHOSE PRESENCE DOES NOT DETRACT FROM THE HOOD OR DUCT'S STRUCTURAL INTEGRITY.

THE PULL STATION WILL BE INSTALLED NOT LESS THAN 42" OR MORE THAN 48" ABOVE THE FLOOR. AT LEASE 10 FEET, BUT NO MORE THAN 20 FEET ON A MEANS OF EGRESS.

EXHAUST FANS IN THE VENTILATION SYSTEM SHOULD BE LEFT ON.

THE INSTALLED SYSTEM WILL CONFORM TO NFPA 17A, 96, UL300 LISTINGS, AND INTERNATIONAL BUILDING CODES.

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DRAWI	NG DATE
021	18-10
U3- I	10-10

FLOWPOINTS

JOLIET JUNIOR COLLEGE

1215 HOUBOLT ROAD JOLIET, IL 60431-8938

6

NOZZLE FLOW POINT SUMMARY CHART

TYPE OF NOZZLE	NUMBER OF NOZZLES	FLOWPOINTS PER NOZZLE	TOTAL FLOWPOINTS
1/2N	0	1/2	0
1100	0	1	0
1F	0	1	0
1N	4	1	4
1W	0	1	0
2W	1	2	2
230	0	2	0
245	0	2	0
260	0	2	0
290	0	2	0
2120	0	2	0
3N	0	3	0
TOTAL # OF NOZZLES:			5
TOTAL FLOW POINTS:			6

THIS IS A ONE TANK, 3 GALLON SYSTEM.
SYSTEM HAS A MAXIMUM OF 11 FLOW POINT
CAPACITY ON EACH 3 GALLON TANK.
(1) 5' HOOD

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FIRE & SAFETY.

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03-19-10

FLOWPOINTS

GE

JOLIET JUNIOR COLLE

1215 HOUBOLT ROAD JOLIET, IL 60431-8938

15


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TYPE OF NOZZLE	NUMBER OF NOZZLES	FLOWPOINTS PER NOZZLE	TOTAL FLOWPOINTS
1/2N	0	1/2	0
1100	0	1	0
1F	0	1	0
1N	5	1	5
1W	0	1	0
2W	2	2	4
230	0	2	0
245	0	2	0
260	0	2	0
290	0	2	0
2120	0	2	0
3N	2	3	6
TOTAL # OF NOZZLES:			9
TOTAL FLOW POINTS:			15

THIS IS A TWO TANK, 6 GALLON SYSTEM.
SYSTEM HAS A MAXIMUM OF 11 FLOW POINT
CAPACITY ON EACH 3 GALLON TANK.
(2) 7' 10" HOODS

PLANVIEW

FRYER 3N NOZZLE 3 F.P. HAZARD AREA 19 1/2" X 25 3/8" CENTER LOCATED W/ DRIP BOARD NOZZLE HT. 21" - 34" GRIDDLE 1N NOZZLE 1 F.P. HAZARD AREA 36" X 30" PERIMETER LOCATED NOZZLE HT. 35" - 40"

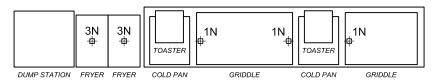

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