
Improvement Plans for

135th STREET

JOLIET JUNIOR COLLEGE - ROMEOVILLE CAMPUS

Village of Romeoville Will County, Illinois

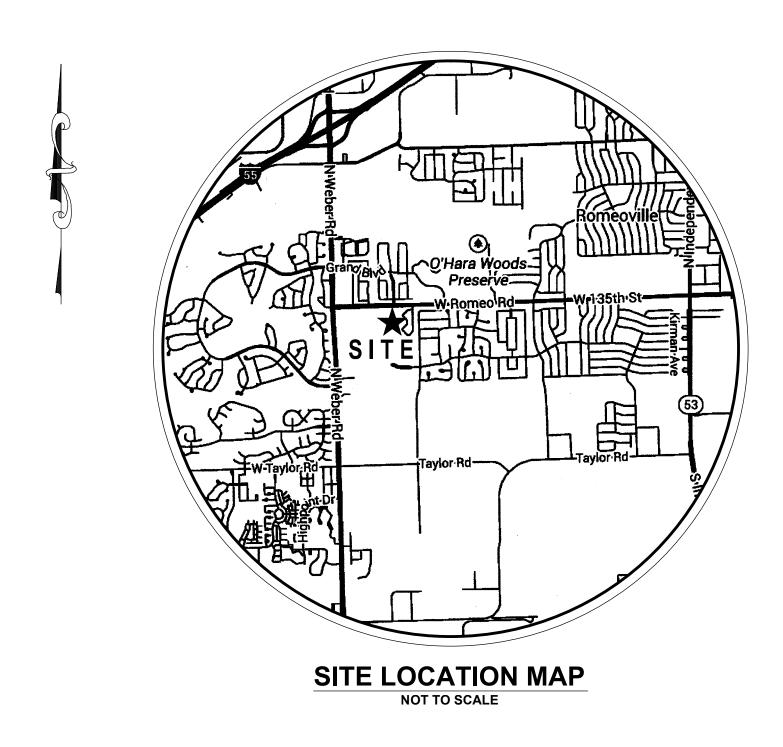

INDEX OF ENGINEERING SHEETS

SHEET No. DESCRIPTION

CO.O COVER SHEET

C1.O EXISTING CONDITIONS

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C3.0 PROPOSED SITE IMPROVEMENT PLAN

C4.0 PROPOSED SITE GEOMETRY PLAN

C5.0 EROSION CONTROL PLAN

C5.1 EROSION CONTROL NOTES AND DETAILS

C6.0 GENERAL NOTES AND CONSTRUCTION DETAILS (1 OF 2)

VILLAGE CONTACT INFORMATION:

MR. JONATHON ZABROCKI, P.E. c/o VILLAGE OF ROMEOVILLE 615 ANDERSON DRIVE ROMEOVILLE, ILLINOIS 60446 PHONE NO. (815) 866-1870

LAND SURVEYOR / ENGINEER:

RUETTIGER, TONELLI & ASSOCIATES, INC. 129 CAPISTA DRIVE SHOREWOOD, ILLINOIS 60404 Ph. (815) 744-6600

OWNER / DEVELOPER:

JOLIET JUNIOR COLLEGE 1125 WEST 135th STREET ROMEOVILLE, ILLINOIS 60446

COUNTY OF WILL BENCHMARK:

CONTROL MONUMENT (STATION 403) LOCATED ON THE SOUTH SIDE OF ROMEO ROAD AND ±0.25 MILES WEST OF ILLINOIS ROUTE 53.

ELEVATION = 628.26 (NAVD 88) FIELD VERIFY BENCHMARK.

SITE BENCHMARK #1:

BONNET BOLT OF FIRE HYDRANT LOCATED NEAR THE EASTERLY ENTRANCE OF EXISTING BUILDING AS NOTED ON PLAN.

ELEVATION = 672.38 (NAVD 88) FIELD VERIFY BENCHMARK.

COUNTY OF WILL)

STATE OF ILLINOIS)

I, JOSEPH P. HAMMER, HEREBY CERTIFY THAT ADEQUATE STORM WATER STORAGE AND DRAINAGE CAPACITY HAS BEEN PROVIDED FOR THIS DEVELOPMENT, SUCH THAT SURFACE WATER FROM THE DEVELOPMENT WILL NOT BE DIVERTED ONTO AND CAUSE DAMAGE TO ADJACENT PROPERTY FOR STORMS UP TO AND INCLUDING THE ONE HUNDRED (100) YEAR EVENT, AND THAT THE DESIGN PLANS ARE IN COMPLIANCE WITH ALL APPLICABLE STATE, COUNTY AND VILLAGE ORDINANCES.

I, JOSEPH P. HAMMER, A REGISTERED PROFESSIONAL ENGINEER IN THE STATE OF ILLINOIS, HEREBY CERTIFY THAT THE EROSION CONTROL PLAN ON SHEET 28 HAS BEEN PREPARED UNDER MY SUPERVISION BY RUETTIGER, TONELLI & ASSOCIATES, INC., AND COMPLIES WITH THE URBAN SOIL EROSION CONTROL & STANDARDS IN ILLINOIS MANUAL (LATEST EDITION) AND GENERALLY RECOGNIZED METHODS IN USE IN THE AREA.

I, JOSEPH P. HAMMER, A REGISTERED PROFESSIONAL ENGINEER IN THE STATE OF ILLINOIS, HEREBY CERTIFY THAT THESE IMPROVEMENT PLANS HAVE BEEN PREPARED UNDER MY SUPERVISION BY RUETTIGER, TONELLI & ASSOCIATES, INC., ILLINOIS PROFESSIONAL DESIGN FIRM No. 184-001251.

DATED THIS_____DAY OF_____.

JOSEPH P. HAMMER IL P.E. No. 062-053186 (EXPIRES 11-30-2017)
TO ENSURE AUTHENTICITY OF THIS DRAWING, IT MUST BEAR THE EMBOSSED SEAL OF THE DESIGN FIRM OR PROFESSIONAL LICENSEE WHO PREPARED THIS DRAWING.

Coll
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You Dig

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ONE-CALL SYSTEM

CONTACT J.U.L.I.E. at 811 or 800-892-0123
48 Hours (2 Working Days) BEFORE YOU DIG.
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R E V I S I O N S							
DATE	DESCRIPTION	BY	No.	DATE	DESCRIPTION	BY	
3-10-2016	RELEASED FOR REVIEW	R.P.					PROJECT No.: 20
3-18-2016	REVISED PER REVIEW	R.P.					DATE: 3-08-2016
4-14-2016	REVISED PER VILLAGE REVIEW	R.P.					FIELD BOOK: JJC
							TIEED BOOK. 990
							DRAWN BY: R.P.
							CHECKED BY: J.H



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Surveyors • Engineers • Planners • Landscape Architects • G.I.S. Consultants

129 CAPISTA DRIVE - SHOREWOOD, ILLINOIS 60404
PH. (815) 744-6600 FAX (815) 744-0101
website: www.ruettigertonelli.com

135th STREET IMPROVEMENTS

JOLIET JUNIOR COLLEGE
ROMEOVILLE CAMPUS
1125 WEST 135th STREET
ROMEOVILLE, ILLINOIS 60446

DRAWING TITLE:

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MR. JONATHON ZABROCKI, P.E.

c/o VILLAGE OF ROMEOVILLE

ROMEOVILLE, ILLINOIS 60446

PHONE: (815) 866-1870

615 ANDERSON DRIVE


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COVER SHEET

DRAWING No.
315-0053-C3
SCALE:

SHEET C0.0

AS NOTED

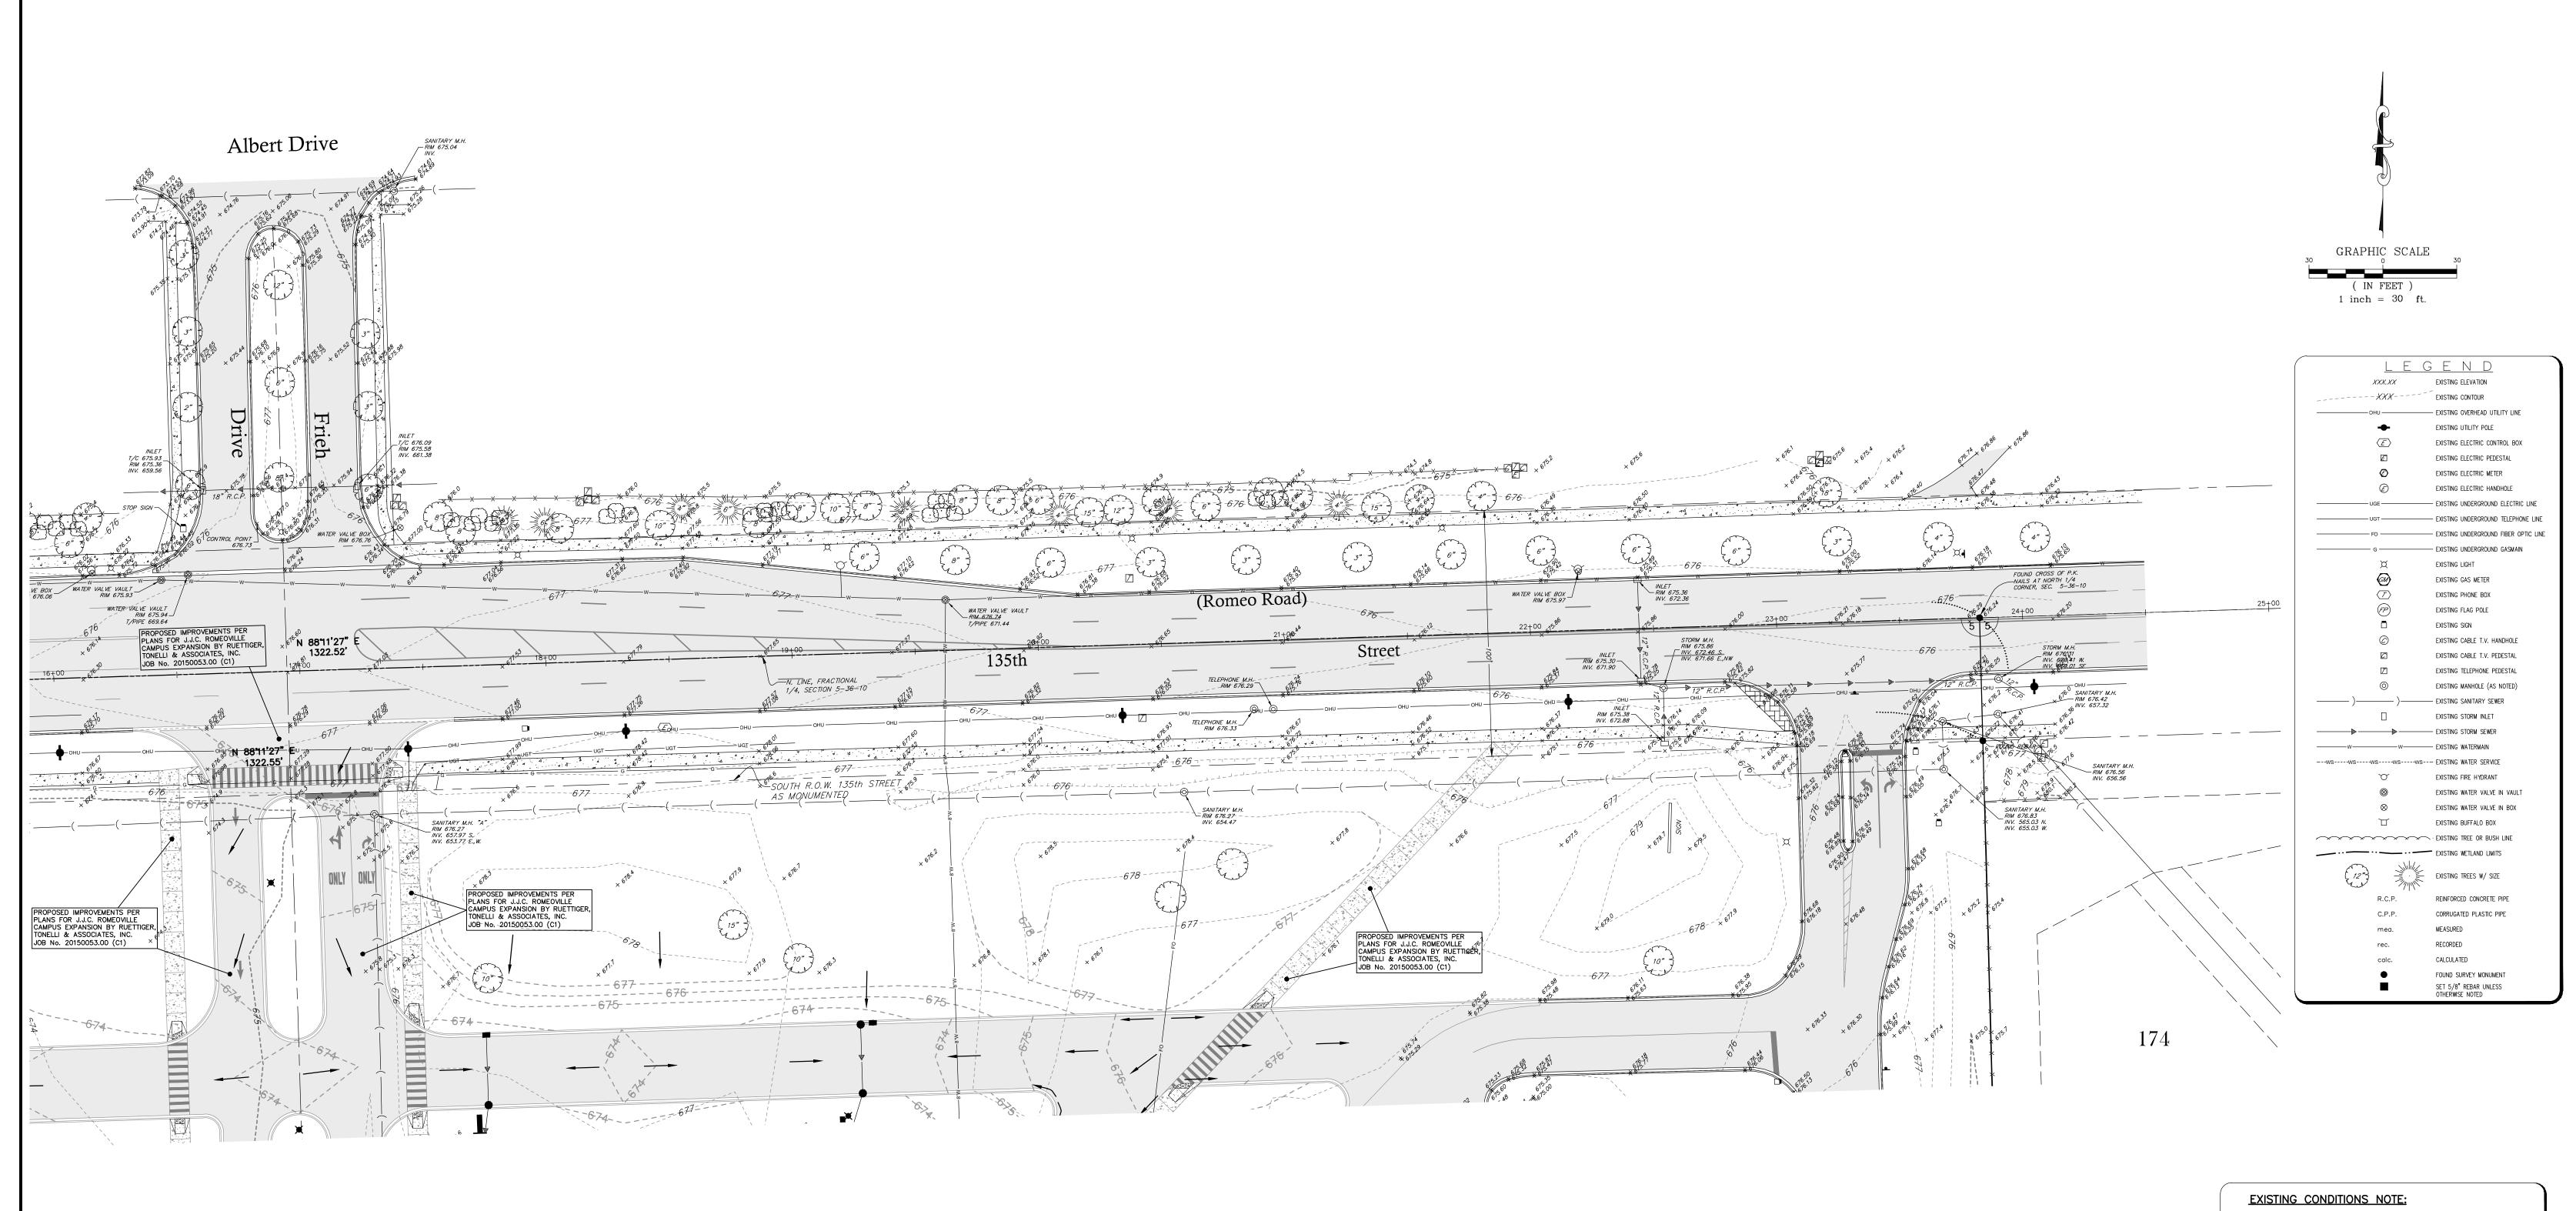

1.) EXISTING UTILITIES DEPICTED HEREON ARE BASED ON FIELD LOCATIONS OF J.U.L.I.E. MARKINGS, ABOVE GROUND EVIDENCE AND PROVIDED COMPANY UTILITY MAPS AS NOTED AT THE TIME OF THIS SURVEY. CONTACT J.U.L.I.E. PRIOR TO ANY CONSTRUCTION. EXISTING UTILITIES ENCOUNTERED DURING CONSTRUCTION ARE TO BE PROTECTED, RELOCATED OR REMOVED BASED ON MUNICIPAL AND UTILITY COMPANY GUIDELINES. COORDINATE WITH APPROPRIATE GOVERNING ENTITIES.



COUNTY OF WILL BENCHMARK:

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								DRAWN BY: R.P.
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135th STREET IMPROVEMENTS


JOLIET JUNIOR COLLEGE ROMEOVILLE CAMPUS 1125 WEST 135th STREET **ROMEOVILLE, ILLINOIS 60446**

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ENGINEERING DEPARTMENT SHEET C1.0





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DRAWN BY: R.P.
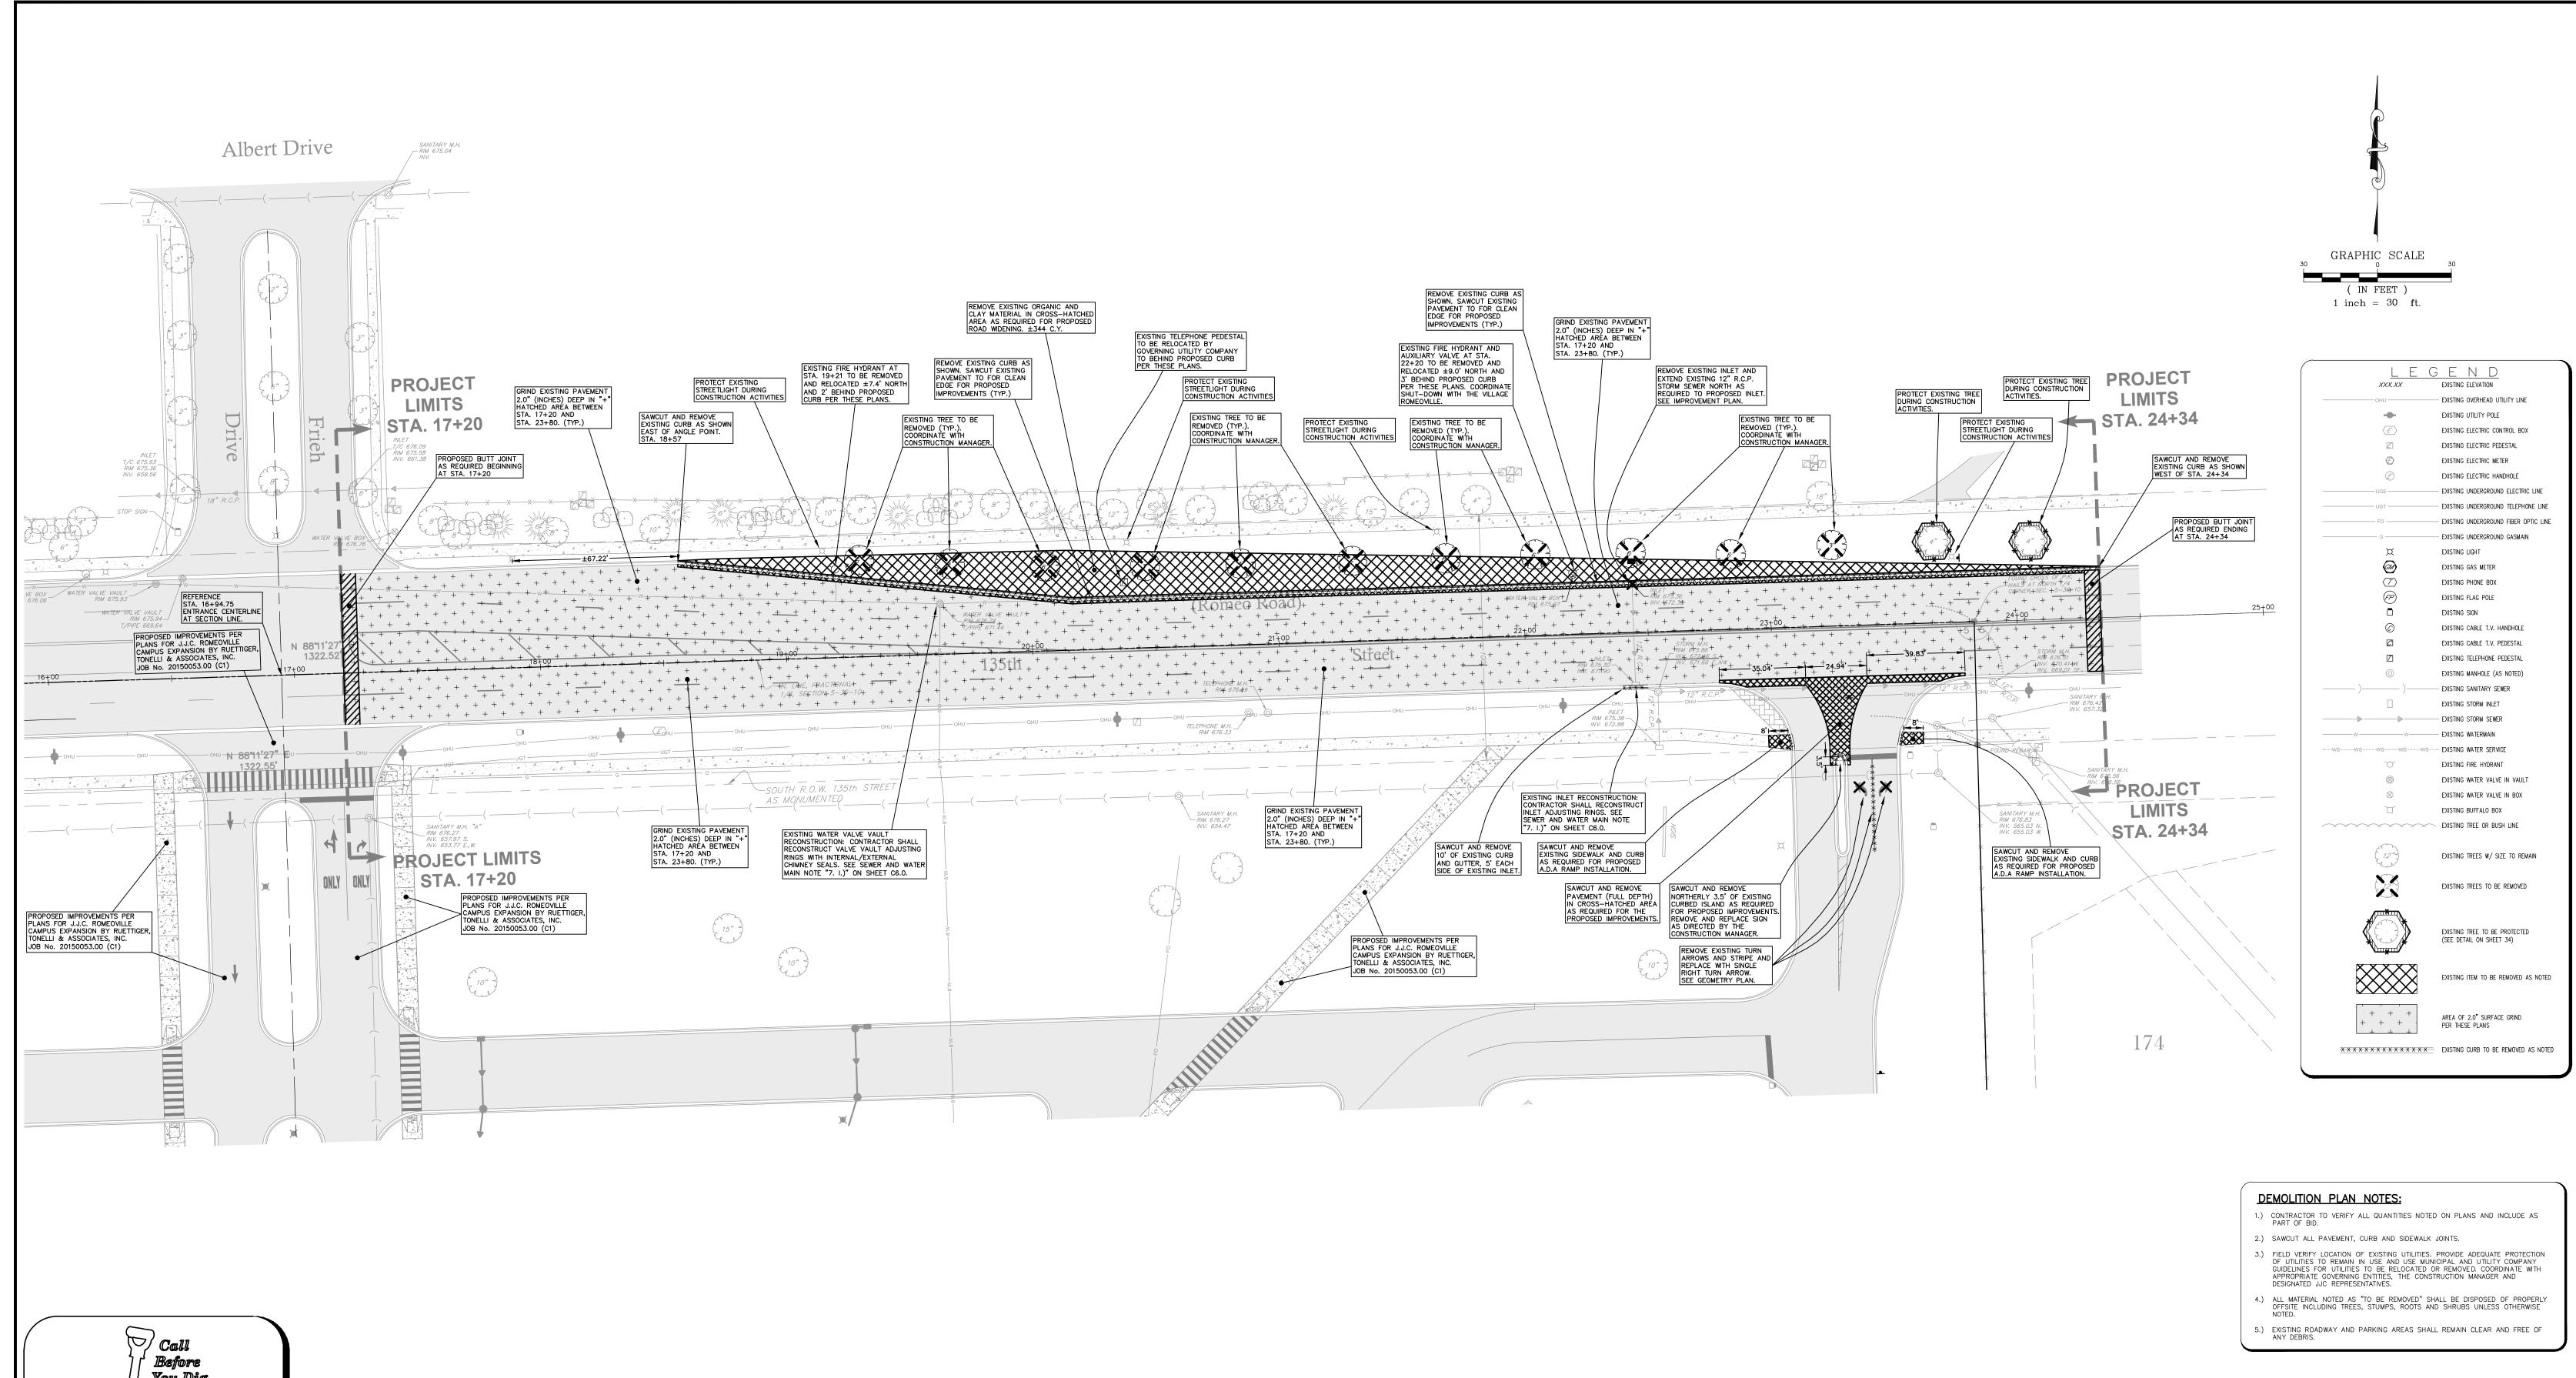
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JOLIET JUNIOR COLLEGE ROMEOVILLE CAMPUS 1125 WEST 135th STREET


ROMEOVILLE, ILLINOIS 60446

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ENGINEERING DEPARTMENT SHEET

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135th STREET IMPROVEMENTS

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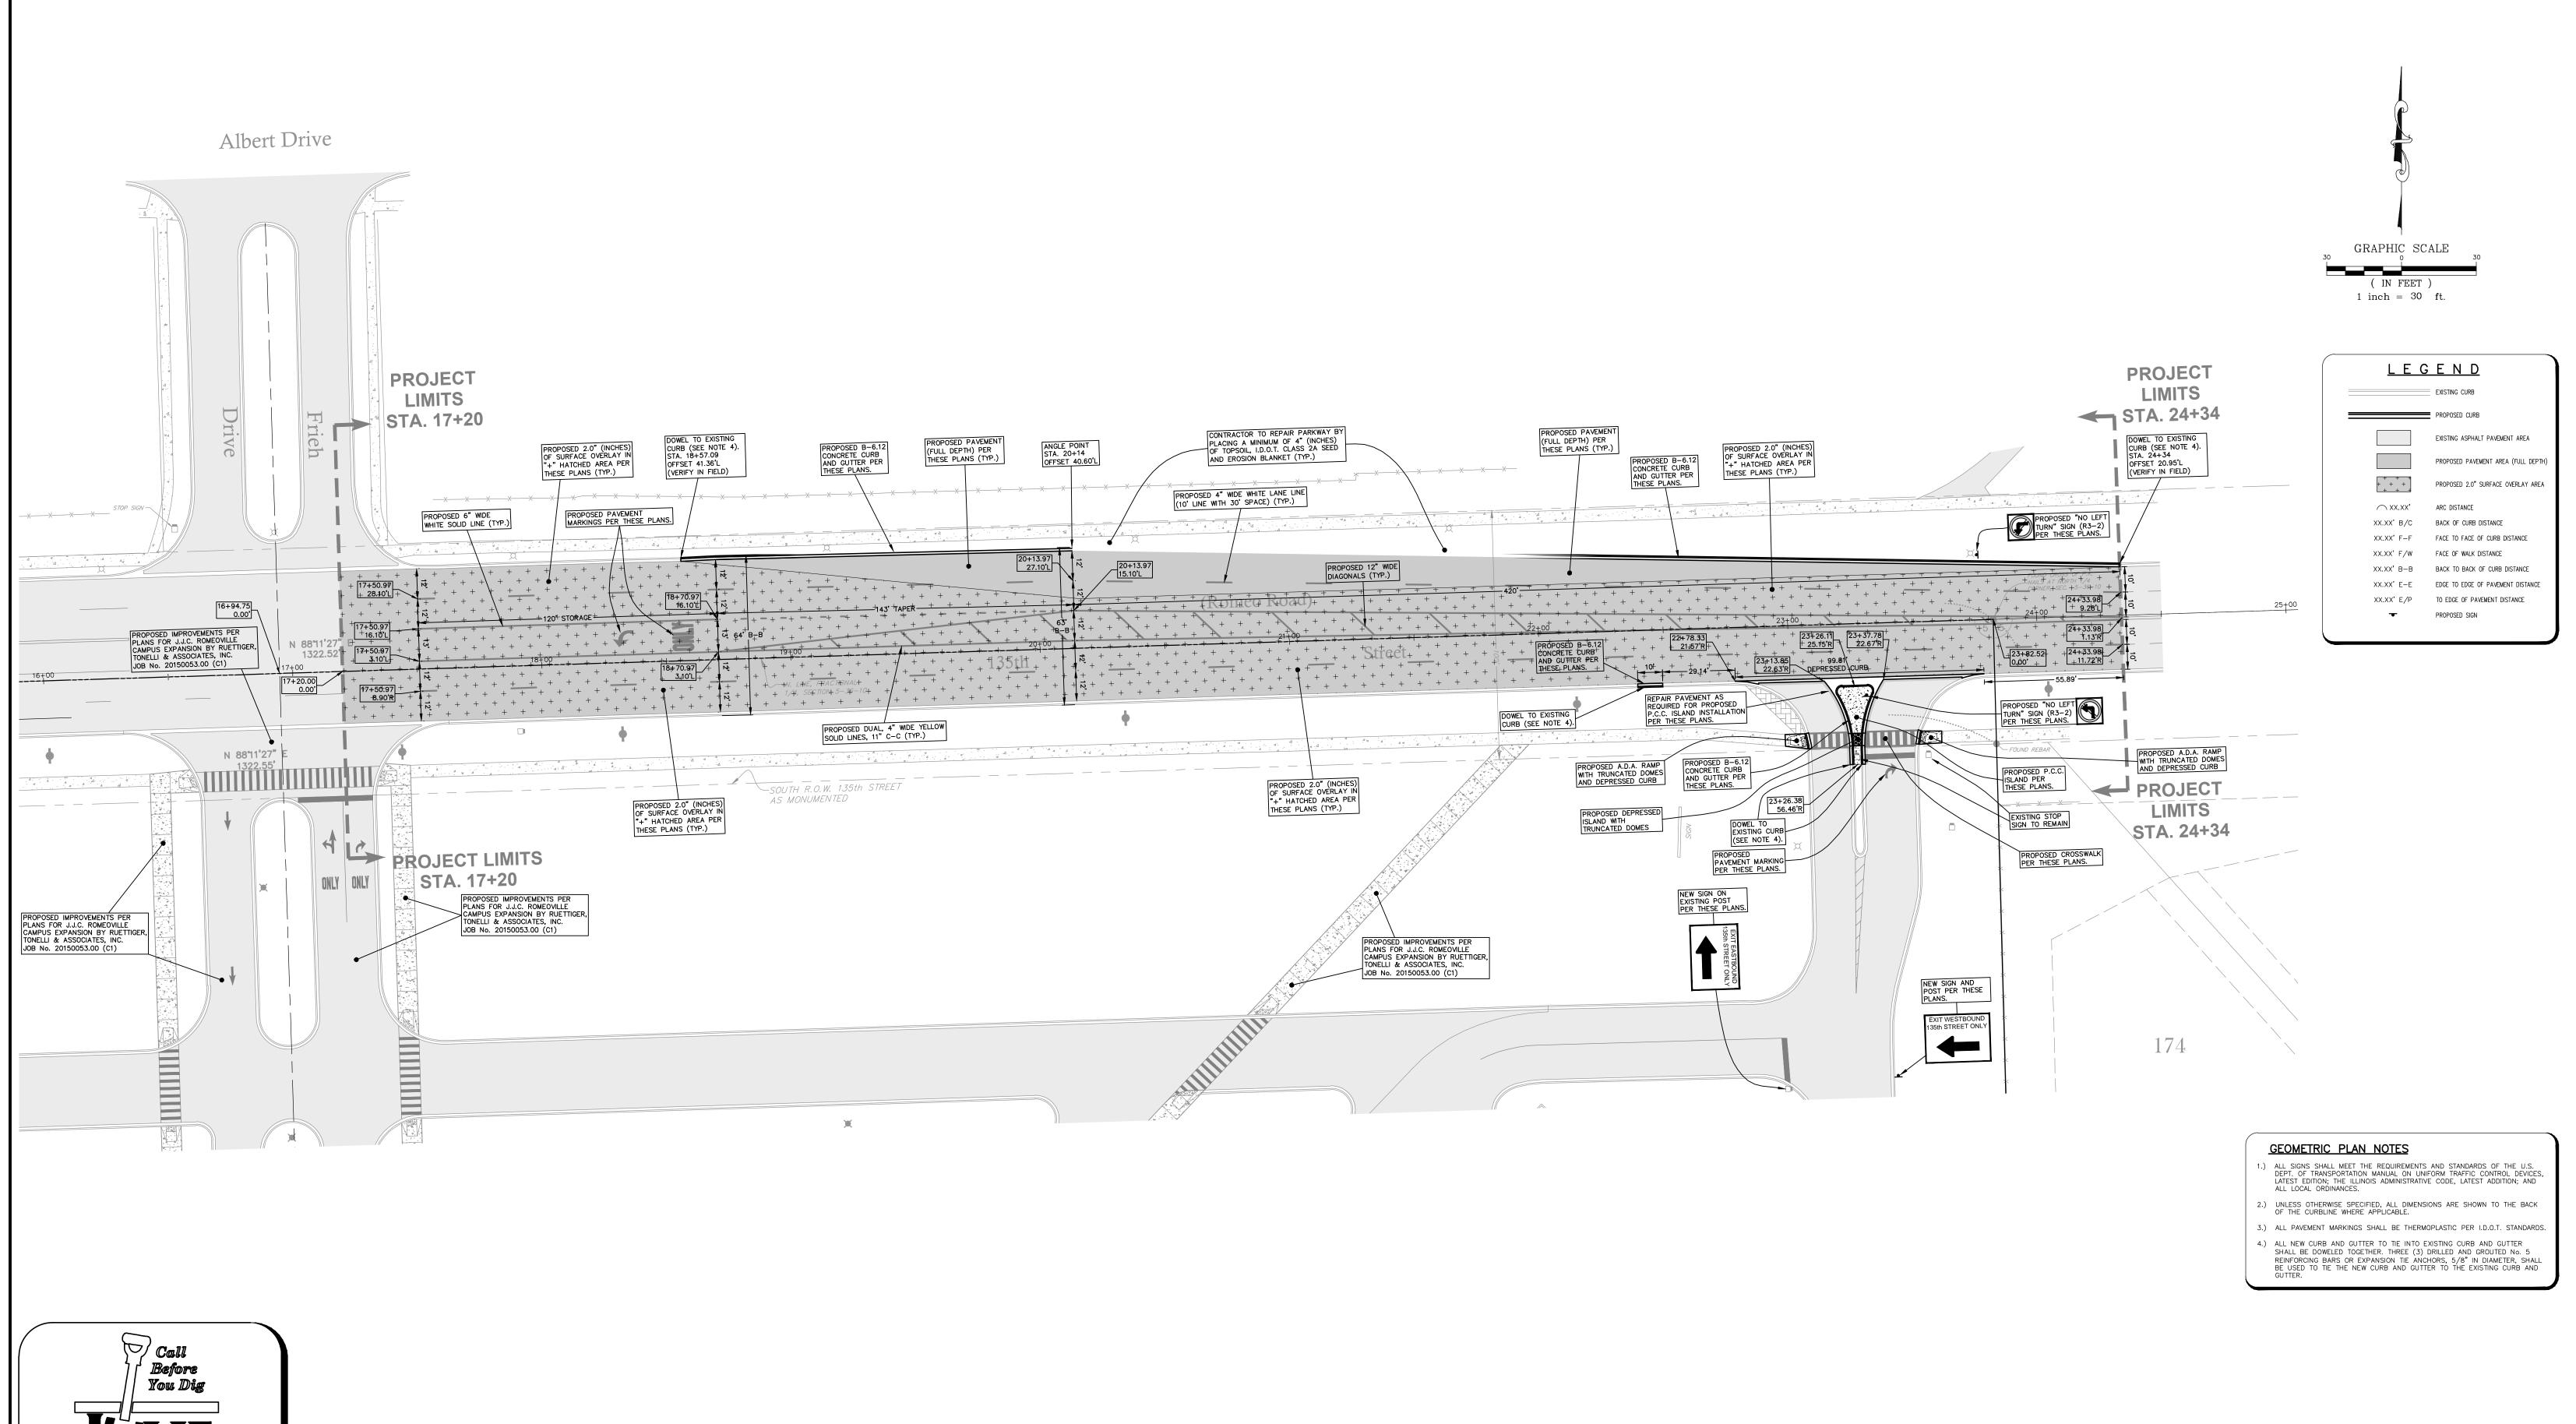
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JOLIET JUNIOR COLLEGE ROMEOVILLE CAMPUS 1125 WEST 135th STREET **ROMEOVILLE, ILLINOIS 60446** DRAWING TITLE:

PROPOSED SITE **IMPROVEMENT PLAN**

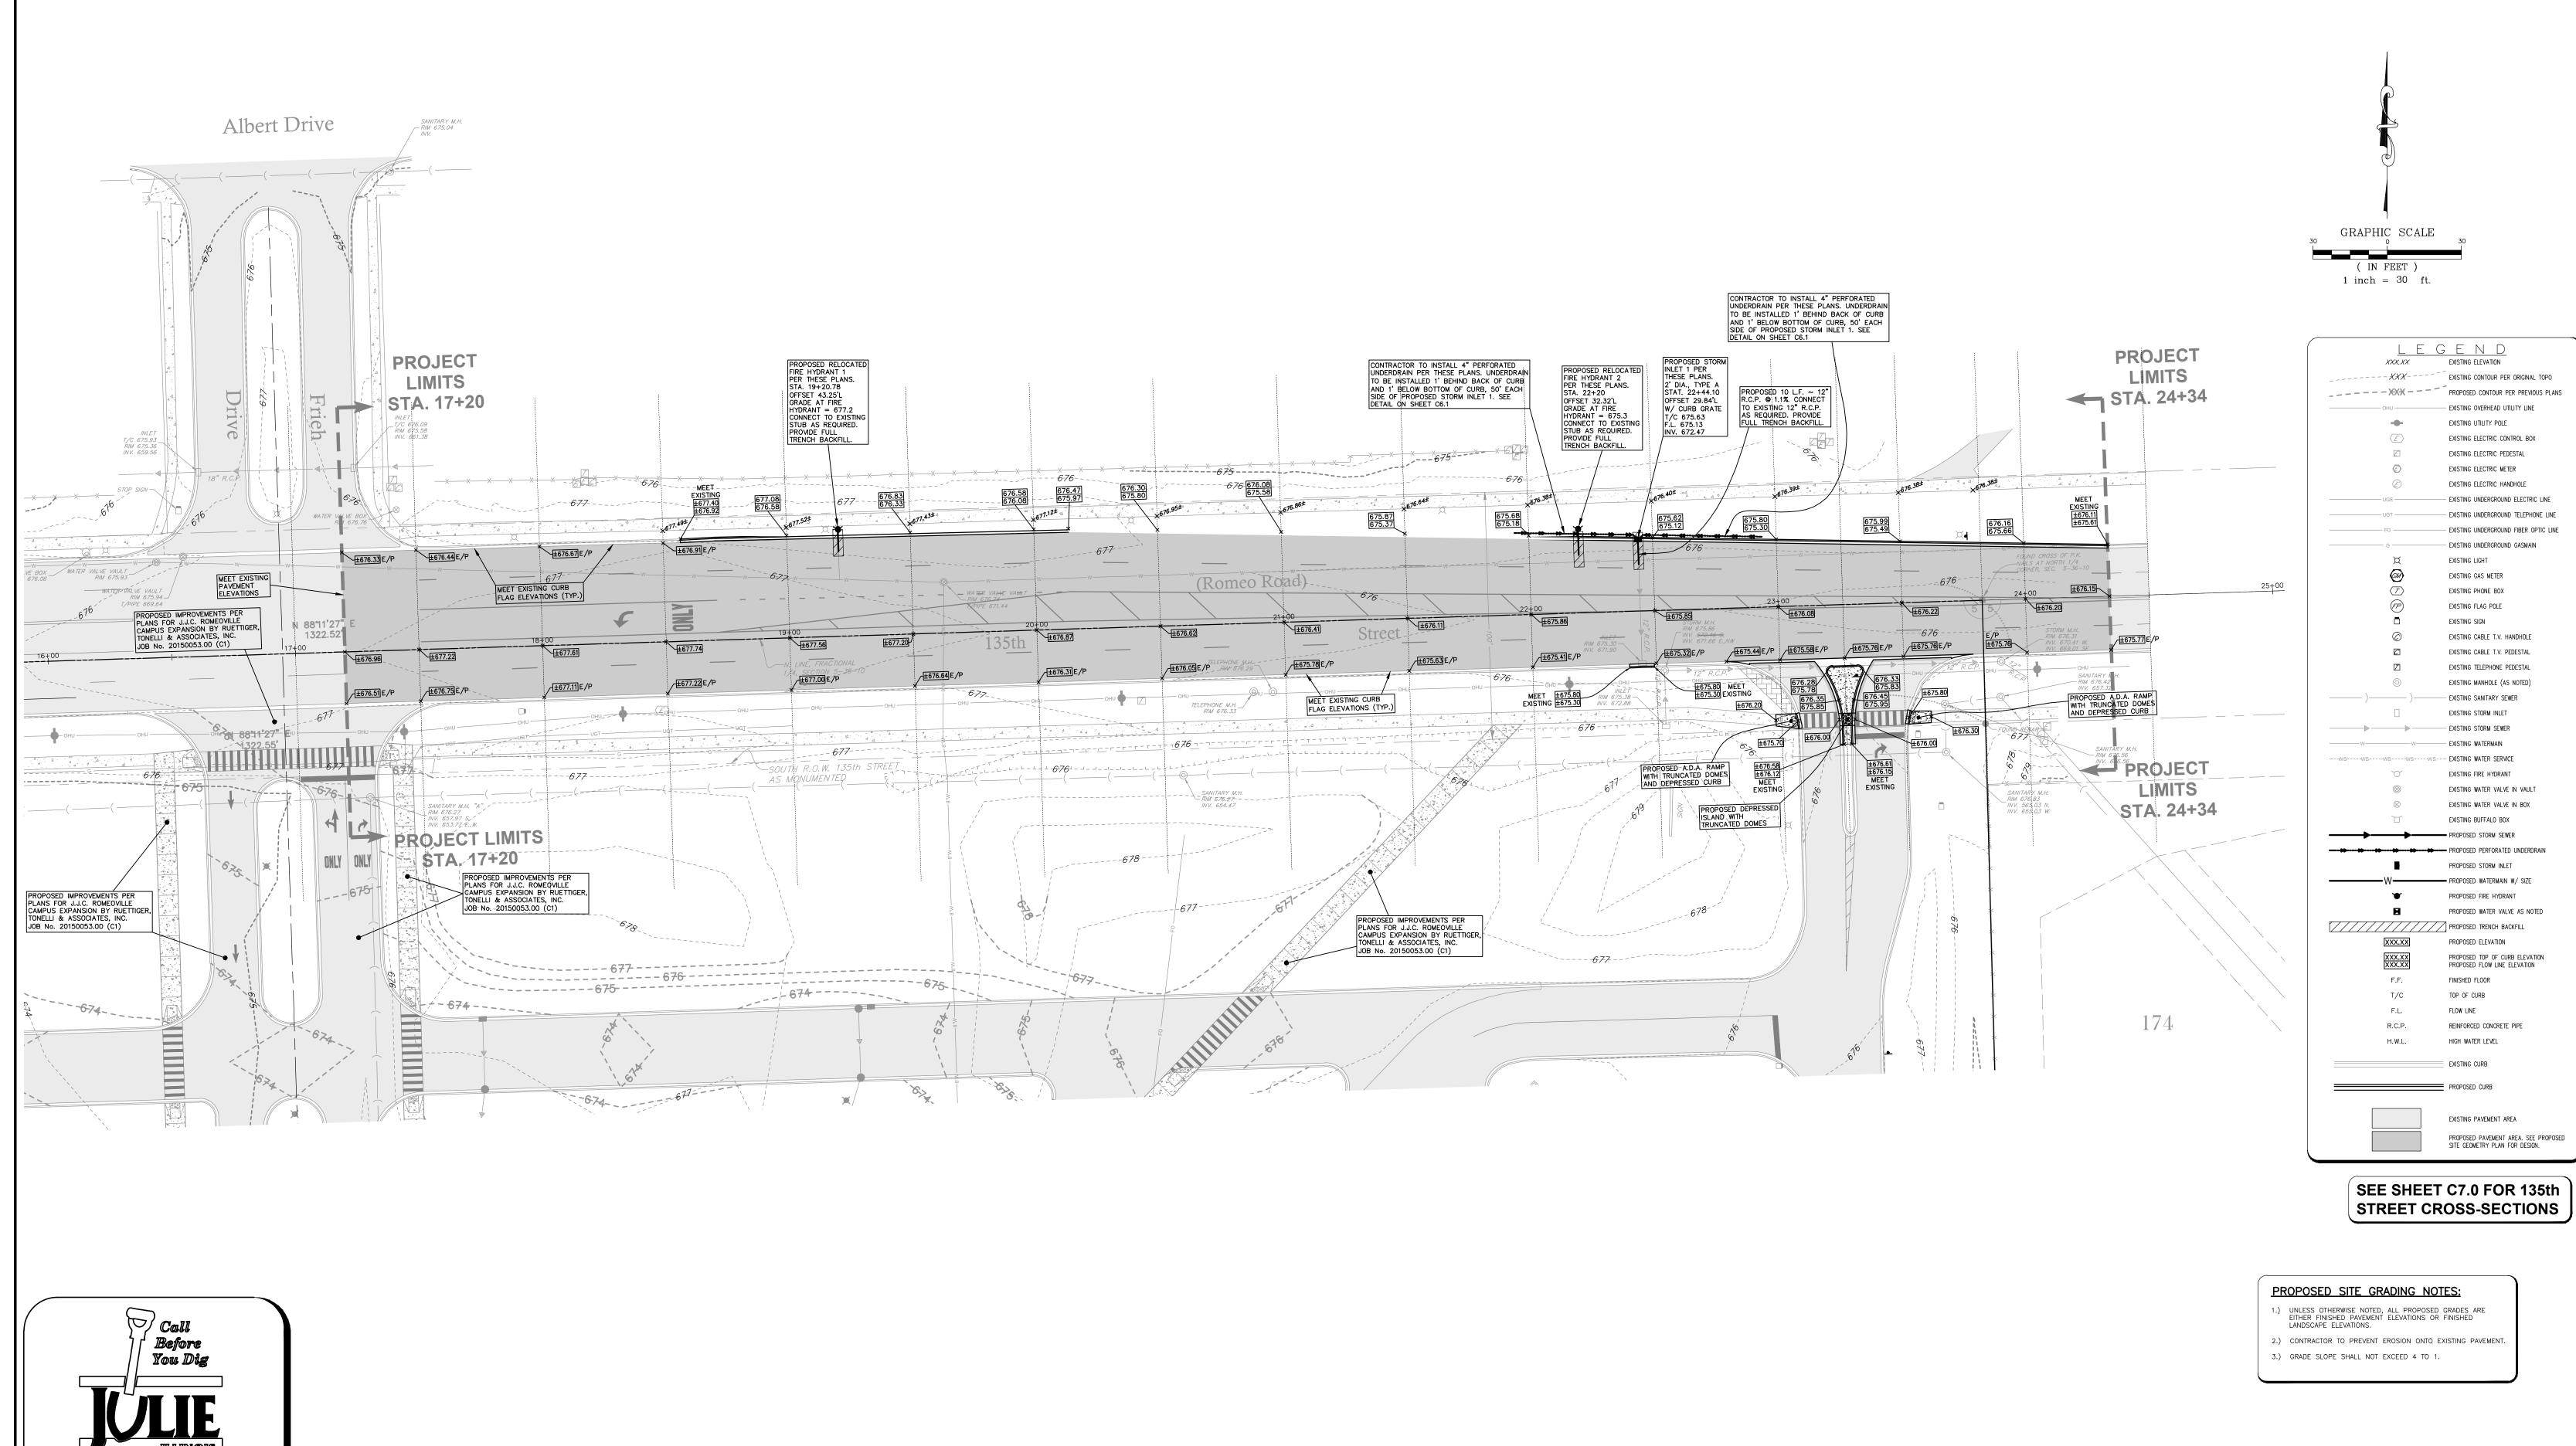DRAWI	NG No.
	315-0053-C3
SCALE:	

AS NOTED ENGINEERING DEPARTMENT SHEET C3.0





COUNTY OF WILL BENCHMARK:

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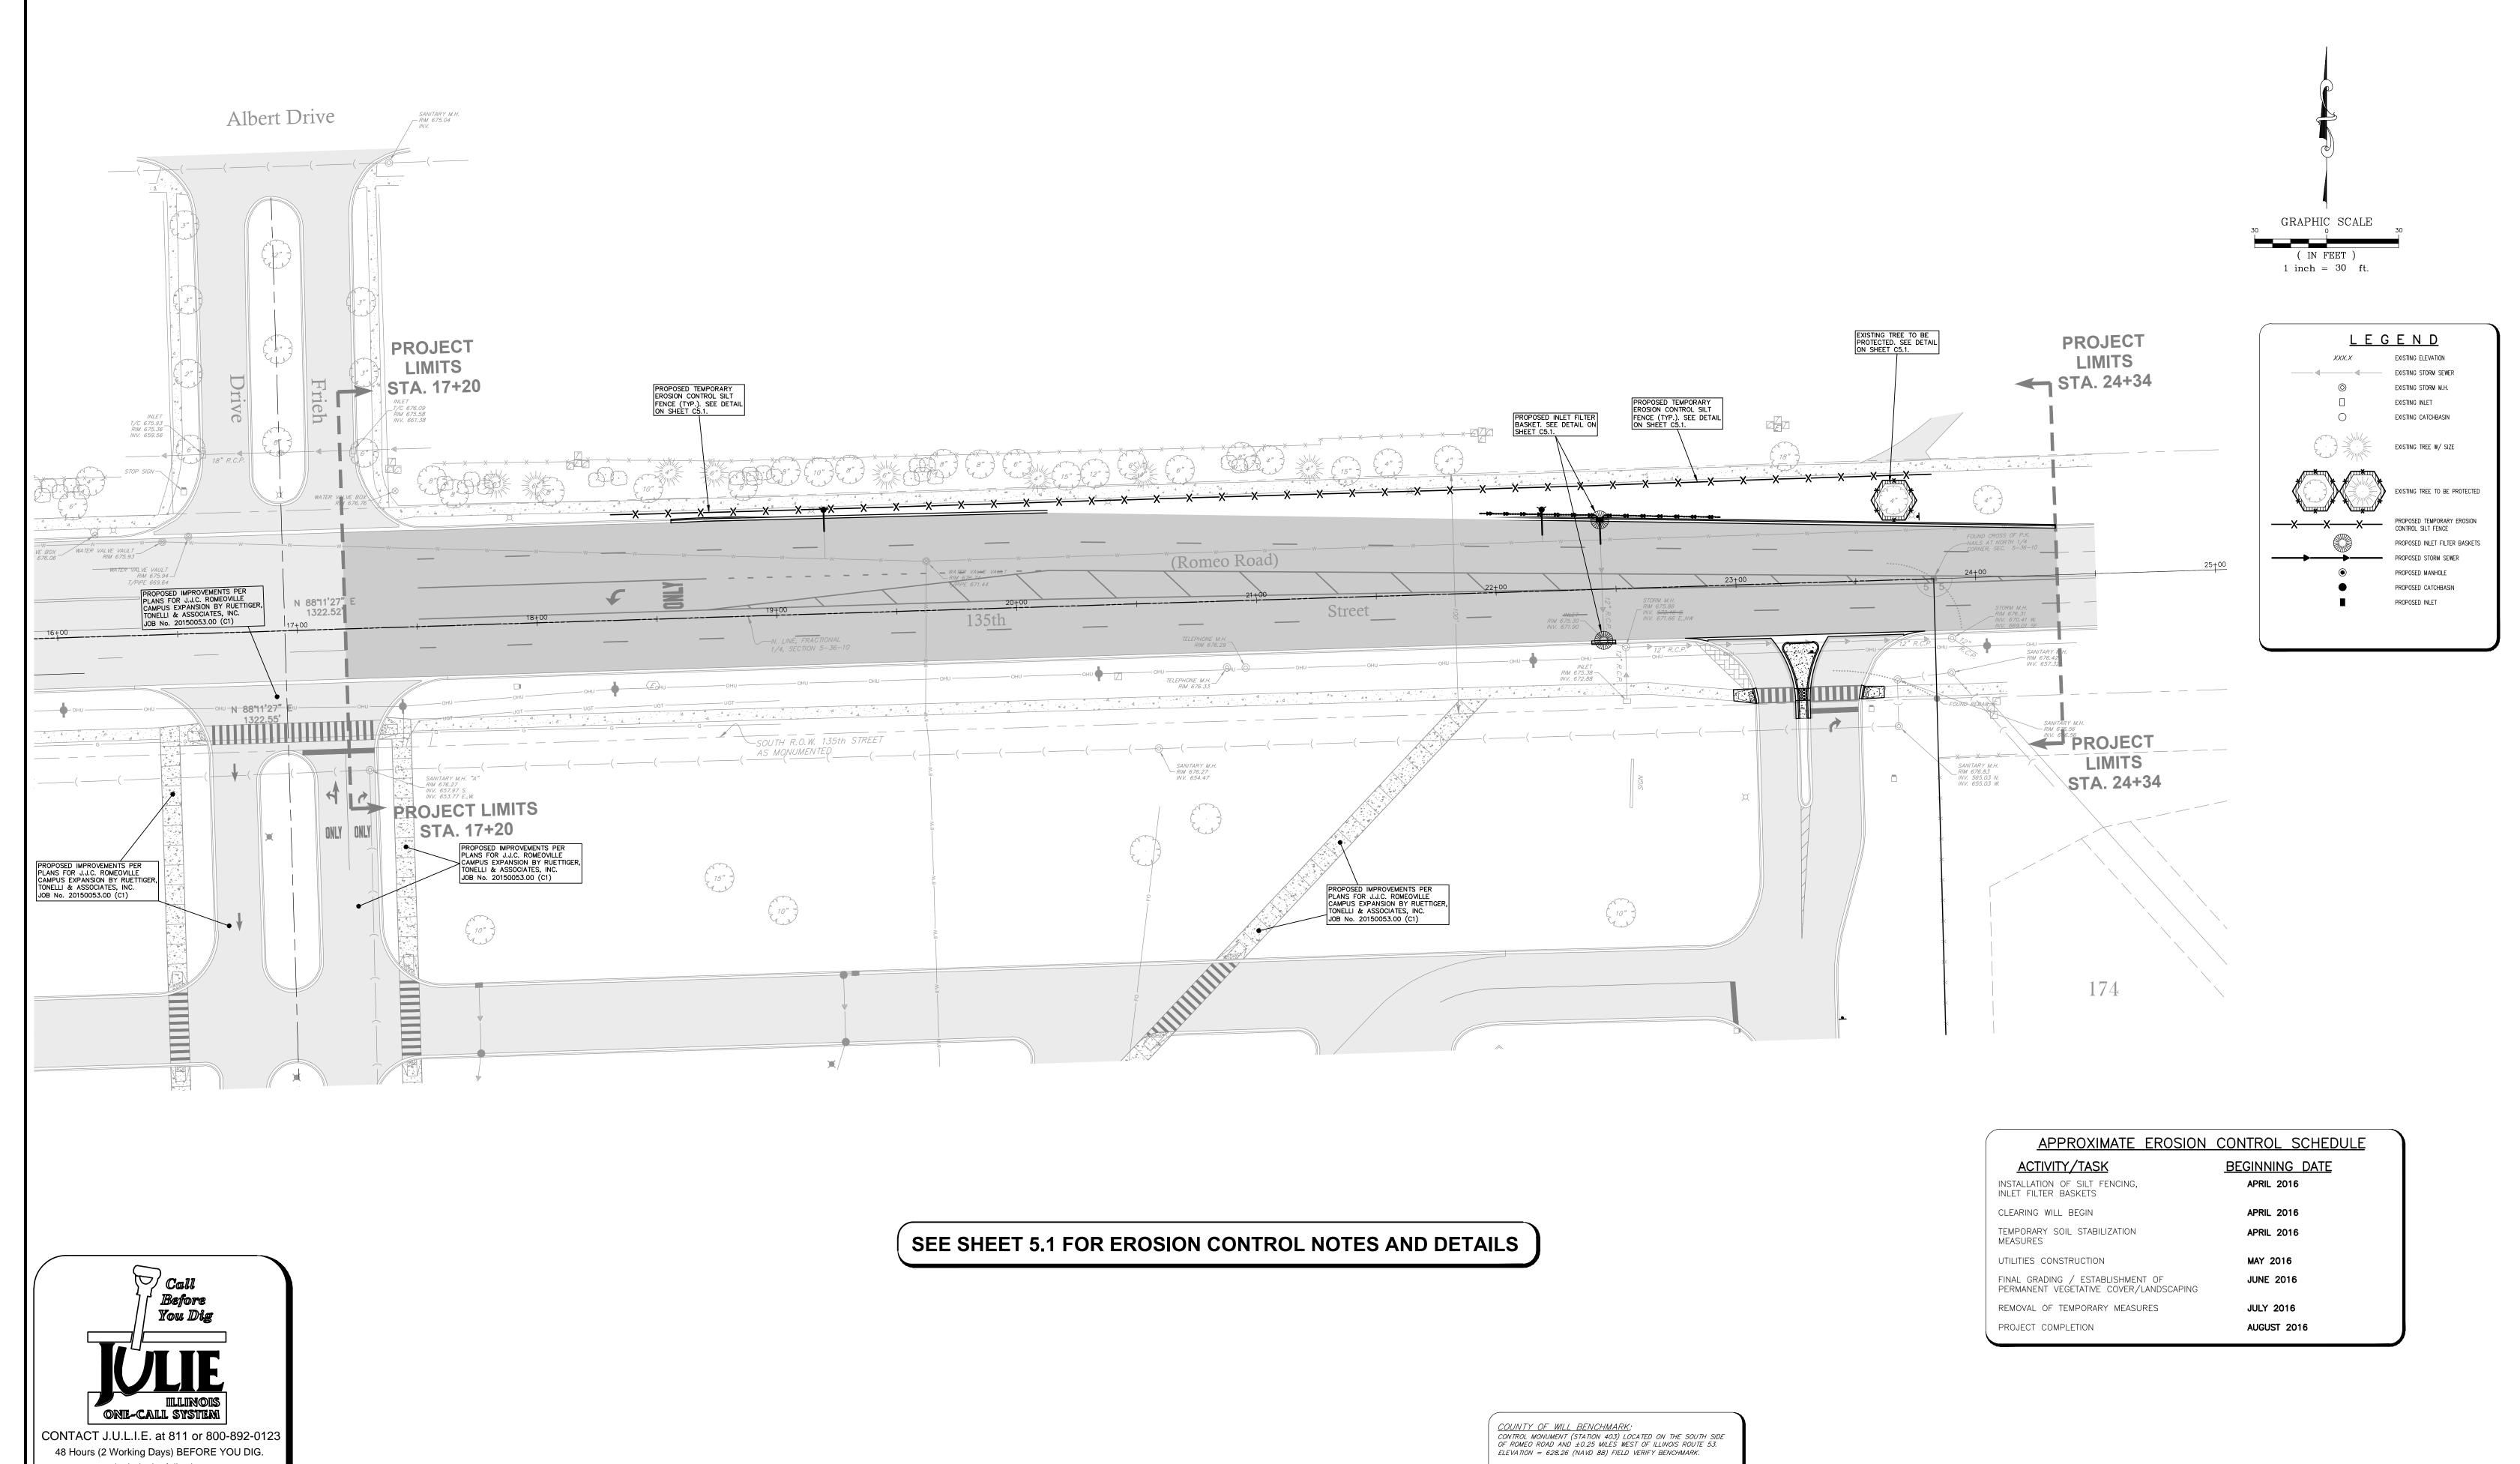
DRAWING TITLE:

PROPOSED SITE GEOMETRY PLAN

DRAWING No.
315-0053-C3

SCALE:
AS NOTED

ENGINEERING DEPARTMENT SHEET C4.0



DOCUMENTATION: PROJECT No.: 20150053.00 DATE: 3-08-2016 FIELD BOOK: JJC3, P. 7-9 DRAWN BY: R.P.

CHECKED BY: J.H.

BY

County, City/Township, Section & 1/4 Section No.

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REVISED PER VILLAGE REVIEW

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REVISIONS

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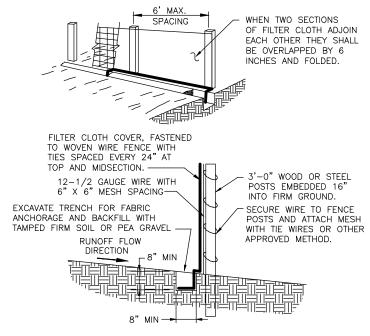
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JOLIET JUNIOR COLLEGE ROMEOVILLE CAMPUS 1125 WEST 135th STREET **ROMEOVILLE, ILLINOIS 60446**

EROSION CONTROL PLAN


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	315-0053-C3
SCALE:	AS NOTED

AS NOTED ENGINEERING DEPARTMENT SHEET C5.0



NOTES FOR SILT FENCE

- 1. MAINTENANCE SHALL BE PERFORMED AS NEEDED AND MATERIAL SHALL BE REMOVED WHEN BULGES DEVELOP IN THE SILT FENCE.
- 2. FILTER CLOTH SHALL BE FILTER X, MIRAFI 100X, STABILINKA T140N, OR EQUAL. 3. PREFABRICATED UNIT SHALL BE GEOFAB, ENVIROFENCE, OR EQUAL.
 - SILT FENCE INSTALLATION NOT TO SCALE

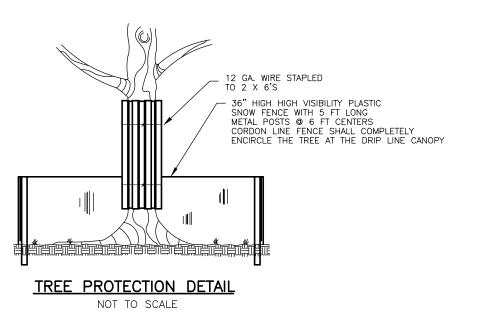

<u>EROSION CONTROL NOTES</u>

- EROSION CONTROL TO BE APPLIED PER THE ILLINOIS PROCEDURES FOR URBAN SOIL EROSION AND SEDIMENTATION CONTROL MANUAL, LATEST
- THE TEMPORARY EROSION CONTROL SYSTEMS INSTALLED BY THE
- CONTRACTOR SHALL BE PROPERLY MAINTAINED AS DIRECTED BY THE VILLAGE TO CONTROL SILTATION AT ALL TIMES DURING THE LIFE OF THE CONTRACT. ALL STORM SEWER STRUCTURES WITH OPEN GRATES SHALL BE PROTECTED WITH INLET FILTER BASKETS.
- DISTURBED AREAS SHALL BE STABILIZED WITH TEMPORARY OR PERMANENT MEASURES WITHIN (7) SEVEN CALENDAR DAYS FOLLOWING THE END OF ACTIVE DISTURBANCE, RE-DISTURBANCE, CONSISTENT WITH THE FOLLOWING CRITERIA. APPROPRIATE TEMPORARY OR PERMANENT STABILIZATION MEASURES SHALL INCLUDE SEEDING, MULCHING, SODDING AND / OR NON-VEGETATIVE MEASURES.
- ALL EROSION CONTROL ITEMS REMAIN IN PLACE AND BE MAINTAINED UNTIL DEEMED UNNECESSARY BY THE OWNER / DEVELOPER AND THE VILLAGE AT WHICH TIME THE EROSION CONTROL ITEMS SHALL BE COMPLETELY REMOVED FROM THE SITE BY THE INSTALLER.
- ALL DISTURBED AREAS NOT SPECIFICALLY IDENTIFIED FOR LANDSCAPING IMPROVEMENTS OR IMPERVIOUS SURFACE TREATMENTS SUCH AS PAVEMENTS, DRIVES, PATIOS, STOOPS, SIDEWALKS OR WALKWAYS SHALL BE FINISHED WITH A MINIMUM OF 6" OF TOPSOIL AND RESTORED IN ACCORDANCE WITH THE ILLINOIS DEPARTMENT OF TRANSPORTATION'S "STANDARD SPECIFICATIONS FOR ROAD AND BRIDGE CONSTRUCTION" (LATEST ADDITION) AS FOLLOWS: CLASS 2 SEED PER SECTION 250.

 FERTILIZED NUTRIENTS IN THE RATIO OF 1:1:1 OF NITROGEN, PHOSPHOROUS AND POTASSIUM EACH, ALL AT THE RATE OF 90
- LBS/ACRE IN ACCORDANCE WITH SECTION 250. EROSION CONTROL BLANKET: EXCELSIOR GREEN BLANKET (I.D.O.T. SEC.
- CONTRACTOR SHALL MAINTAIN RESTORED AREA AS NEEDED UNTIL GERMINATION IS COMPLETED AND THE OWNER, OR LOCAL AGENCY HAVING JURISDICTION, HAS ACCEPTED THE WORK.
- 7. FOR EACH PHASE OF WORK, THE CONTRACTOR RESPONSIBLE FOR THAT WORK IS TO PROVIDE QUALIFIED PERSONNEL WHO SHALL INSPECT:
- DISTURBED AREAS OF THE CONSTRUCTION SITE WHICH HAVE NOT BEEN STABILIZED WITH IMPERVIOUS MATERIALS OR VEGETATIVE GROUND
- STRUCTURAL CONTROL MEASURES (I.E. SILT FENCE, FILTER BASKETS,
- GRATE FABRIC, ETC.).
- OFF SITE ROADS AND ON SITE PAVEMENTS WHICH THE CONTRACTOR'S VEHICLES AND OR EQUIPMENT OPERATE. SUCH INSPECTIONS SHALL BE CONDUCTED AT LEAST ONCE EVERY SEVEN (7) CALENDAR DAYS AND WITHIN 24 HOURS OF THE END OF A STORM EVENT
- THAT HAS 0.5 INCHES OR MORE OF PRECIPITATION. ALL INSPECTIONS SHALL BE IN CONFORMANCE WITH THE STORM WATER POLLUTION PREVENTION PLAN INSPECTION REQUIREMENTS.
- ALL TEMPORARY AND PERMANENT EROSION AND SEDIMENT CONTROL PRACTICES MUST BE MAINTAINED AND REPAIRED AS NEEDED TO ASSURE EFFECTIVE PERFORMANCE OF THEIR INTENDED FUNCTION.
- MAJOR AMENDMENTS OF THE SITE DEVELOPMENT OR EROSION AND SEDIMENTATION CONTROL PLANS SHALL BE SUBMITTED TO THE DEPARTMENT OF COMMUNITY DEVELOPMENT TO BE APPROVED IN THE SAME MANNER AS THE ORIGINAL PLANS.
- 10. ANY SEDIMENT REACHING A PUBLIC OR PRIVATE ROAD SHALL BE REMOVED BY SHOVELING OR STREET CLEANING (NOT FLUSHING) BEFORE THE END OF EACH WORKDAY AND TRANSPORTED TO A CONTROLLED SEDIMENT DISPOSAL.
- 11. ALL TEMPORARY EROSION AND SEDIMENT CONTROL MEASURES SHALL BE DISPOSED OF WITHIN 30 DAYS AFTER FINAL SITE STABILIZATION IS ACHIEVED WITH PERMANENT SOIL STABILIZATION MEASURES.
- 12. DISTURBED AREAS SHALL BE STABILIZED WITH TEMPORARY OR PERMANENT MEASURES WITHIN 7 CALENDAR DAYS FOLLOWING THE END OF ACTIVE DISTURBANCE
- 13. IF DEWATERING DEVICES ARE USED, DISCHARGE LOCATIONS SHALL BE PROTECTED FROM EROSION. ALL PUMPED DISCHARGES SHALL BE ROUTED THROUGH APPROPRIATELY DESIGNED SEDIMENT TRAPS OR BASINS.
- 14. THE CONTRACTOR SHALL TAKE THE NECESSARY STEPS TO CONTROL WASTE SUCH AS DISCARDED BUILDING MATERIALS, CONCRETE TRUCK WASHOUT, CHEMICALS, LITTER AND SANITARY WASTE AT THE CONSTRUCTION SITE THAT MAY CAUSE ADVERSE IMPACTS TO WATER QUALITY.
- 15. ALL STORM SEWER FRAMES AND GRATES/LIDS SHALL BE MARKED WITH 'DUMP NO WASTE" AND "DRAINS TO CREEK". THIS NOTE MUST ALSO BE INCLUDED ON ALL DRAINAGE STRUCTURE DETAILS. 16. ALL ACCESS TO AND FROM THE CONSTRUCTION SITE IS TO BE RESTRICTED TO THE CONSTRUCTION ENTRANCE.

SUPPLEMENTAL VILLAGE NOTES:

"THE CONTRACTOR SHALL TAKE THE NECESSARY STEPS TO CONTROL WASTE SUCH AS DISCARDED BUILDING MATERIALS, CONCRETE TRUCK WASHOUT, CHEMICALS, LITTER AND SANITARY WASTE AT THE CONSTRUCTION SITE THAT MAY CAUSE ADVERSE IMPACTS TO WATER QUALITY."

"ALL STORM SEWER FRAMES AND GRATES/LIDS SHALL BE MARKED WITH "DUMP NO WASTE" AND "DRAINS TO CREEK"." THIS NOTE MUST ALSO BE INCLUDED ON ALL DRAINAGE STRUCTURE DETAILS.

"A NOTICE OF INTENT (NOI) MUST BE SUBMITTED TO THE NPDES PERMITTING AUTHORITY AND POSTMARKED AT LEAST 30 DAYS BEFORE COMMENCEMENT OF ANY WORK ON-SITE FOR ALL CONSTRUCTION SITES OVER ONE ACRE. INCLUDED IN THE NOI SHALL BE THE STORMWATER POLLUTION PREVENTION PLAN (SWPP), WHICH

INCLUDES THE APPROPRIATE BMP'S TO MINIMIZE THE DISCHARGE OF POLLUTANTS FOR THE CONSTRUCTION SITE." "AN INCIDENT OF NON—COMPLIANCE (ION) MUST BE COMPLETED AND SUBMITTED TO THE IEPA IF, AT ANY TIME, AN EROSION OR SEDIMENT CONTROL DEVICE FAILS." "A NOTICE OF TERMINATION (NOT) MUST BE COMPLETED AND SUBMITTED TO THE IEPA WHEN ALL PERMANENT EROSION CONTROL MEASURES ARE IN PLACE WITH A

THE OWNER IS ULTIMATELY RESPONSIBLE FOR THE LEGAL REQUIREMENT OF MAINTAINING THE EROSION CONTROL.

70% ESTABLISHMENT OF VEGETATION."

MAINTENANCE RESPONSIBILITY CONTACT: JOLIET JUNIOR COLLEGE

1125 WEST 135TH STREET ROMEOVILLE, ILLINOIS 60446 ATTN: RICK LYMAN

OFFICE PH: (815) 280-2212 MOBILE PH: (815) 735-2682

SEE SHEET 5.0 FOR EROSION CONTROL PLAN

Call Before You Dig LILINOIS ONE-CALL SYSTEM
CONTACT J.U.L.I.E. at 811 or 800-892-0123
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135th STREET IMPROVEMENTS JOLIET JUNIOR COLLEGE


ROMEOVILLE CAMPUS 1125 WEST 135th STREET **ROMEOVILLE, ILLINOIS 60446** DRAWING TITLE:

EROSION CONTROL NOTES AND DETAILS


315-0053-C3 SCALE: **AS NOTED**

DRAWING No.

ENGINEERING DEPARTMENT SHEET C5.1

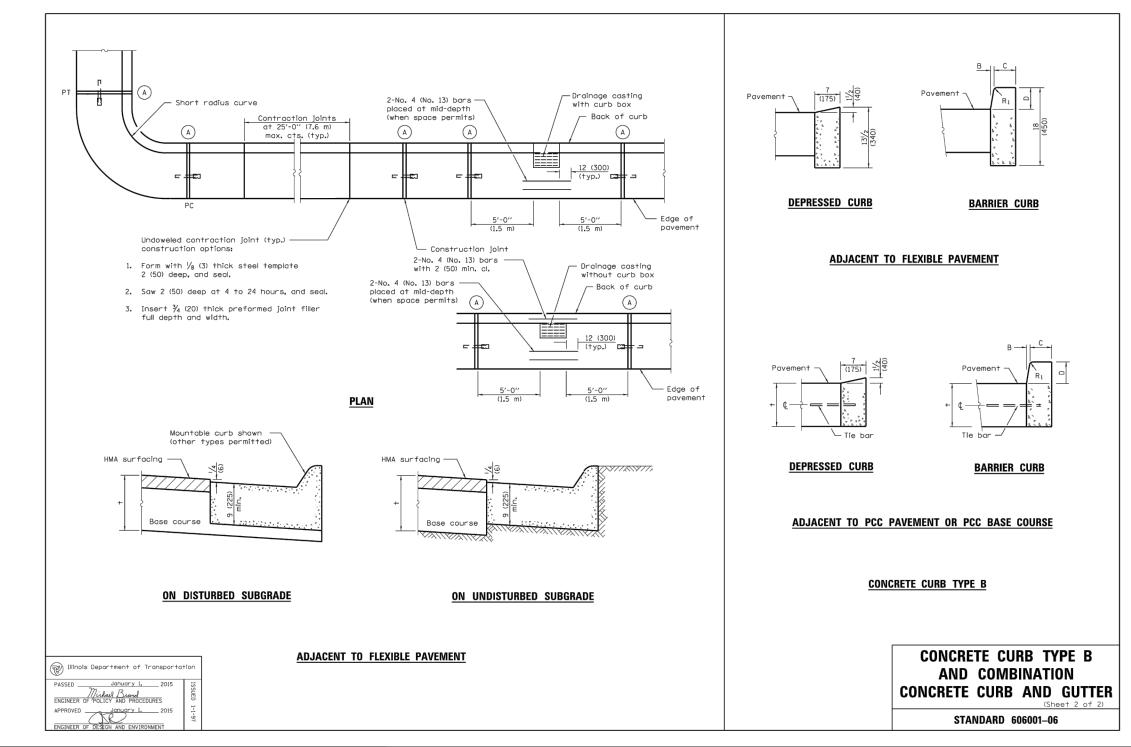


NOTE: ALL NEW CURB AND GUTTER TO TIE INTO EXISTING CURB AND GUTTER SHALL BE DOWELED TOGETHER. THREE (3) DRILLED AND GROUTED No. 5 REINFORCING BARS OR EXPANSION TIE ANCHORS, 5/8" IN DIAMETER, SHALL BE USED TO TIE THE NEW CURB AND GUTTER TO THE EXISTING CURB AND GUTTER.

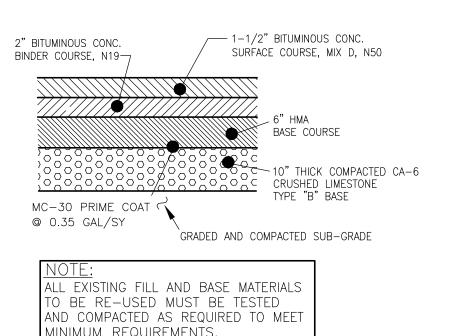

PROPOSED PAVEMENT SECTION (FULL DEPTH)


NOT TO SCALE

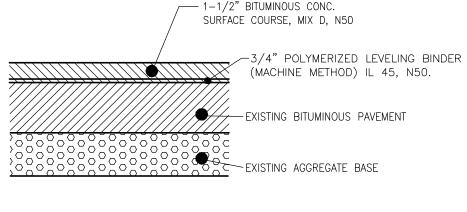

- 1. CONTRACTOR IS TO GRIND 2" OF EXISTING BITUMINOUS PAVEMENT.
- 2. PRIME/TACK COAT SHALL BE INSTALLED PER I.D.O.T. STANDARD SPECIFICATIONS.


RESURFACING AREA SECTION

NOT TO SCALE

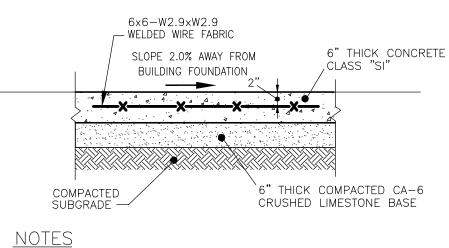

- 1. SURFACE TO BE A LIGHT BROOM FINISH AT RIGHT ANGLES TO THE EDGES OF THE SIDEWALK.
- ASPHALTIC FELT EXPANSION JOINTS SHALL BE PROVIDED 30'-0" ON CENTER. WITH 1/2" DEEP CONTROL (FALSE) JOINTS AS SHOWN ON CONCRETE SCORING PLAN.

TYPICAL P.C.C. ISLAND SECTION NOT TO SCALE

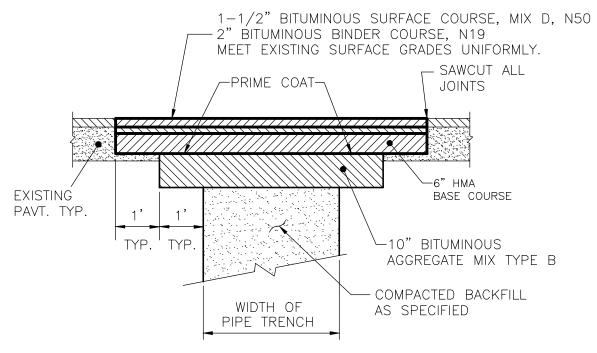

BITUMINOUS PAVEMENT REPAIR NOT TO SCALE

SEWER AND WATER MAIN NOTES:

SANITARY SEWER & WATER MAIN SEPARATION SHALL CONFORM TO SECTION 41-2.01 OF THE STANDARD SPECIFICATIONS FOR WATER AND SEWER MAIN CONSTRUCTION IN ILLINOIS.

WATER MAIN

- 1. WATER MAIN SHALL BE CEMENT LINED DUCTILE IRON C-151, CLASS 52. ALL WATER MAIN SHALL BE WRAPPED IN POLYETHYLENE USING METHOD B. ALL JOINTS MUST BE RESTRAINED WITH MEGALUGS (EBBA IRON) ONLY. (SEE VILLAGE CHLORINATION REQUIREMENTS)
- 2. ALL FITTINGS SHALL BE CEMENT LINED DUCTILE IRON, MECHANICAL JOINT; RETAINER GLANDS ARE REQUIRED ON ALL BENDS, TEES, OR

ELBOWS; ALL PLUGS SHALL BE CLOW F-1159 OR APPROVED EQUAL.

- 3. FIRE HYDRANT MUST BE EAST JORDAN WATER MASTER 5BR250, WITH 6" PLAIN END SHOE WITH ATTACHED 6" RESILIENT WEDGE MECHANICAL JOINT VALVES AND MUST INCLUDE A STORZ PUMPER CONNECTION ALONG WITH TWO 2-1/2" HOSE CONNECTIONS.
- 4. ALL VALVES MUST BE EAST JORDAN IRON WORKS (FLOW MASTER) OR AMERICAN FLOW, RESILIENT-SEATED GATE VALVES FOR ALL SIZES. VALVE VAULT FRAMES AND COVERS MUST BE EAST JORDAN 1022Z3 AND EMBOSSED WITH 1020A HD "WATER" AND "VILLAGE OF ROMEOVILLE". ALL JOINTS NEED TO BE EXTERNALLY WRAPPED W/ MACWRAP OR EQUAL. RUBBER GASKET BOOTS ARE REQUIRED FOR ALL PENETRATIONS THROUGH THE MANHOLE WALL. INTERNAL / EXTERNAL CHIMNEY SEALS ARE REQUIRED.
- 5. RETAINER GLANDS SHALL BE REQUIRED FOR HYDRANTS NOT DIRECTLY
- 6. ALL VALVE VAULTS SHALL BE A MINIMUM OF 5' DIAMETER.

CONNECTED TO HYDRANT TEE AT WATERMAIN.

7. PRECAST MANHOLES FOR WATER VALVE INSTALLATIONS:

A.) MANHOLES MUST CONFORM TO THE LATEST REQUIREMENTS OF

B.) NEVER TRANSPORT SECTIONS TO THE SITE UNTIL THEY HAVE CURED FOR AT LEAST TEN (10) DAYS.

C.) MARK EACH PIECE PLAINLY WITH MANHOLE NUMBERS AND DATE OF MANUFACTURE SO IT CAN BE INSTALLED IN THE PROPER LOCATION, AS SHOWN ON THE PLANS.

D.) MAKE SURE FACTORY-INSTALLED CUTOUTS IN THE BOTTOM SECTION ARE APPROPRIATE FOR THE PIPE BEING LAID.

E.) PIPE CONNECTIONS AT MANHOLE-CUTOUTS SHOULD BE EQUIPPED WITH RUBBER BOOTS TO ENSURE A WATERTIGHT CONNECTION. MATERIAL SHALL BE EQUAL TO KOR-N-SEAL CONNECTOR, AS MANUFACTURED BY NPC, INC.

F.) JOINT SEALANT - FLEXIBLE RUBBER SEALANT FOR JOINTS IN PRE-CAST MANHOLE SECTIONS SHALL PROVIDE PERMANENTLY FLEXIBLE WATERTIGHT JOINTS, SHALL REMAIN WORKABLE OVER A WIDE TEMPERATURE RANGE AND SHALL NOT SHRINK, HARDEN OR OXIDIZE UPON AGING. MATERIAL SHALL BE EQUAL TO TYLOX SUPERSEAL AND SHALL MEET ASTM C 443 AND ASTM C 361 REQUIREMENTS.

G.) THE FRAME FOR THE LID SHALL BE INSTALLED WHEN CONE SECTION IS CAST.

H.) HEAT-SHRINKABLE ENCAPSULATION FOR EXTERNAL WRAPPING OF ALL JOINTS: WRAPID SEAL AS MANUFACTURED BY CANUSA CPS, BIDCO EXTERNAL JOINT WRAP AS MANUFACTURED BY NPC, OR APPROVED EQUAL.

I.) A MINIMUM OF TWO ADJUSTING RINGS (MIN. 6" ADJUSTING HEIGHT) AND A MAXIMUM OF THREE ADJUSTING RINGS (MAX. 10" ADJUSTING HEIGHT). NO 1" OR 2" CONCRETE RINGS ARE ALLOWED. UNDER PAVED ARÉAS TOP RING SHALL BE RUBBER. USE ONE E.J.I.W. INFRA-RISER RUBBER COMPOSITE ADJUSTMENT RISERS (1" TO 3" MAXIMUM HEIGHT OF STACKED RISERS).

J.) PLEASE BE CONSCIOUS OF DAMAGING THE PAINT ON THE HYDRANTS DURING INSTALLATION. THE VILLAGE OF ROMEOVILLE HAS FOUND THAT THE PAINT ON THE HYDRANTS CAN BE DAMAGED DURING BACKFILLING. IF REQUESTED BY THE VILLAGE OF ROMEOVILLE WATER SUPERINTENDENT, ANY HYDRANTS EXHIBITING EXCESSIVE ROCK DAMAGE WILL BE SAND BLASTED AND REPAINTED BY AN APPROVED CONTRACTOR PRIOR TO ACCEPTANCE.

K.) A MINIMUM OF 48 HOURS PRIOR TO ANY WATER USAGES (I.E. FLUSHES, FILLS, ETC.), THE CONTRACTOR MUST CALL THE VILLAGE OF ROMEOVILLE'S WATER DEPARTMENT AT 815-886-1870 TO GET APPROVAL OF SAID USAGE. ANY UNAUTHORIZED USAGES WILL RESULT IN PENALTIES.

L.) ALL VALVES AND HYDRANTS SHALL BE SUBMITTED TO THE VILLAGE OF ROMEOVILLE WATER DEPARTMENT FOR WRITTEN APPROVAL PRIOR TO ORDERING.

SITE CONSTRUCTION GENERAL NOTES

- ALL NEW CONSTRUCTION SHALL BE DONE IN ACCORDANCE WITH "STANDARD SPECIFICATIONS FOR WATER AND SEWER MAIN CONSTRUCTION IN ILLINOIS" LATEST EDITION; AND "STANDARD SPECIFICATIONS FOR ROAD AND BRIDGE CONSTRUCTION" - ILLINOIS DEPARTMENT OF TRANSPORTATION, LATEST EDITION. TRACK AND SYNTHETIC TURF
- MANUFACTURERS STANDARDS. 2. THE OWNER AND/OR CONTRACTOR ARE REQUIRED TO FILE A NOTICE OF INTENT (NOI) WITH THE ILLINOIS ENVIRONMENTAL PROTECTION AGENCY (IEPA) RELATIVE TO STORM WATER DISCHARGE QUALITY, AND OBTAIN A GENERAL PERMIT ILR-10 OR OTHER NATIONAL POLLUTANT ELIMINATION SYSTEM (NPDES) PERMIT AS MAY BE REQUIRED PRIOR TO ANY SITE
- UNLESS NOTED OTHERWISE, ANY UNDERGROUND SEWER OR DRAIN TILE SHALL REMAIN IN OPERATION, AND IF DAMAGED SHALL BE REPAIRED TO EXISTING OR BETTER CONDITION. THE OWNER OF THE TILE AND THE
- VILLAGE SHALL BE NOTIFIED BEFORE TRENCH IS BACKFILLED. 4. CONTRACTOR SHALL FIELD VERIFY EXISTING CONDITIONS AND NOTIFY THE OWNER, VILLAGE AND ENGINEER IF THERE IS ANY DISCREPANCY BETWEEN THE PLANS AND EXISTING CONDITIONS PRIOR TO PROCEEDING WITH ANY
- 5. GRANULAR BACKFILL TO BE CRUSHED LIMESTONE CA-7.

STAGE OF CONSTRUCTION OF PROPOSED IMPROVEMENTS.

- 6. EROSION CONTROL TO BE APPLIED PER THE ILLINOIS PROCEDURES FOR URBAN SOIL EROSION AND SEDIMENTATION CONTROL MANUAL, LATEST
- 7. IT SHALL BE THE CONTRACTOR'S RESPONSIBILITY TO COMPLETELY REMOVE AND PROPERLY DISPOSE OF EXISTING STRUCTURES, DEBRIS, WASTES AND VEGETATION FROM THE SITE AS NOTED ON THE PLAN OR AS MAY BE REQUIRED TO PROPERLY COMPLETE HIS WORK. ALL DEBRIS AND SURPLUS MATERIALS REMOVED FROM THE SITE SHALL BE PROPERLY DISPOSED OF BY THE CONTRACTOR. NO ON-SITE BURNING OR BURIAL SHALL BE
- THE CONTRACTOR SHALL MAINTAIN THE SITE IN A CLEAN AND ORDERLY MANNER AT ALL TIMES. DEBRIS AND SURPLUS MATERIAL CLEAN UP AND REMOVAL SHALL PROCEED AS THE WORK PROCEEDS.
- 8. FIELD VERIFY LOCATIONS OF ALL EXISTING UTILITIES AND BUILDING SERVICES. PROTECT ALL EXISTING UTILITIES DURING CONSTRUCTION. COORDINATE ANY DISTURBANCE AND/OR UTILITY CONNECTIONS WITH GOVERNING UTILITY ENTITIES AND MUNICIPAL AGENCIES.
- 9. ALL ACCESS TO AND FROM THE CONSTRUCTION SITE IS TO BE RESTRICTED TO THE CONSTRUCTION ENTRANCE.
- 10. ALL TEMPORARY AND PERMANENT EROSION AND SEDIMENT CONTROL PRACTICES MUST BE MAINTAINED AND REPAIRED AS NEEDED TO ASSURE EFFECTIVE PERFORMANCE OF THEIR INTENDED FUNCTION.
- 11. MAJOR AMENDMENTS OF THE SITE DEVELOPMENT OR EROSION AND SEDIMENTATION CONTROL PLANS SHALL BE SUBMITTED TO THI DEPARTMENT OF COMMUNITY DEVELOPMENT TO BE APPROVED IN THE SAME MANNER AS THE ORIGINAL PLANS.
- 12. ANY SEDIMENT REACHING A PUBLIC OR PRIVATE ROAD SHALL BE REMOVED BY SHOVELING OR STREET CLEANING (NOT FLUSHING) BEFORE THE END OF EACH WORKDAY AND TRANSPORTED TO A CONTRÓLLED
- 13. ALL TEMPORARY EROSION AND SEDIMENT CONTROL MEASURES SHALL BE DISPOSED OF WITHIN 30 DAYS AFTER THE FINAL SITE STABILIZATION IS ACHIEVED WITH PERMANENT SOIL STABILIZATION MEASURES.
- 14. IF DEWATERING DEVISES ARE USED, DISCHARGE LOCATIONS SHALL BE PROTECTED FROM EROSION. ALL PUMPED DISCHARGES SHALL BE ROUTED THROUGH APPROPRIATELY DESIGNED SEDIMENT TRAPS OR BASINS.
- 15. A WATER TRUCK SHALL BE USED FOR DUST CONTROL MEASURES ON-SITE DURING CONSTRUCTION.
- 16. ANY DAMAGED STREET LIGHTING CABLES SHALL BE REPLACED WITH CONTINUOUS RUN OF CABLE BETWEEN LIGHT POLES. SPLICES ARE NOT ALLOWED.
- 17. UPON COMPLETION OF CONSTRUCTION, RECORD DRAWINGS FOR ALL PUBLIC IMPROVEMENTS MUST BE PROVIDED TO THE VILLAGE ON DISKETTE IN AUTOCAD (.DWG) FORMAT. CORRECTIONS TO SITE DESIGN, UTILITY PLACEMENT, AND ÉLEVATIONS MUST BE SHOWN ON THE DIGITAL DRAWINGS BY CROSSING OUT THE ORIGINAL DESIGN INFORMATION AND ADDING THE CHANGES MADE.

STORM SEWER:

- STORM SEWER SHALL BE REINFORCED CONCRETE PIPE CONFORMING TO ASTM C76 CLASS SHOWN ON DRAWINGS, O-RING JOINTS CONFORMING TO ASTM C443.
- STORM SEWER JOINTS MUST BE FLEXIBLE GASKET O-RINGS PER ASTM C361, ASTM C433, AND ASTM C1619.
- 3. ALL CLOSED LID STORM STRUCTURES, FRAME AND COVER SHALL BE EAST JORDAN 1022Z3 EMBOSSED WITH "STORM" AND "VILLAGE OF ROMEOVILLE".
- 4. WHEN UTILITY STRUCTURE ADJUSTMENT IS NECESSARY, A MINIMUM OF TWO ADJUSTING RINGS (MIN. 6" ADJUSTING HEIGHT) AND MAXIMUM OF THREE RINGS (MAX. 10" ADJUSTING HEIGHT). NO 1" OR 2" CONCRETE RINGS ALLOWED. UNDER PAVED AREAS, TOP RING SHOULD BE RUBBER. USE ONE (1) EAST JORDAN IRON WORKS INFRA-RISER RUBBER COMPOSITE.



REVISIONS **DOCUMENTATION** DATE DESCRIPTION BY No. DATE DESCRIPTION BY ROJECT No.: 20150053.00 -10-2016RELEASED FOR REVIEW DATE: 3-08-2016 3-18-2016 REVISED PER REVIEW REVISED PER VILLAGE REVIEW 4-14-2016 FIELD BOOK: JJC3, P. 7-9 DRAWN BY: R.P. CHECKED BY: J.H.



Ruettiger, Tonelli & Associates, Inc.

Surveyors • Engineers • Planners • Landscape Architects • G.I.S. Consultants 129 CAPISTA DRIVE - SHOREWOOD, ILLINOIS 60404 PH. (815) 744-6600 FAX (815) 744-0101 website: www.ruettigertonelli.com

135th STREET IMPROVEMENTS

JOLIET JUNIOR COLLEGE ROMEOVILLE CAMPUS 1125 WEST 135th STREET **ROMEOVILLE, ILLINOIS 60446**

GENERAL NOTES AND CONSTRUCTION DETAILS (1 OF 2)

DRAWING No. 315-0053-C3 SCALE:

VILLAGE CONTACT INFORMATION: MR. JONATHON ZABROCKI, P.E.

c/o VILLAGE OF ROMEOVILLE

ROMEOVILLE, ILLINOIS 60446

PHONE: (815) 866-1870


615 ANDERSON DRIVE


ENGINEERING DEPARTMENT SHEET C6.0


AS NOTED

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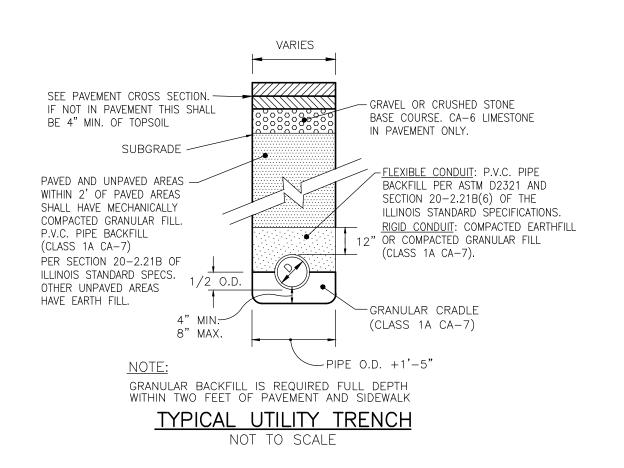




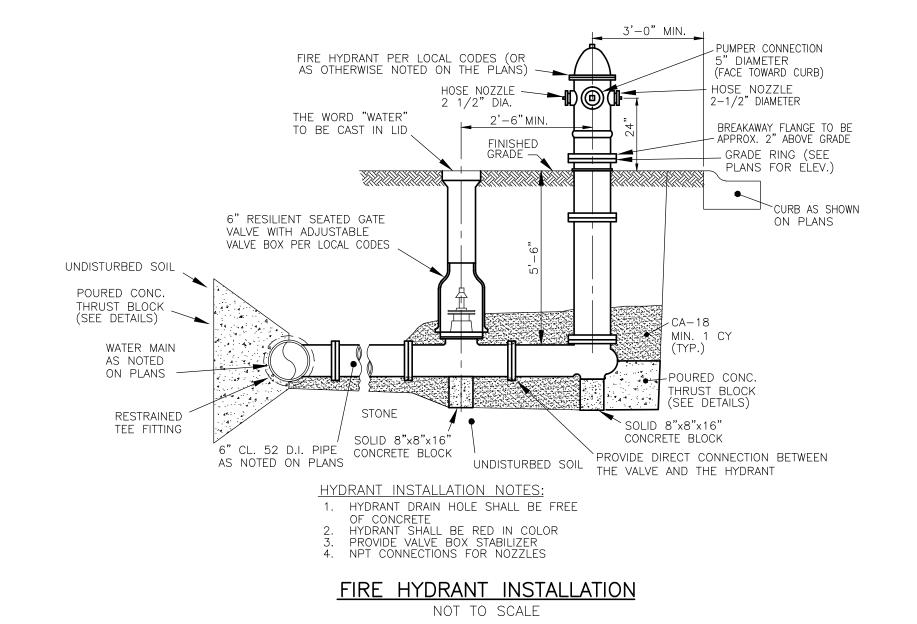

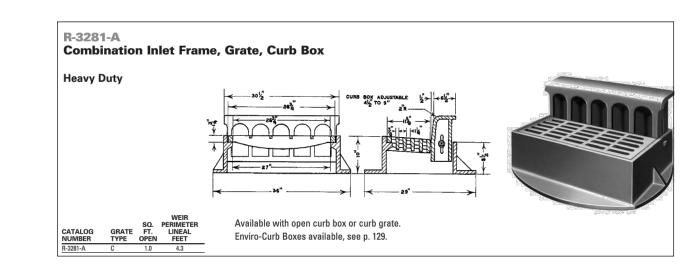- 1. INLET SHALL BE PRECAST REINFORCED CONCRETE.
- 2. ALL LIFT HOLES SHALL BE SEALED WITH NON SHRINK GROUT.
- 3. PROVIDE TEMPORARY FILTER FABRIC UNDER ALL OPEN GRATES.

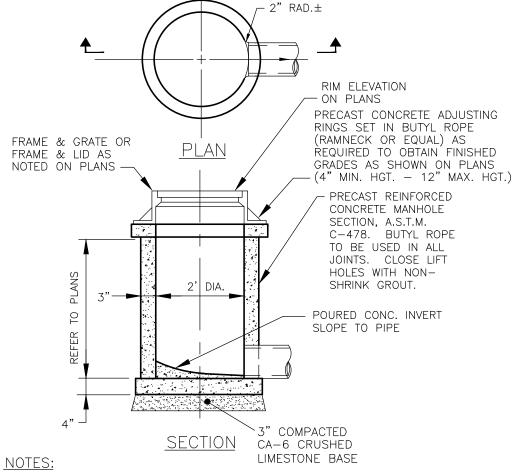TYPE A STORM INLET




Village of Romeoville - Minimum chlorination standards:

- a. Gas chlorine must be used for disinfection.
- b. The chlorination contractor must call 815-886-1870 a minimum of 24-hours in advance to schedule chlorination.
- c. Only Village of Romeoville employees shall operate water system valves and turn
- on/off sampling whips while samples are being collected.
- d. All chlorination and safety equipment must meet or exceed the standards and recommendations set by The Chlorine Institute, Inc. e. The chlorinator must be a licensed plumber or certified Illinois water operator with a minimum of 5 years experience working with chlorine disinfection of water
- f. The chlorination contractor must have two people present top chlorinate. One to monitor the cylinder and one to monitor in the field.
- g. The chlorination contractor must be bonded and insured, and have proof of both on
- file with the Village. h. The chlorination contractor must have updated 24-hour emergency phone numbers
- on file with the Village. i. The chlorination contractor must comply with state and federal regulations regarding transportation and handling of chlorine cylinders:
 - Shipping and emergency papers for every job location
 - Proof of insurance for hauling and handling chlorine gas
 - Commercial driver's license with Hazmat endorsement and medical card
 - Copy of Emergency Response Guidebook in vehicle Hazmat certificate of registration
 - Hazardous materials placard displayed on vehicle
- Cylinder strapped upright in truck Under no circumstances will chlorine contractors be allowed to apply heat to the

Works Department (815-886-1870) with any questions.

- chlorine cylinder (i.e. hot baths, propane torches, etc.). While the cylinder is being used it must be in a vertical position, as well as being affixed to a solid object. k. Prior to chlorination, the chlorination contractor must provide a detailed written
- chlorination and flushing plan to the Village for review and written approval. 1. At any time, the Village or its authorized representative may ask for proof of any or all of the above information. Please contact the Village of Romeoville Public

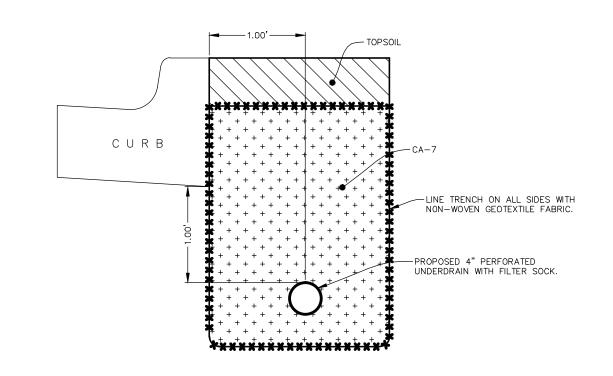

UNDERDRAIN DETAIL

VILLAGE CONTACT INFORMATION: MR. JONATHON ZABROCKI, P.E. c/o VILLAGE OF ROMEOVILLE 615 ANDERSON DRIVE ROMEOVILLE, ILLINOIS 60446

DRAWING No. 315-0053-C3


PHONE: (815) 866-1870

SCALE:

AS NOTED SHEET C6.1



REVISIONS **DOCUMENTATION** No. DATE DESCRIPTION BY DESCRIPTION BY DATE PROJECT No.: 20150053.00 -10-2016RELEASED FOR REVIEW REVISED PER REVIEW DATE: 3-08-2016 3-18-2016 REVISED PER VILLAGE REVIEW 4-14-2016 FIELD BOOK: JJC3, P. 7-9 DRAWN BY: R.P. CHECKED BY: J.H.

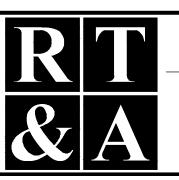

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135th STREET IMPROVEMENTS **JOLIET JUNIOR COLLEGE**


ROMEOVILLE CAMPUS 1125 WEST 135th STREET **ROMEOVILLE, ILLINOIS 60446**

CONSTRUCTION DETAILS (2 OF 2)


DRAWING TITLE:

ENGINEERING DEPARTMENT

SCALE HORIZ. : 1" = 30' **VERT.** : 1" = 10'

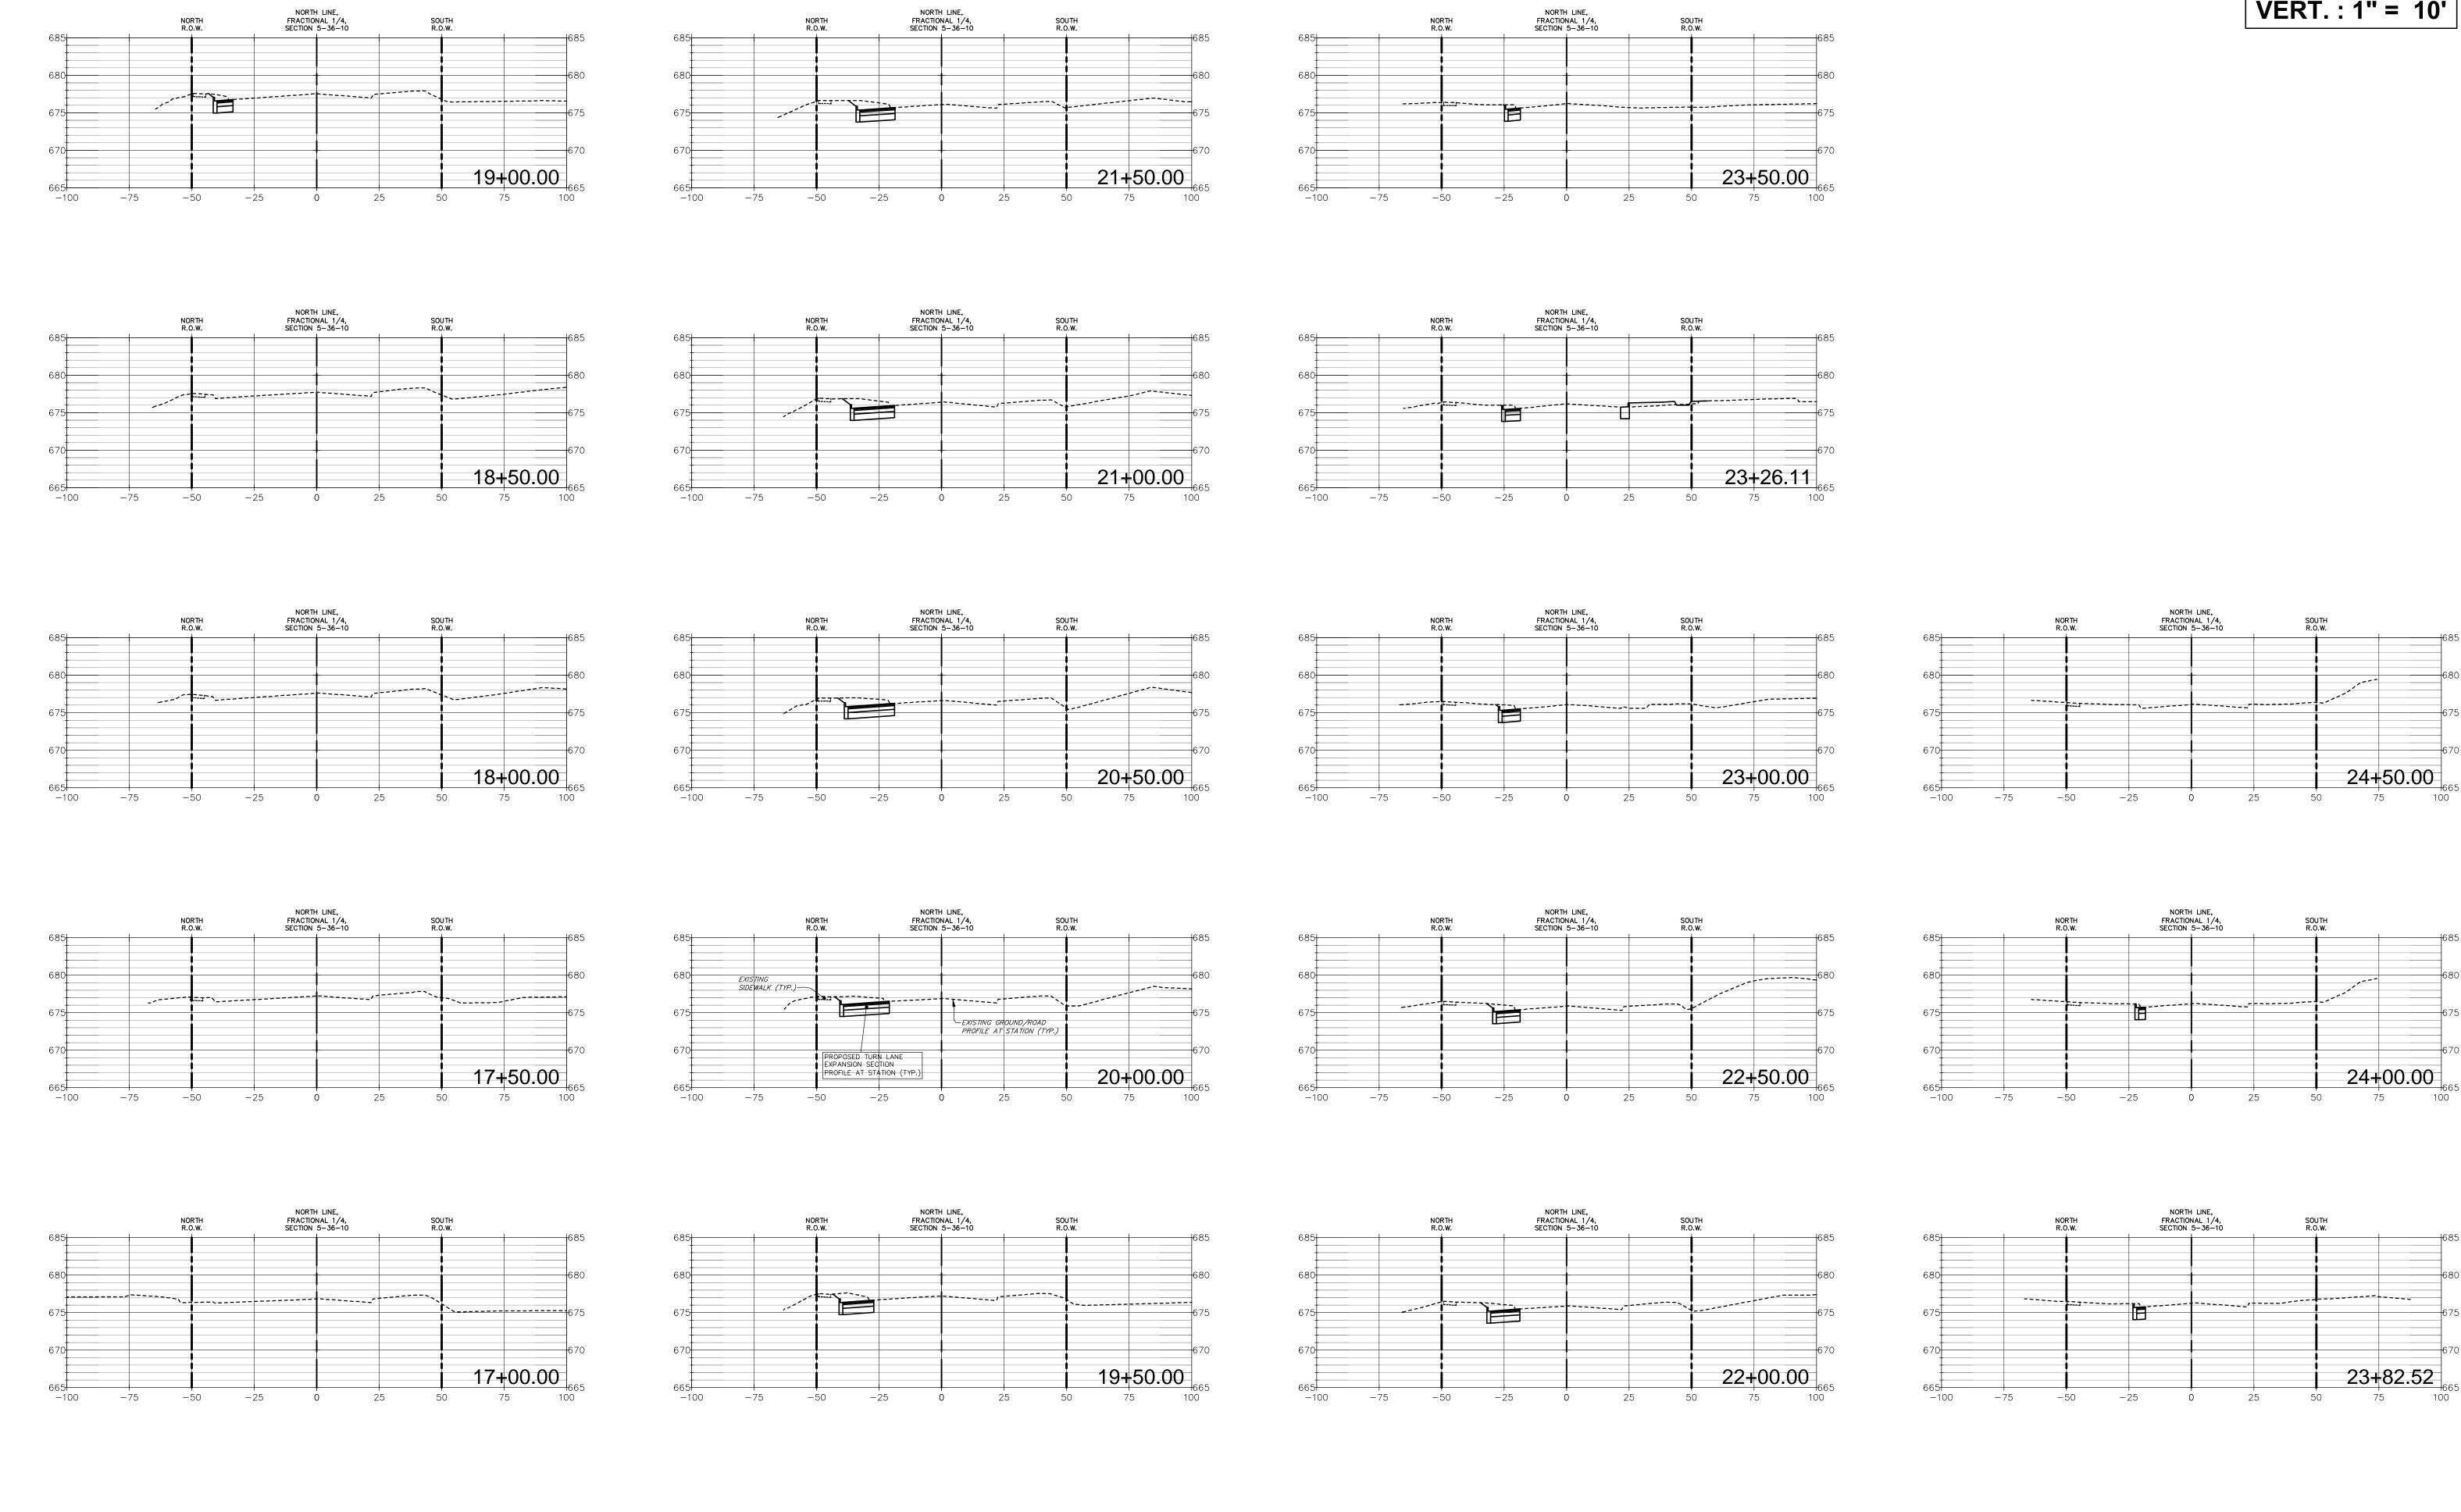

R E V I S I O N S							DOCUMENTATION:	
No.	DATE	DESCRIPTION	BY	No.	DATE	DESCRIPTION	BY	
0	3-10-2016	RELEASED FOR REVIEW	R.P.					PROJECT No.: 20150053.00
1	3-18-2016	REVISED PER REVIEW	R.P.					DATE: 3-08-2016
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								DRAWN BY: R.P.
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135th STREET IMPROVEMENTS **JOLIET JUNIOR COLLEGE** ROMEOVILLE CAMPUS 1125 WEST 135th STREET **ROMEOVILLE, ILLINOIS 60446**

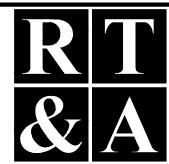135th STREET **CROSS-SECTIONS**

DRAWING TITLE:

DRAWING No.
315-0053-C3
SCALE:

AS NOTED ENGINEERING DEPARTMENT

SHEET C7.0