

CAMPUS MAP

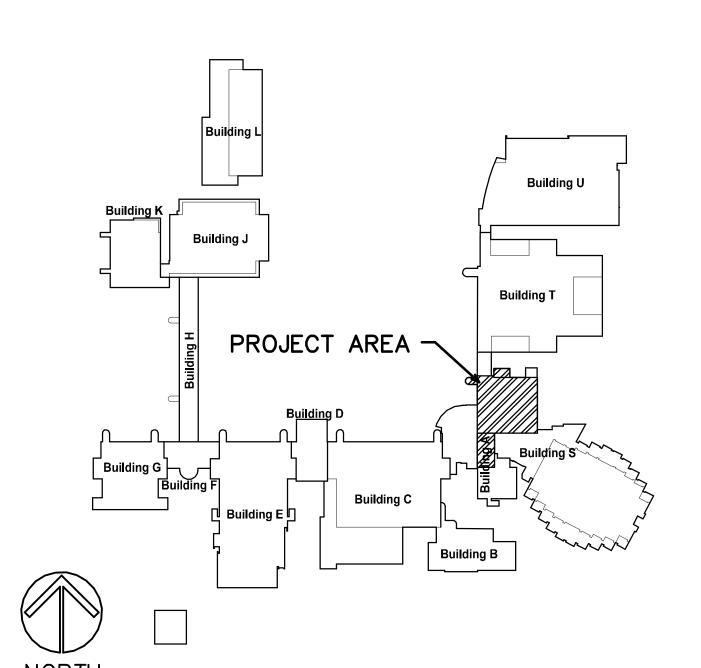

LOCATION MAP

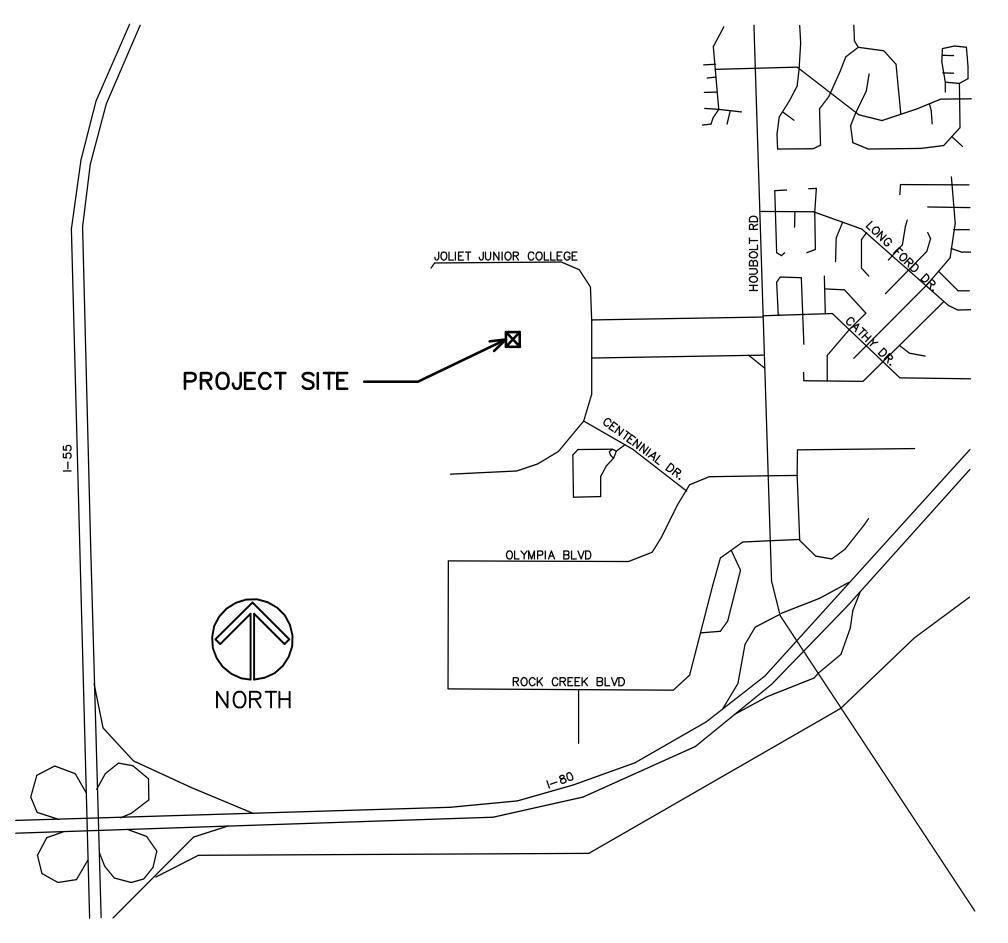

INDEX OF SHEETS

11 PROJECT TITLE, LOCATION, INDEX OF SHEETS

1 ROOF PLAN AND NOTES

ROOF DETAILS


SET NUMBER

ROOFING REPLACEMENT

JOLIET JUNIOR COLLEGE - BUILDING S 1215 HOUBOLT ROAD JOLIET, ILLINOIS

> STROMSLAND + DE YOUNG + PRYBYS ARCHITECTURE GROUP

> > 20620 BURL COURT JOLIET, IL 60433 PHONE: 815-727-1311 FAX: 815-727-5210

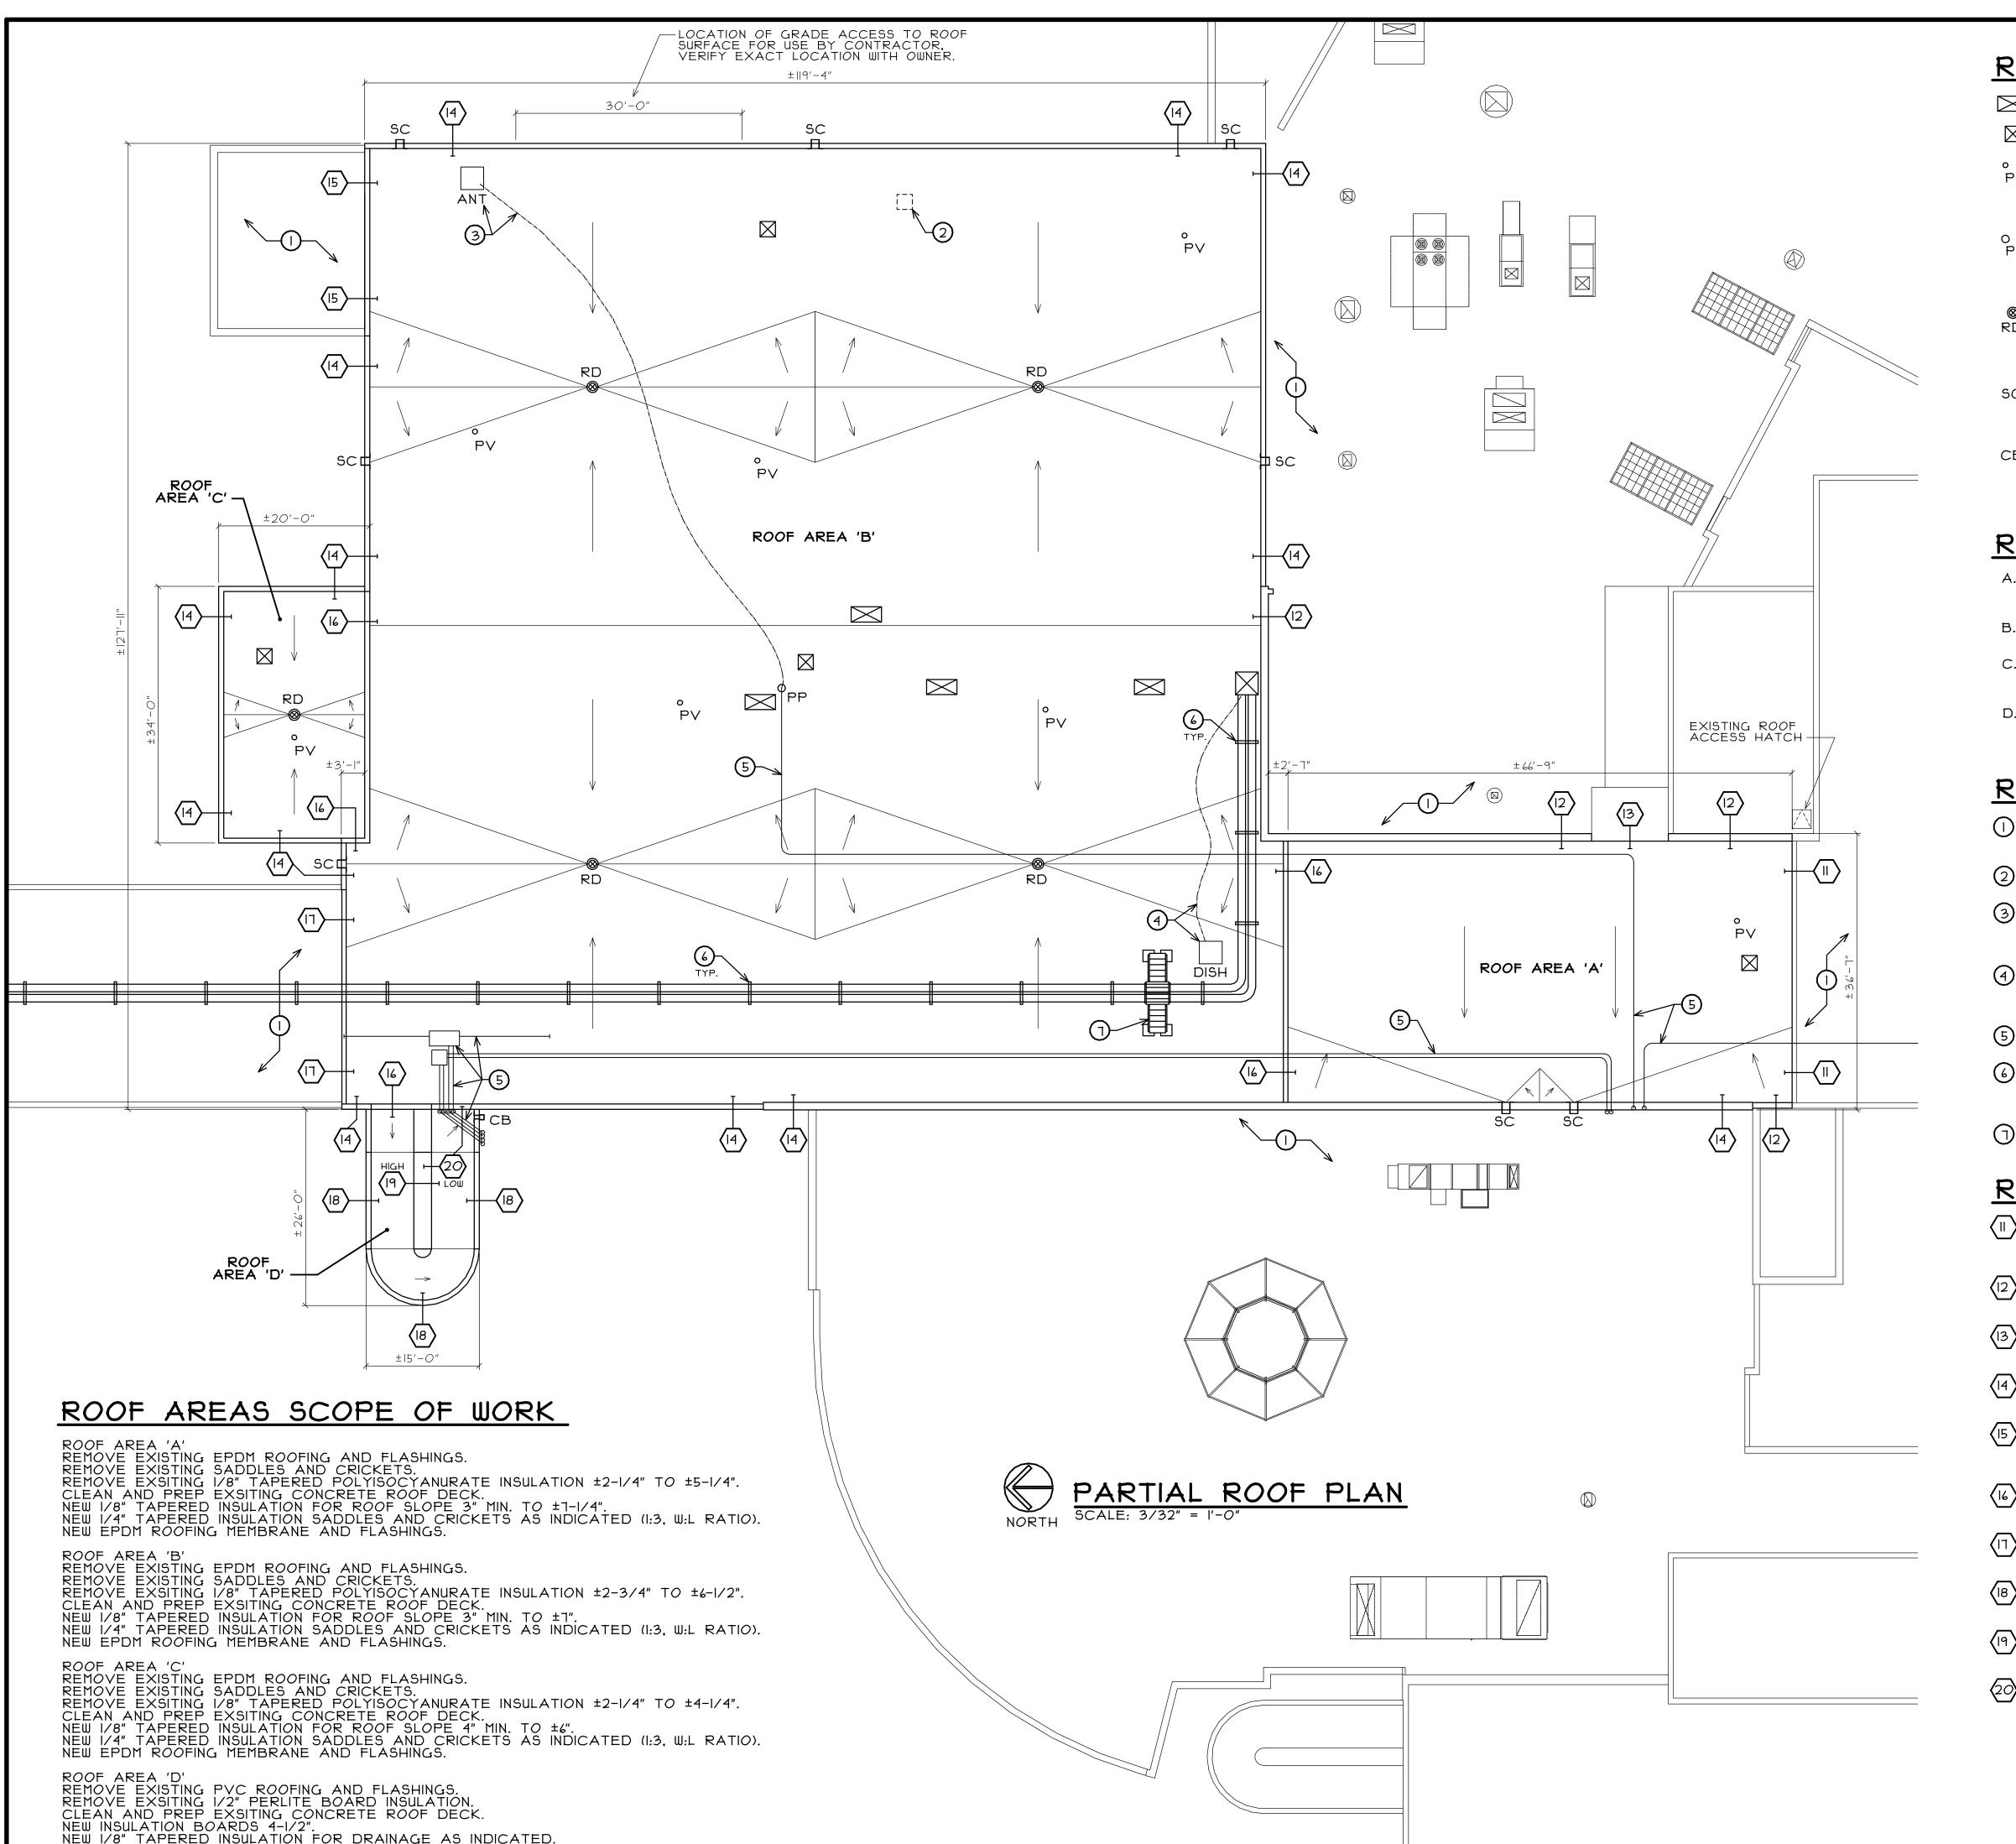

NEW EPDM ROOFING MEMBRANE AND FLASHINGS.

ROOF PLAN LEGEND

- EXISTING HVAC EQUIPMENT ON ROOF CURB, VERIFY EXACT SIZES AND LOCATIONS IN FIELD. EXISTING FLASHING TO BE REMOVED AND REPLACED PER ROOFING MEMBRANE MANUFACTURER'S REQUIREMENTS.
- EXISTING PLUMBING VENT PENETRATION THROUGH ROOF. VERIFY EXACT QUANTITIES AND LOCATIONS IN FIELD.
 EXISTING FLASHING TO BE REMOVED AND REPLACED
 PER ROOFING MEMBRANE MANUFACTURER'S
- EXISTING PIPE PORTAL PENETRATION THROUGH ROOF. VERIFY EXACT SIZES AND LOCATIONS IN FIELD.
 EXISTING FLASHING TO BE REMOVED AND REPLACED PER ROOFING MEMBRANE MANUFACTURER'S REQUIREMENTS.
- EXISTING ROOF DRAIN TO REMAIN, VERIFY EXACT SIZES AND LOCATIONS IN FIELD. TRIM SURFACE OF NEW INSULATION TO MEET HEIGHT OF EXISTING DRAINS (V.I.F.), CREATE 2-FOOT MINIMUM RADIUS SUMP AROUND
- EXISTING THROUGH-WALL SCUPPER, VERIFY EXACT SIZES AND LOCATIONS IN FIELD. REMOVE AND REPLACE EXISTING METAL SCUPPER AND FLASHING PER SECTION 3 ON SHEET A2 AND ROOFING MEMBRANE MANUFACTURER'S REQUIREMENTS.
- EXISTING THROUGH-WALL METAL SCUPPER TO COLLECTION BOX AND DOWNSPOUT TO REMAIN, EXISTING FLASHING TO BE REMOVED AND REPLACED PER ROOFING MEMBRANE MANUFACTURER'S REQUIREMENTS.

ROOF PLAN GENERAL NOTES

- A. ALL MATERIALS REMOVED AND NOT SALVAGED OR REUSED SHALL BE PROPERLY DISPOSED OF OFF SITE BY CONTRACTOR.
- VERIFY ANY ADDITIONAL DEMOLITION WORK REQUIRED FOR THE REMOVAL/REPLACEMENT OF EXISTING ROOF.
- ROOFING MEMBRANE AND/OR SYSTEM SHALL BE A COMPLETE SYSTEM PER MANUFACTURER'S RECOMMENDATIONS AND REQUIRED WARRANTY.
- COORDINATE ALL OTHER ROOF PENETRATIONS IN FIELD WITH MANUFACTURER'S APPROVED FLASHING DETAILS

ROOF PLAN KEY NOTES

- EXISTING ROOF TO REMAIN UNLESS NOTED OTHERWISE.
 PROVIDE PROTECTION AS NEEDED DURING CONSTRUCTION OPERATIONS.
- 2 EXISTING UNUSED PRECAST CONCRETE PAVER TO BE REMOVED FROM ROOF.
- 3 EXISTING SURFACE MOUNTED ANTENNA AND LOOSE CABLES TO REMAIN IN-USE DURING CONSTRUCTION OPERATIONS. MOVE AND RELOCATE AS NEEDED TO COMPLETE ROOFING WORK.
- EXISTING SURFACE MOUNTED SATELLITE DISH AND LOOSE CABLE TO REMAIN IN-USE DURING CONSTRUCTION OPERATIONS, MOVE AND RELOCATE AS NEEDED TO COMPLETE ROOFING WORK.
- 5 EXISTING CONDUIT/EQUIPMENT WITH SURFACE MOUNTED PIPE SUPPORTS TO REMAIN, VERIFY IN FIELD.
- 6 EXISTING ROOF CURBS FOR PIPING SUPPORT, VERIFY EXACT QUANTITIES AND LOCATIONS. EXISTING FLASHING TO BE REMOVED AND REPLACED PER ROOFING MEMBRANE MANUFACTURER'S REQUIREMENTS.
- NEW CROSS-OVER STAIRS OVER EXISTING PIPING, SEE SECTION I ON SHEET A2. VERIFY EXACT LOCATION WITH OWNER PRIOR TO INSTALLATION.

ROOF PERIMETER KEY NOTES

- EXISTING E.J. BELLOWS TO REMAIN. RELEASE ONE HALF FOR REMOVAL AND REPLACEMENT OF ROOFING. REATTACH WITH NEW GASKETED FASTENERS. RESEAL JOINTS BETWEEN E.J. SECTIONS TO BE WATER TIGHT.
- EXISTING METAL COPING CAPS TO BE REMOVED AND SALVAGED. AFTER NEW ROOFING, REINSTALL COPING CAPS WITH NEW GASKETED FASTENERS.
- EXTEND NEW FLASHING UP WALL AND TERMINATE UNDER EXISTING METAL GRAVEL STOP. REMOVE AND REPLACE GRAVEL STOP AS NEEDED. V.I.F.
- EXISTING METAL COPING CAP SYSTEM TO BE REMOVED ENTIRELY. AFTER NEW ROOFING PROVIDE NEW COPING CAP SYSTEM, SEE SECTION 4 ON SHEET A2.
- EXISTING METAL COPING CAP SYSTEM TO BE REMOVED ENTIRELY. EXTEND NEW ROOFING FLASHING UP WALL AND UNDER EXISTING EPDM ROOFING TO REMAIN, SEAM WATER
- EXISTING E.J. BELLOWS TO BE REMOVED ENTIRELY. AFTER NEW ROOFING PROVIDE NEW E.J. BELLOWS WITH GASKETED FASTENERS.
- EXISTING METAL GRAVEL STOP AND E.J. BELLOWS TO BE REMOVED ENTIRELY. BUILD-UP PARAPET AND PROVIDE NEW E.J. BELLOWS, SEE SECTION 6 ON SHEET A2.
- (B) EXISTING METAL COPING CAP SYSTEM TO BE REMOVED ENTIRELY. PROVIDE NEW GRAVEL STOP INSTALLED WITH ROOFING, SEE SECTION 2 ON SHEET A2.
- EXISTING METAL COUNTERFLASHING TO BE REMOVED ENTIRELY. PROVIDE NEW GRAVEL STOP INSTALLED WITH ROOFING, SEE SECTION 5 ON SHEET A2.
- EXISTING METAL COUNTERFLASHING TO BE REMOVED ENTIRELY. AFTER NEW ROOFING PROVIDE NEW COUNTERFLASHING, SEE SECTION 5 ON SHEET A2.

S ■ □ □ 1311

マ 🔳

D I

REPL ROAD IS OFING PARTY HOUBOLT FILLINOIS | <u>|</u> | \(\) =


DATE: 1/20/2015


REVISED:

PROJECT NO. 1411-01


SHEET NUMBER


2 SHEETS

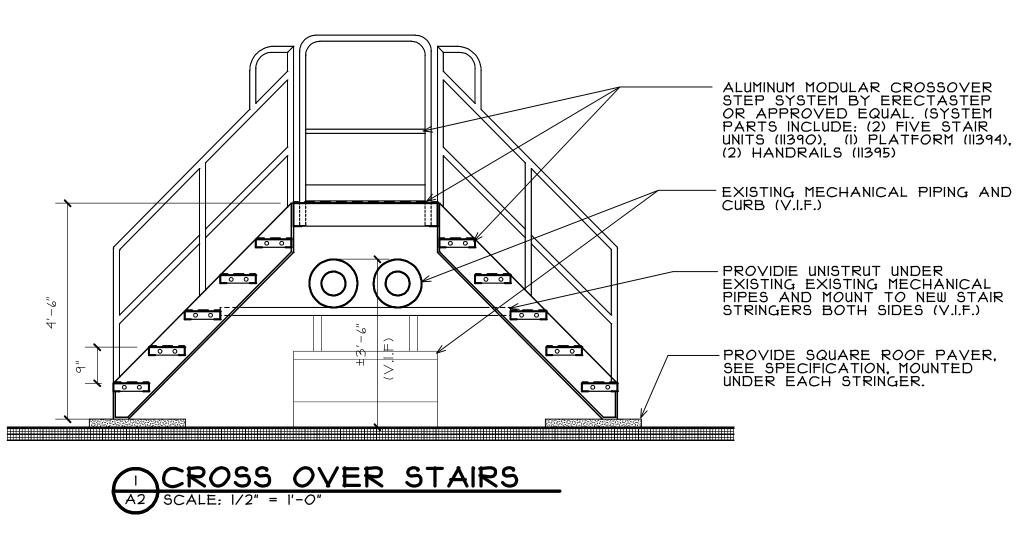

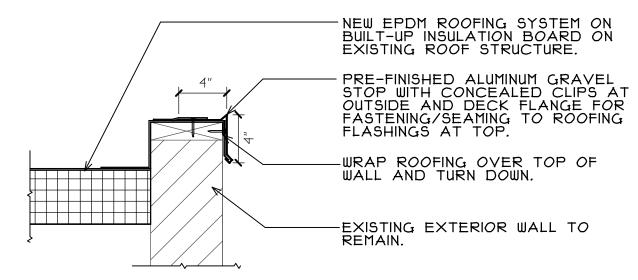




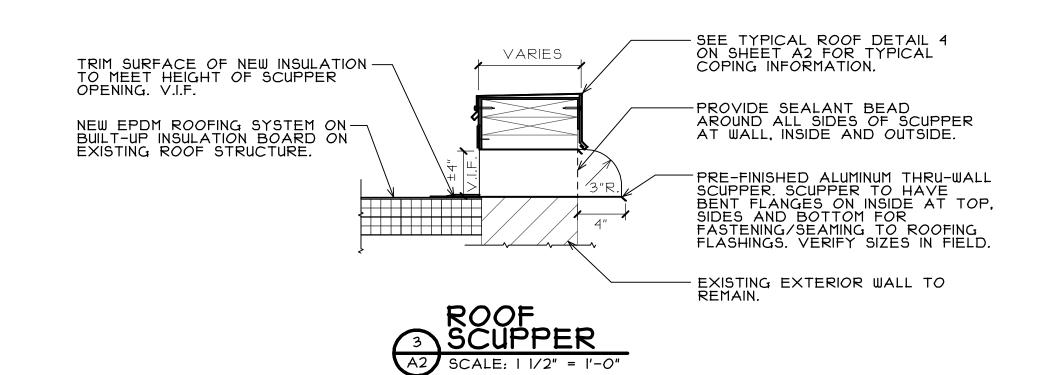

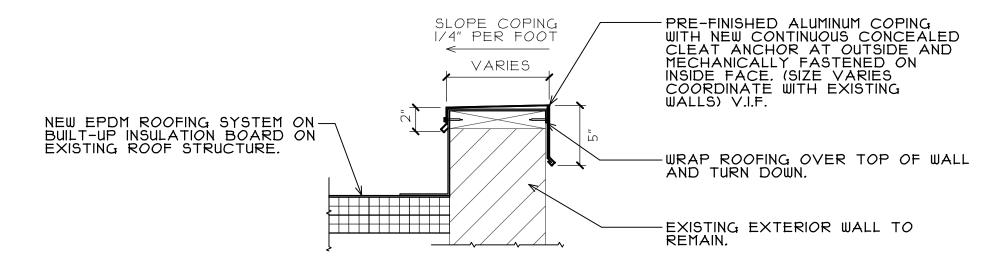



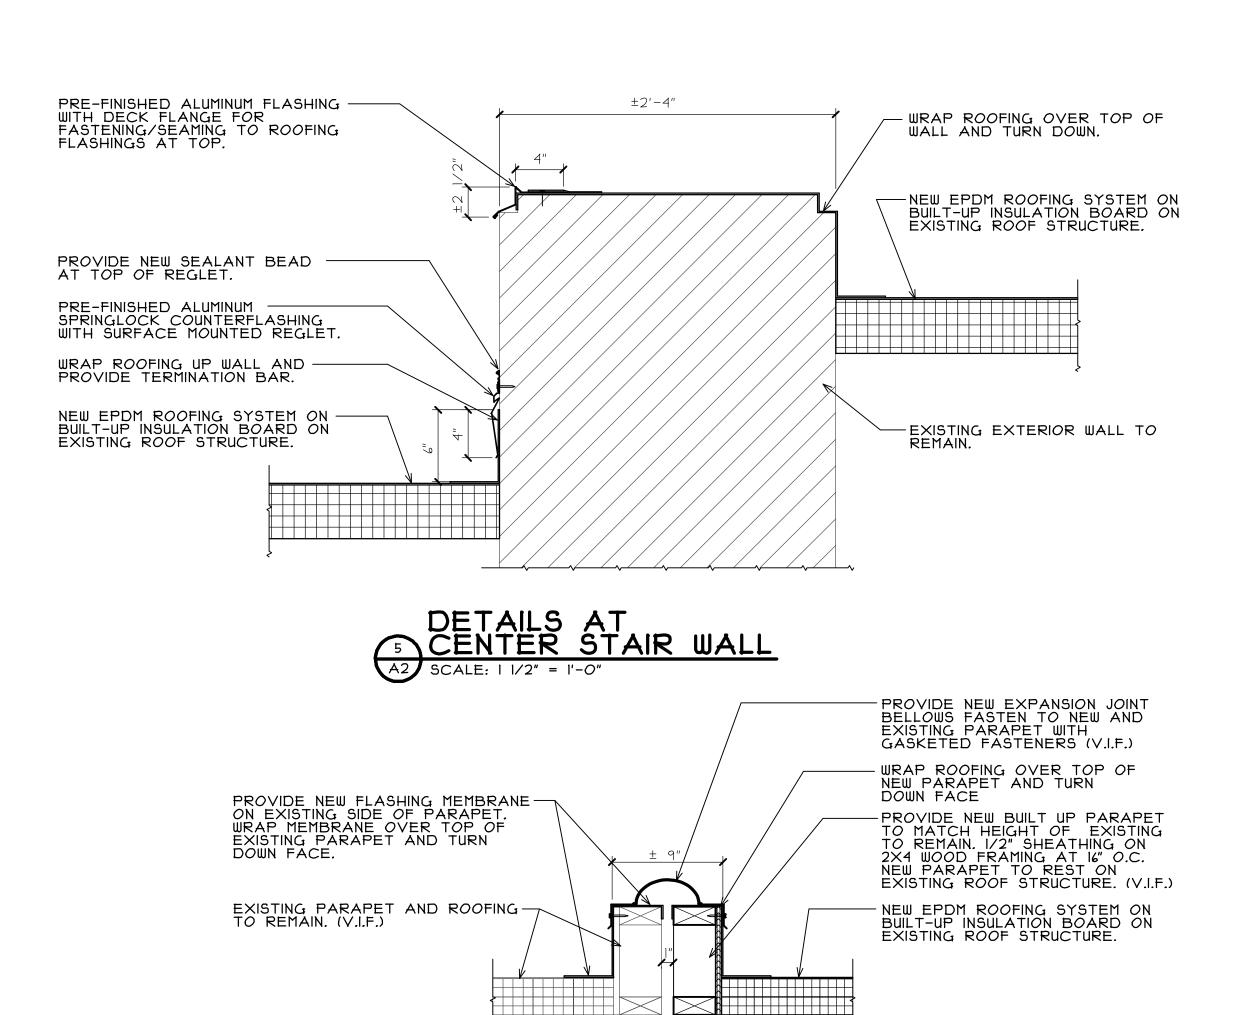

DETAIL AT
EXPANSION JOINT

SCALE: 1 1/2" = 1'-0"

SET

S ■ **C** 1311

young

Ŏ ■

ਰ ∎

sland

strol
AR

20620 Bu

ROOFING REPLACEMENT
JOLIET JUNIOR COLLEGE - BUILDING S
1215 HOUBOLT ROAD
JOLIET, ILLINOIS

DATE: 1/20/2015

REVISED:

PROJECT NO. 1411-01

SHEET NUMBER

A2
OF 2 SHEETS